

VIRGINIA RAILWAY EXPRESS

NORTHERN VIRGINIA TRANSPORTATION COMMISSION

POTOMAC AND RAPPAHANNOCK TRANSPORTATION COMMISSION

FHWA-534-STP-5A01 (236)

DEVELOPER

VIRGINIA RAILWAY EXPRESS
1500 KING STREET, SUITE 202
ALEXANDRIA, VA 22314
703-684-1001
gotrains@vire.org

NORINE M. WALKER, P.E., PROJECT MANAGER
703-838-5443
nwalker@vire.org

OWNER OF RECORD

CITY OF ALEXANDRIA
ALEXANDRIA CITY HALL
301 KING STREET
ALEXANDRIA, VA 22314
703-746-4500

PROJECT NARRATIVE

THE ALEXANDRIA PEDESTRIAN TUNNEL WILL CREATE A NEW UNDERGROUND PEDESTRIAN WALKWAY LINKING UNION STATION (EAST AND WEST PLATFORM) AND WMATA KING STREET STATION. THE PROJECT WILL REMOVE THE AT GRADE PEDESTRIAN CROSSING OF CSX TRACKS TO ACCESS THE EAST PLATFORM. PROVIDE ADA ACCESSIBILITY INCLUDING ELEVATOR SERVICE FOR ALL RAIL PASSENGERS, AND PROVIDE A DIRECT LINK BETWEEN THE WMATA KING STREET STATION MEZZANINE LEVEL AND UNION STATION. THE PROJECT ALSO INCLUDES AN EXTENSION AND WIDENING OF THE EAST PLATFORM FOR INCREASED PASSENGER SERVICE AND ACCESS TO TRACK 1. THE PROPOSED IMPROVEMENTS WILL ADDRESS CURRENT PUBLIC SAFETY CONCERNS AND GREATLY INCREASE CUSTOMER CONVENIENCE FOR RAIL PASSENGERS UTILIZING RAIL TRANSPORTATION IN THE AREA. THIS SUBMITTAL IS FOR A REQUEST FOR APPROVAL OF THE FINAL DEVELOPMENT SITE PLAN.

ZONING TABULATION


PROPERTY ADDRESS: 110 CALLAHAN DRIVE, ALEXANDRIA, VA 22301
ZONE: UT (UTILITY AND TRANSPORTATION)
EXISTING USE: RAIL STATION
PROPOSED USE: RAIL STATION
TAX PARCEL AREA: 147,962 SQUARE FEET (3.3967 ACRES)
EXISTING IMPERVIOUS AREA: 77701.48 SQUARE FEET (1.78 ACRES)
PROPOSED IMPERVIOUS AREA: 2263.26 SQUARE FEET (0.05 ACRES)
LIMIT OF DISTURBANCE: 6247.55 SQUARE FEET (0.14 ACRES)
GROSS BUILDING AREA (PROPOSED): 0 SQUARE FEET (NO PROPOSED BUILDINGS)

PERMITS / APPROVALS REQUESTED

STORMWATER MANAGEMENT

EXISTING PERMITS / APPROVALS

NONE

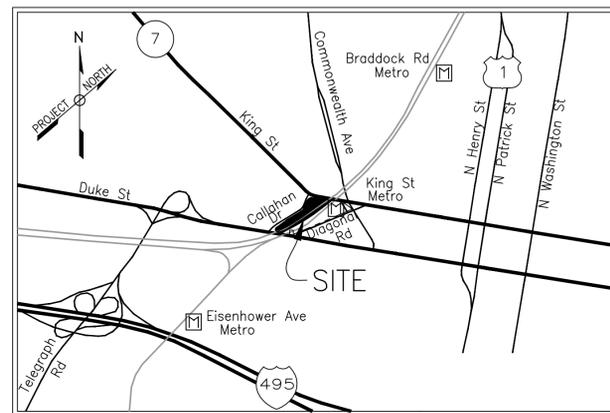

PARCEL (INST.) #0000 24586
TAX MAP #073.01-03-04

VICINITY MAP

NOT TO SCALE

BUILDING CODE ANALYSIS

1. APPLICABLE CODES

BUILDING CODE: 2012 VIRGINIA UNIFORM CONSTRUCTION CODE
PLUMBING CODE: 2012 INTERNATIONAL PLUMBING CODE
ELECTRICAL CODE: 2011 NATIONAL ELECTRICAL CODE (NFPA 70)
MECHANICAL CODE: 2012 INTERNATIONAL MECHANICAL CODE
ENERGY SUBCODE: 2012 INTERNATIONAL ENERGY CONSERVATION CODE
FIRE ALARM CODE: 2013 NFPA 72 NATIONAL FIRE ALARM CODE
FIRE PREVENTION CODE: 2014 NFPA 130 STANDARD FOR FIXED GUIDEWAY TRANSIT AND PASSENGER RAIL SYSTEMS
ACCESSIBILITY CODE: ACCESSIBLE AND USEABLE BUILDINGS AND FACILITIES - ICC A117.1-2009

2. BUILDING DESCRIPTION (IBC TABLE 503):

CONSTRUCTION TYPE: 2B
USE GROUP: U (UTILITY)
ALLOWABLE TABULAR AREA: 35,500 SF
ACTUAL AREA: 15,836 SF
EAST PLATFORM AREA: 6,900 SF
CANOPY (INCLUDED IN PLATFORM AREA): 5 STORY
ALLOWABLE HEIGHT: 5 STORY
ACTUAL HEIGHT: 1 STORY

3. PLATFORM OCCUPANCY CALCULATION (NFPA 130):

AREA NAME	OCCUPANT LOAD
EAST PLATFORM	1194

4. OCCUPANCY AND EGRESS:

NUMBER OF OCCUPANTS:
ENTRAINING LOAD
TRACK 1: 19
TRACK 2: 95
DETRAINING LOAD: 1080
TOTAL EAST PLATFORM OCCUPANCY: 1194
SAFE DISPERSAL AREA: 398
REQUIRED AREA: 5 SF/PERSON (STANDING)xOCC. = 1,990 SF
NEW STAIR: 424
EXISTING STAIR: 372
TOTAL STAIR LOAD: 796
MINIMUM REQUIRED STAIR WIDTH:
(OCC./4 MINUTES/1.41 people/inch/minute): 142 INCHES
TOTAL STAIR WIDTH PROVIDED: 150 INCHES
MAXIMUM TRAVEL DISTANCE ON PLATFORM: 325 FT
LONGEST ROUTE ON PLATFORM: 240 FT

5. FIRE SUPPRESSION:

ELEVATOR TOWERS- CHEMICAL SYSTEM

APPROVED
SPECIAL USE PERMIT NO.
DEPARTMENT OF PLANNING & ZONING

DIRECTOR _____ DATE _____
DEPARTMENT OF TRANSPORTATION & ENVIRONMENTAL SERVICES
SITE PLAN NO. DSP2011-0027

DIRECTOR _____ DATE _____

CHAIRMAN, PLANNING COMMISSION _____ DATE _____

DATE RECORDED _____
INSTRUMENT NO. _____ DEED BOOK NO. _____ PAGE NO. _____

DATUM:
(HZ) NAD 83
(VT) NAVD 88

60% SUBMITTAL
MAY, 2016

PROFESSIONAL CERTIFICATION

I HEREBY CERTIFY THAT THESE DOCUMENTS WERE PREPARED OR APPROVED BY ME, AND THAT I AM A DULY LICENSED PROFESSIONAL ENGINEER UNDER THE LAWS OF THE COMMONWEALTH OF VIRGINIA.
LICENSE NUMBER _____
EXPIRATION DATE: _____



VIRGINIA RAILWAY EXPRESS

ALEXANDRIA
PEDESTRIAN TUNNEL

DISCIPLINE:
GENERAL
DEVELOPMENT SITE PLAN
COVER SHEET

SCALE: NONE DATE ISSUED: 6/20/16

60% SUBMITTAL

DRAWING NO:

G-002

LIST NO:

CONTRACT NO:		REVISIONS			
PROJECT NO:	DATE:	BY	NO	DATE	DESCRIPTION
		GF	001		DEV. CONCEPT PLAN (30%)
		GF	002	6/20/16	DEV. SITE PLAN
DESIGNED:					
DRAFTED:					
CHECKED:					
APPROVED:					

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APPROVED		
SPECIAL USE PERMIT NO.		
<small>DEPARTMENT OF PLANNING & ZONING</small>		
<small>DIRECTOR</small>	<small>DATE</small>	
<small>DEPARTMENT OF TRANSPORTATION & ENVIRONMENTAL SERVICES</small>		
SITE PLAN NO. DSP2011-0027		
<small>DIRECTOR</small>	<small>DATE</small>	
<small>CHAIRMAN, PLANNING COMMISSION</small>		
<small>DATE RECORDED</small>		
<small>INSTRUMENT NO.</small>	<small>DEED BOOK NO.</small>	<small>PAGE NO.</small>

60% SUBMITTAL

CONTRACT NO:		REVISIONS	
PROJECT NO:	BY	NO	DATE
	GF	001	
	GF	002	6/20/16
DATE:	DESCRIPTION		
	DEV. CONCEPT PLAN (30%)		
	DEV. SITE PLAN		
DESIGNED: IA			
DRAFTED: LTN			
CHECKED: MA/DB			
APPROVED:			



VIRGINIA RAILWAY EXPRESS

ALEXANDRIA
PEDESTRIAN TUNNEL

DISCIPLINE:		DRAWING NO:
GENERAL DRAWING INDEX		G-003
SCALE:		LIST NO:
NONE	DATE ISSUED:	
	6/20/16	

GENERAL NOTES

- 1.) THE PROPERTIES SHOWN ARE IDENTIFIED AS THE CITY OF ALEXANDRIA, VIRGINIA TAX MAP NUMBERS 073.01-03-03 AND 073.01-03-04 AND ARE ZONED UT.
- 2.) THE PROPERTIES SHOWN HEREON ARE IN THE NAME OF CSX TRANSPORTATION, INC. (073.01-03-03) BY INSTRUMENT NUMBER 060019238, AND THE CITY OF ALEXANDRIA (073.01-03-04) BY INSTRUMENT NUMBER 000024586, ALL AMONG THE LAND RECORDS OF THE CITY OF ALEXANDRIA, VIRGINIA.
- 3.) THE PHYSICAL IMPROVEMENTS SHOWN HEREON ARE BASED UPON A FIELD SURVEY DONE BY THIS FIRM BETWEEN THE DATES OF JANUARY 2, 2015 AND APRIL 11, 2015.
- 4.) THE BOUNDARY SHOWN HEREON IS BASED UPON A FIELD SURVEY DONE BY THIS FIRM BETWEEN THE DATES OF FEBRUARY 23 AND 24, 2000 AND AVAILABLE DEEDS AND PLATS OF RECORD.
- 5.) NO TITLE REPORT FURNISHED. ALL UNDERLYING TITLE LINES, EASEMENTS, SERVITUDES AND OTHER MATTERS OF TITLE MAY NOT BE SHOWN HEREON.
- 6.) A.) HORIZONTAL DATUM SHOWN HEREON IS REFERENCED TO THE VIRGINIA STATE GRID NORTH (NAD83) AS ESTABLISHED BY A CURRENT GPS FIELD SURVEY.
B.) THE VERTICAL DATUM SHOWN HEREON IS REFERENCED TO THE NORTH AMERICAN VERTICAL DATUM OF 1988 (NAVD 88) AS ESTABLISHED BY A CURRENT GPS FIELD SURVEY.
- 7.) NO GEOTECHNICAL, SUBSURFACE, FIELD REVIEWS, RESEARCH, AGENCY OR GOVERNMENTAL RECORD REVIEWS, OR OTHER INVESTIGATIONS HAVE BEEN MADE FOR THE PURPOSE OF LOCATING, OR DETERMINING THE EXISTENCE OF WETLANDS, HAZARDOUS MATERIALS, OR OTHER ENVIRONMENTAL CONCERNS ON SITE IN THE PERFORMANCE OF CHRISTOPHER CONSULTANTS, LTD SERVICES FOR THE PROJECT AS SHOWN HEREON.

FLOOD ZONE NOTE



THE PROPERTIES SHOWN HEREON ARE LOCATED ON THE FLOOD INSURANCE RATE MAP (FIRM), COMMUNITY PANEL NO. 51519 0037E AND 51519 0041E, REVISED ON JUNE 16, 2001.

BY GRAPHIC DEPICTION ONLY, THE PROPERTY SHOWN HEREON IS SHOWN IN:
• FLOOD ZONE "X", AREAS DETERMINED TO BE OUTSIDE THE 0.2% ANNUAL CHANCE FLOODPLAIN.

A FIELD SURVEY WAS NOT PERFORMED TO DETERMINE THE FLOOD ZONES LISTED HEREON. AN ELEVATION CERTIFICATE MAY BE NEEDED TO VERIFY THIS DETERMINATION OR APPLY FOR A VARIANCE FROM THE FEDERAL EMERGENCY MANAGEMENT AGENCY.

BENCHMARK
PK NAIL SET
N: 6, 920, 163.61
E: 11, 892, 518.39
ELEVATION=26.36

BENCHMARK
SPIKE SET
N: 6, 979, 993.76
E: 11, 892, 484.67
ELEVATION=33.30

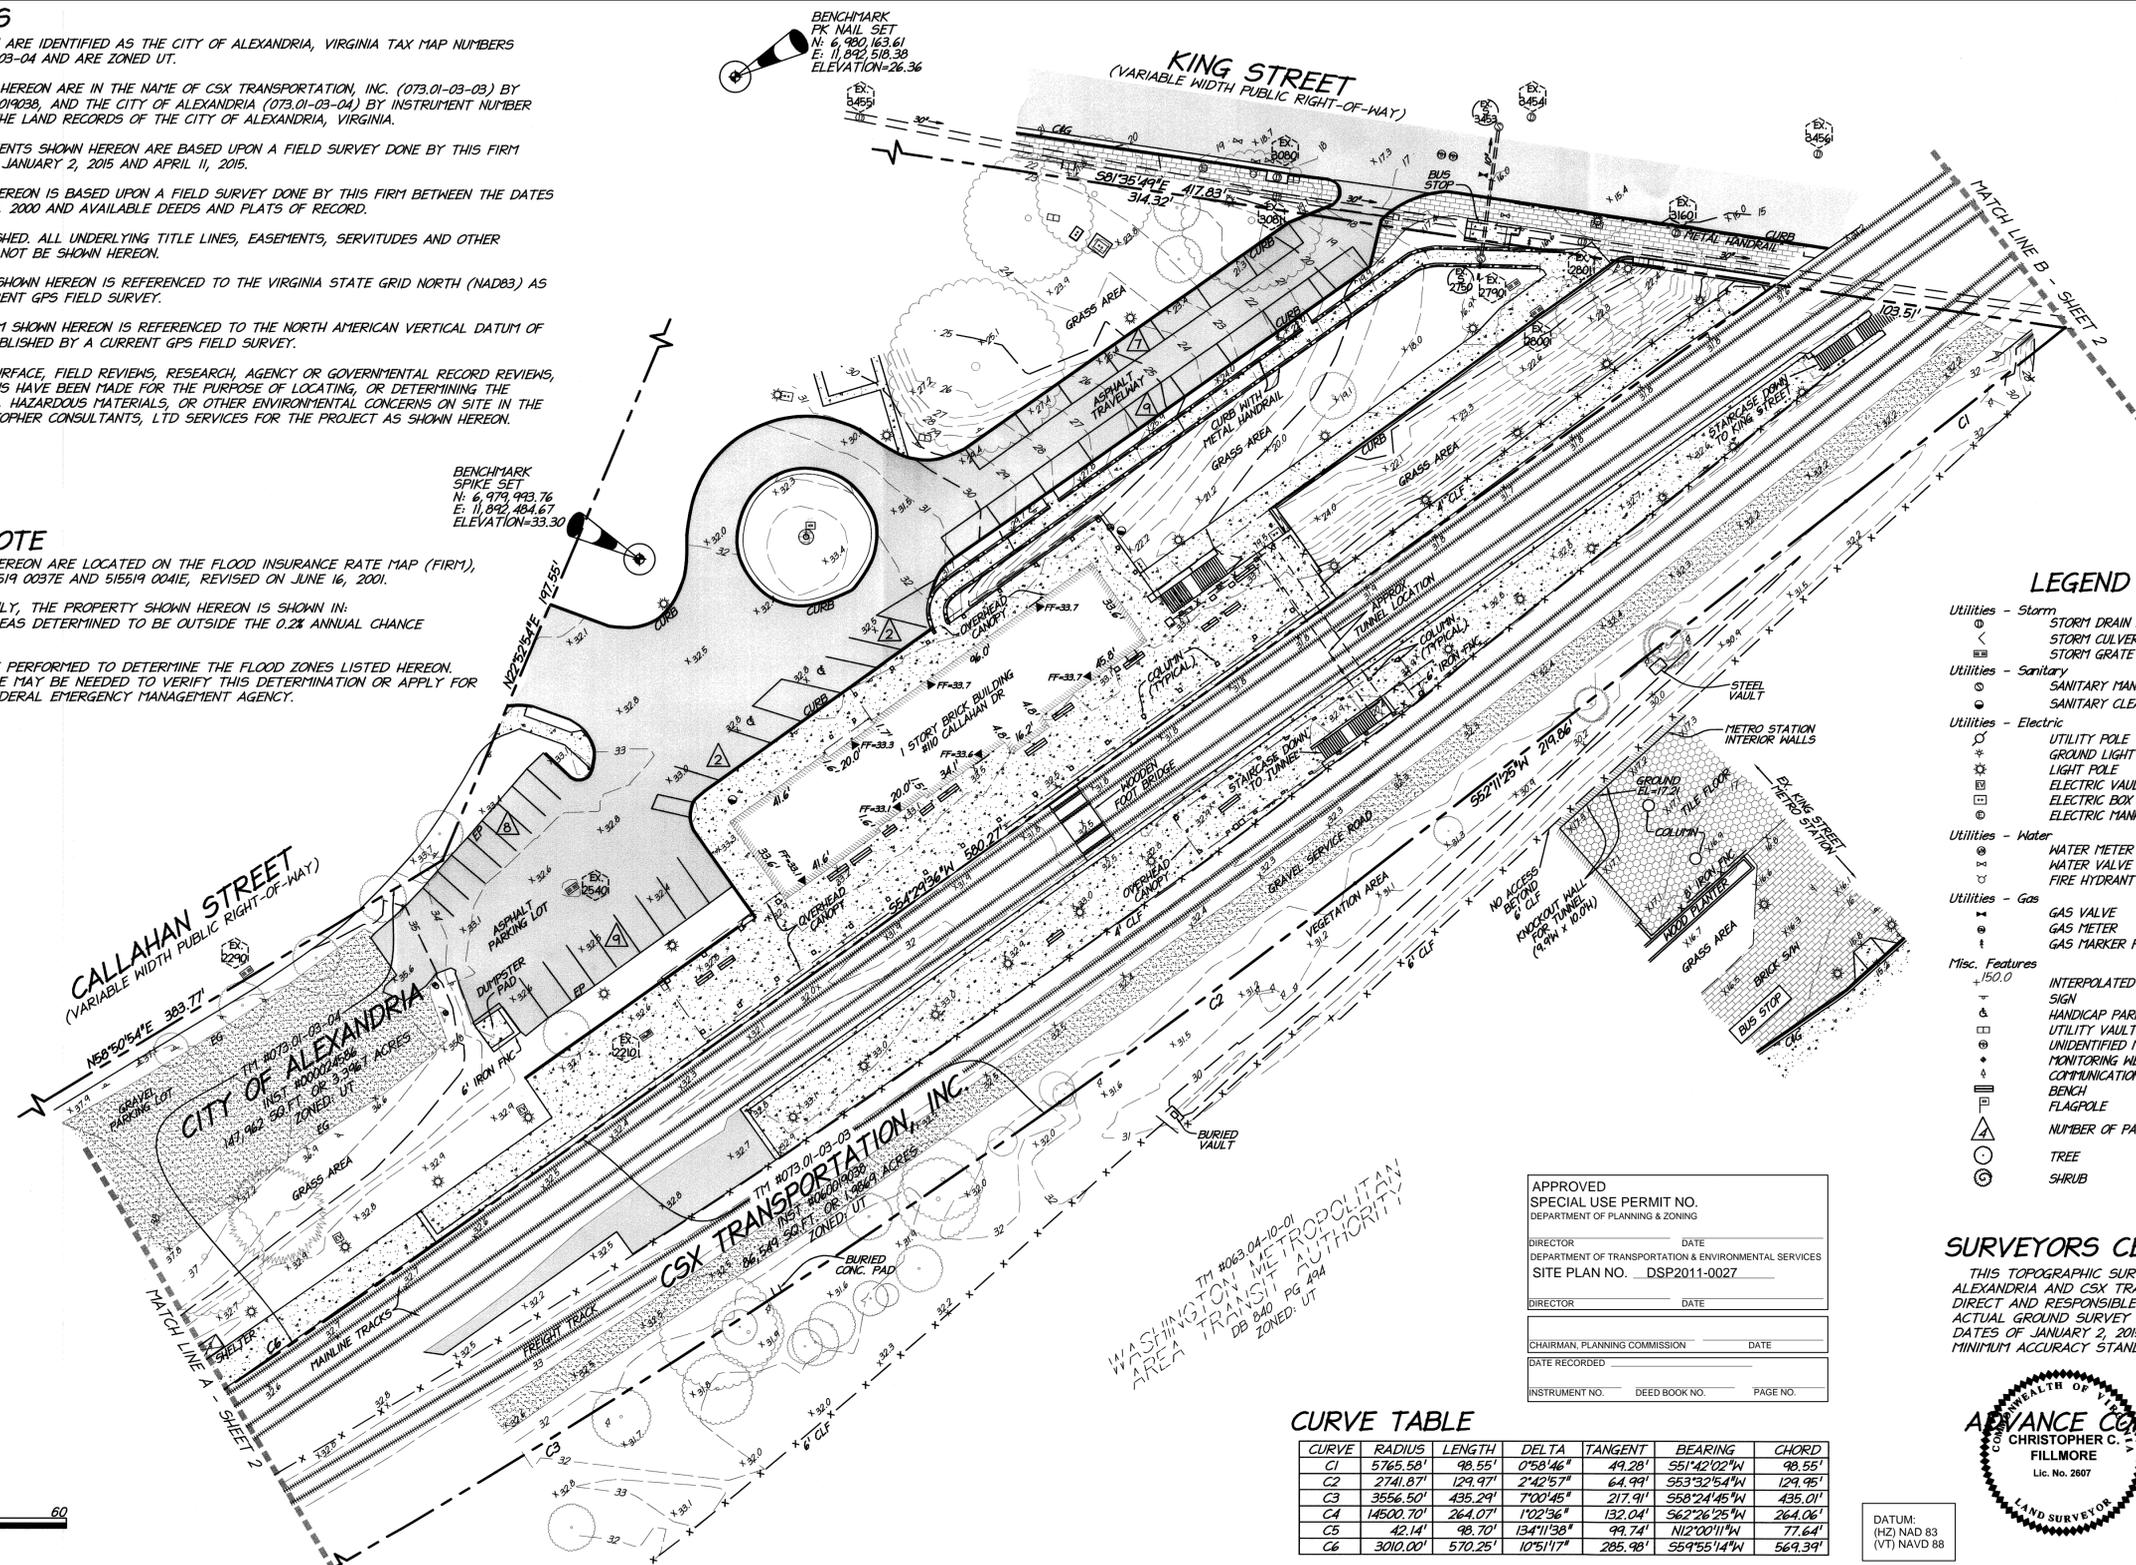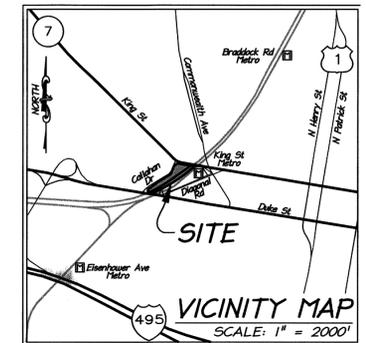

LEGEND

- Utilities - Storm**
STORM DRAIN MANHOLE
STORM CULVERT
STORM GRATE
- Utilities - Sanitary**
SANITARY MANHOLE
SANITARY CLEANOUT
- Utilities - Electric**
UTILITY POLE
GROUND LIGHT
LIGHT POLE
ELECTRIC VAULT
ELECTRIC BOX
ELECTRIC MANHOLE
- Utilities - Water**
WATER METER
WATER VALVE
FIRE HYDRANT
- Utilities - Gas**
GAS VALVE
GAS METER
GAS MARKER POST
- Misc. Features**
+150.0 INTERPOLATED SPOT SHOT
SIGN
HANDICAP PARKING SPACE
UTILITY VAULT
UNIDENTIFIED MANHOLE
MONITORING WELL
COMMUNICATION MARKER POST
BENCH
FLAGPOLE
NUMBER OF PARKING SPACES
TREE
SHRUB
- Surfaces**
ASPHALT AREA
CONCRETE AREA
GRAVEL AREA
- Linetypes**
INDEX CONTOUR (5')
INT. CONTOUR (1')
FENCE
DHU
OVERHEAD UTILITY LINE
RAIL LINE
- Abbreviations**
EP EDGE OF PAVEMENT
EG EDGE OF GRAVEL
C&G CURB & GUTTER
FNC FENCE
CLF CHAIN LINK FENCE

APPROVED
SPECIAL USE PERMIT NO.
DEPARTMENT OF PLANNING & ZONING

DIRECTOR _____ DATE _____
DEPARTMENT OF TRANSPORTATION & ENVIRONMENTAL SERVICES
SITE PLAN NO. DSP2011-0027

DIRECTOR _____ DATE _____

CHAIRMAN, PLANNING COMMISSION _____ DATE _____

DATE RECORDED _____

INSTRUMENT NO. _____ DEED BOOK NO. _____ PAGE NO. _____

CURVE TABLE

CURVE	RADIUS	LENGTH	DELTA	TANGENT	BEARING	CHORD
C1	5765.58'	98.55'	0°58'46"	49.28'	S51°42'02"W	98.55'
C2	2741.87'	129.97'	2°42'57"	64.99'	S53°32'54"W	129.95'
C3	3556.50'	435.29'	7°00'45"	217.91'	S58°24'45"W	435.01'
C4	14500.70'	264.07'	1°02'36"	132.04'	S62°26'25"W	264.06'
C5	42.14'	98.70'	134°11'38"	99.74'	N12°00'11"W	77.64'
C6	3010.00'	570.25'	10°51'17"	285.98'	S59°55'14"W	569.39'

SURVEYORS CERTIFICATION

THIS TOPOGRAPHIC SURVEY ON A PORTION OF LANDS OF THE CITY OF ALEXANDRIA AND CSX TRANSPORTATION, INC. WAS COMPLETED UNDER THE DIRECT AND RESPONSIBLE CHARGE OF CHRISTOPHER C. FILLMORE FROM AN ACTUAL GROUND SURVEY MADE UNDER MY SUPERVISION, BETWEEN THE DATES OF JANUARY 2, 2015 AND APRIL 11, 2015 AND THAT THIS PLAT MEETS MINIMUM ACCURACY STANDARDS UNLESS OTHERWISE NOTED.



CHRISTOPHER C. FILLMORE
COMMONWEALTH OF VIRGINIA
LICENSED LAND SURVEYOR NO. : 2807

DATUM:
(HZ) NAD 83
(VT) NAVD 88

60% SUBMITTAL

CONTRACT NO:	REVISIONS		
PROJECT NO:	BY	NO	DATE
DESIGNED:	GF	001	DATE
DRAFTED:	GF	002	6/20/16
CHECKED:			
APPROVED:			





VIRGINIA RAILWAY EXPRESS
ALEXANDRIA
PEDESTRIAN TUNNEL

DISCIPLINE:	DRAWING NO:
CIVIL SURVEY PLAN 1	G-004
SCALE:	LIST NO:
NONE	
DATE ISSUED:	
6/20/16	

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STORM AND SANITARY ASBUILTS

- EX- ST1 2290
TOP=34.88
- EX- ST1 2122
TOP=32.79
FULL OF VEGETATION
- EX- ST1 2210
TOP=32.50
- EX- ST1 2540
TOP=31.71
- EX- ST1 2800
TOP=16.44
FULL OF SILT
- EX- ST1 2790
TOP=16.04
FULL OF SILT
- EX- ST1 3455
TOP=23.47
INV OUT=16.62(30° TO 3081)
- EX- ST1 3081
TOP=18.74
- EX- ST1 2801
TOP=16.06
INV IN=9.5(30° FR 3081)
INV OUT=9.4(30° TO 3452)
- EX- ST1 3452
TOP=14.16
INV IN=7.96(30° FR 2801)
INV OUT=7.76(30° TO E)
- EX- ST1 3080
TOP=18.56
- EX- ST1 3454
TOP=15.70
NOT ACCESSIBLE AT TIME OF SURVEY
- EX- ST1 3160
TOP=15.52
- EX- ST1 3456
TOP=15.06
NOT ACCESSIBLE AT TIME OF SURVEY
- SAN 2750
TOP=16.99
INV IN=10.07(6° FR 541)
INV OUT=9.94(10° TO 3453)
- SAN 3453
TOP=16.08
NOT ACCESSIBLE AT TIME OF SURVEY

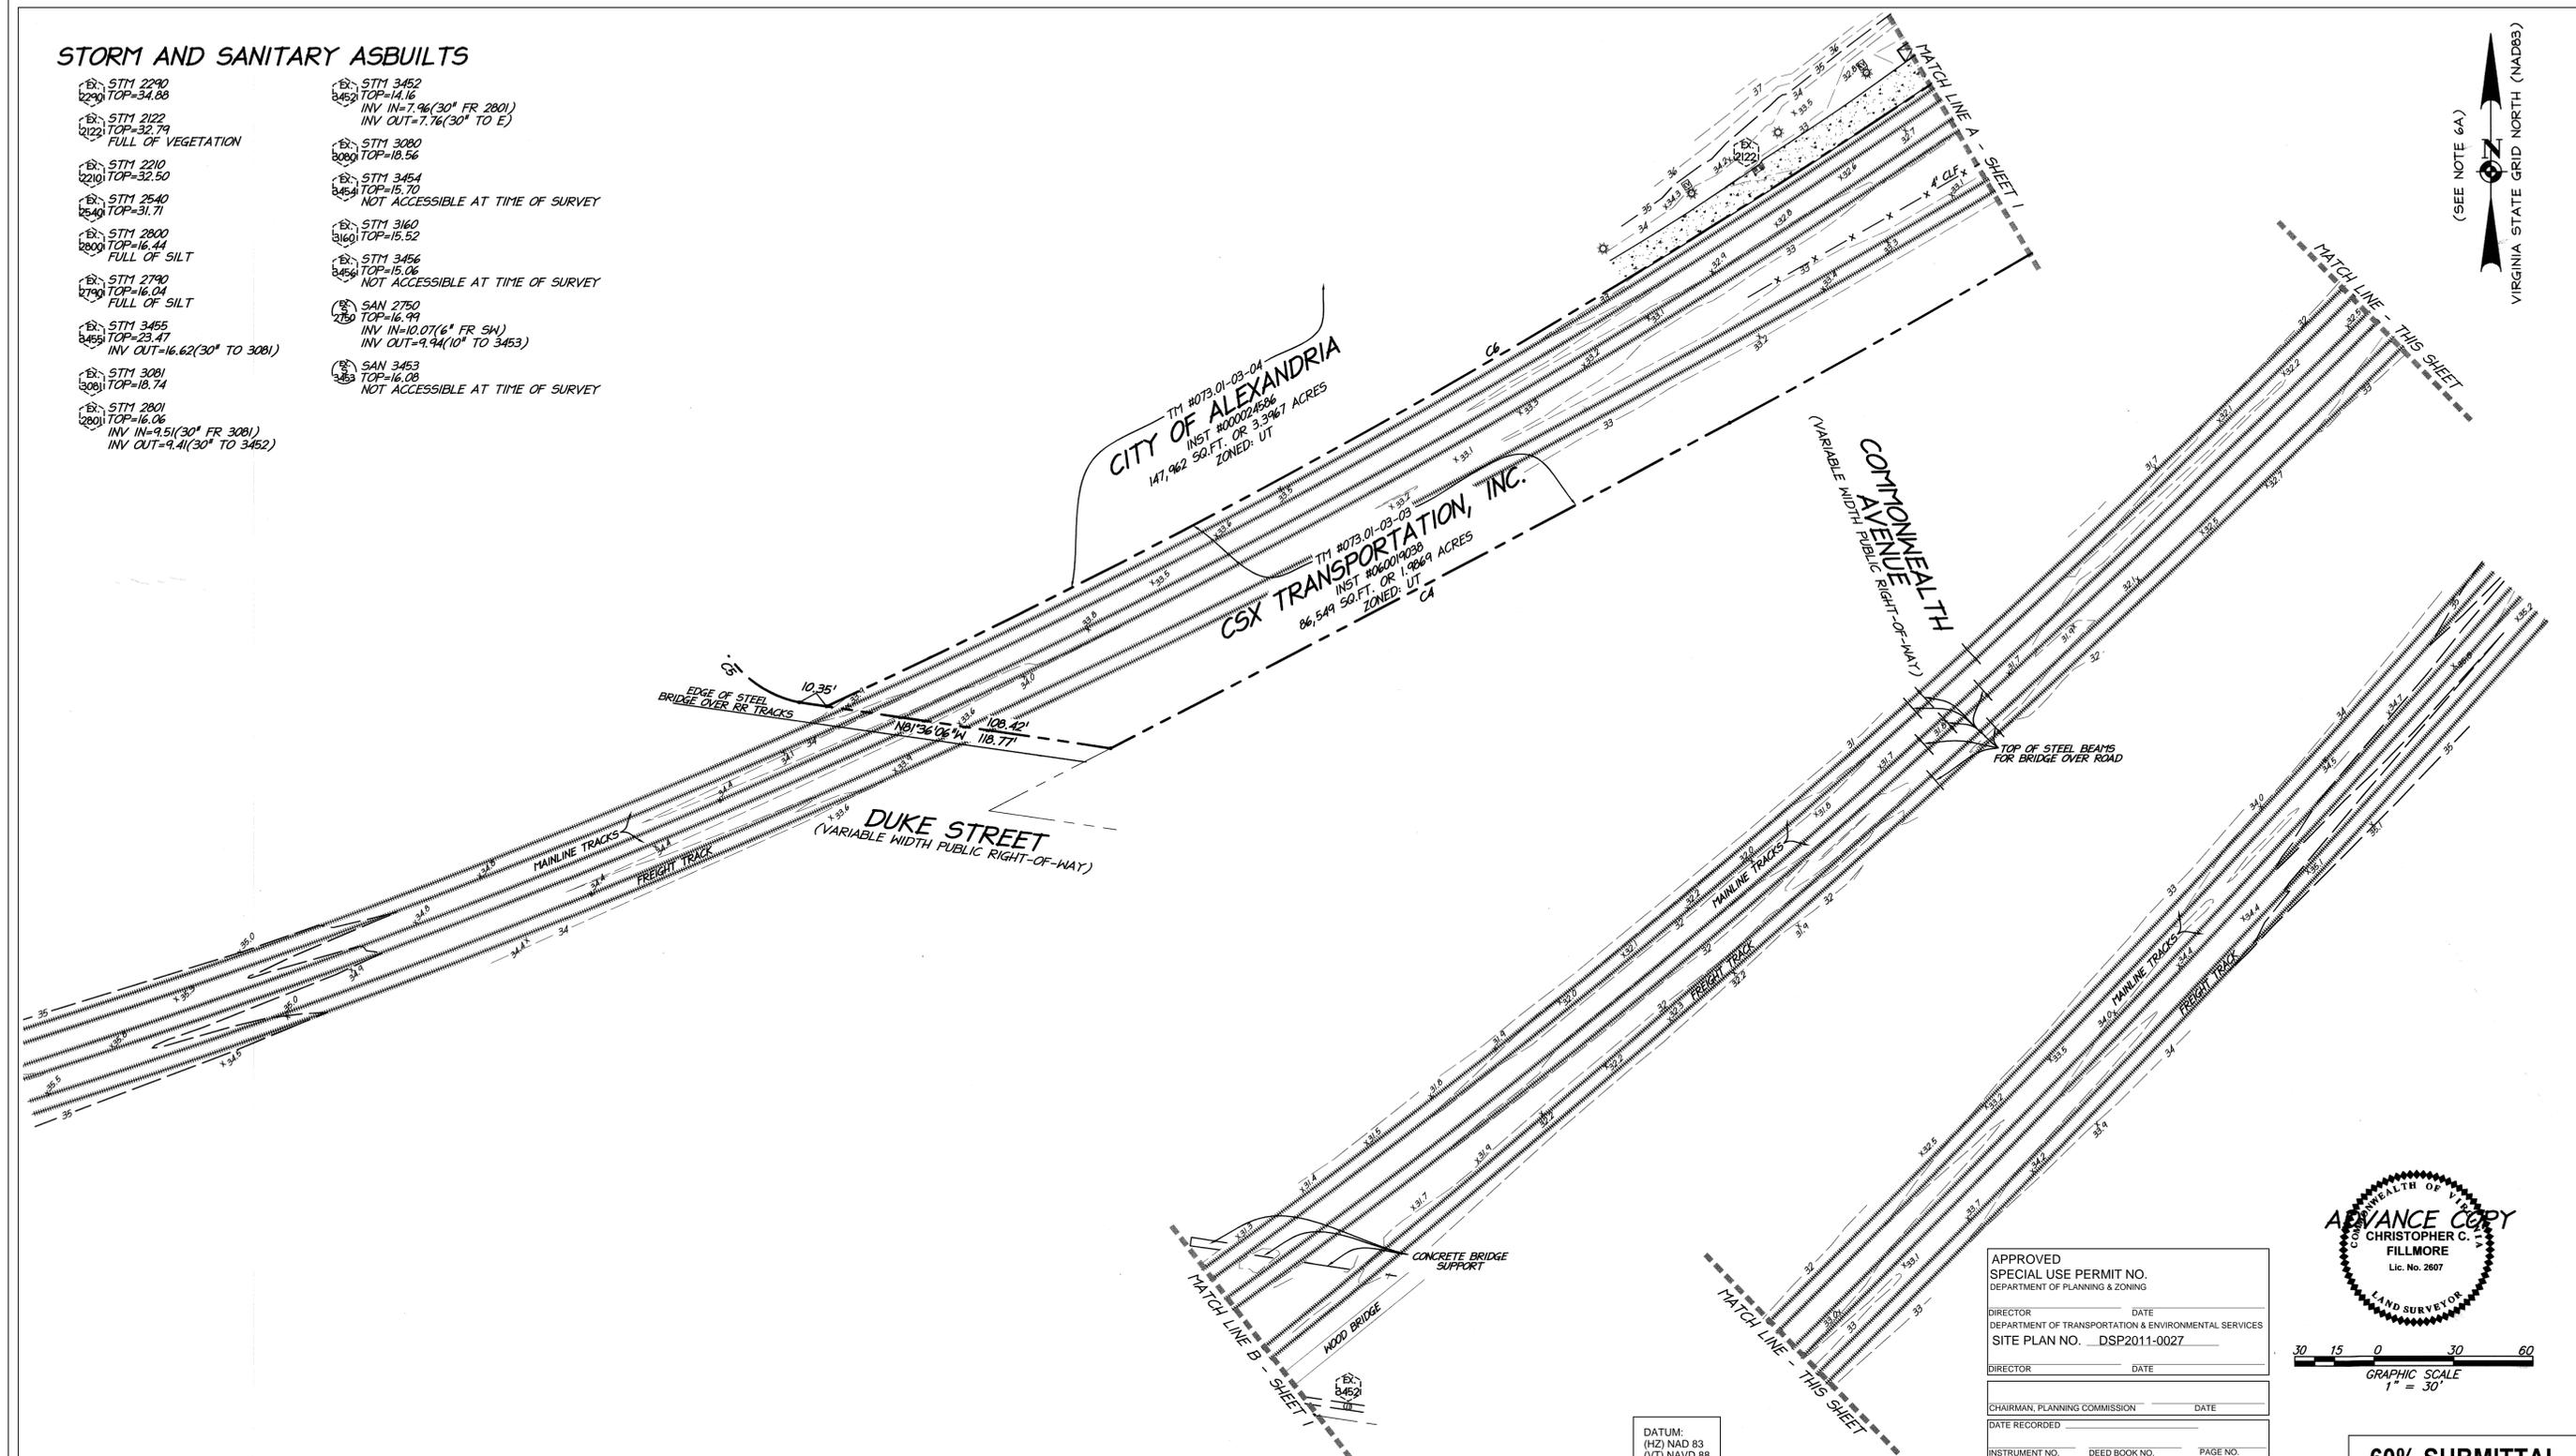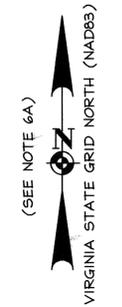

APPROVED
SPECIAL USE PERMIT NO. _____
DEPARTMENT OF PLANNING & ZONING


DIRECTOR _____ DATE _____
DEPARTMENT OF TRANSPORTATION & ENVIRONMENTAL SERVICES
SITE PLAN NO. DSP2011-0027

DIRECTOR _____ DATE _____

CHAIRMAN, PLANNING COMMISSION _____ DATE _____

DATE RECORDED _____

INSTRUMENT NO. _____ DEED BOOK NO. _____ PAGE NO. _____

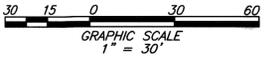

60% SUBMITTAL

CONTRACT NO:	REVISIONS		
PROJECT NO:	BY	NO	DATE
DESIGNED:	GF	001	
DRAFTED:	GF	002	6/20/16
CHECKED:			
APPROVED:			



VIRGINIA RAILWAY EXPRESS
**ALEXANDRIA
PEDESTRIAN TUNNEL**

DISCIPLINE:
**CIVIL
SURVEY PLAN 2**

SCALE: NONE DATE ISSUED: 6/20/16

DRAWING NO:
G-005

LIST NO:

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CITY STANDARD GENERAL NOTES

- THE SUBJECT SITE IS LOCATED ON CITY OF ALEXANDRIA, VIRGINIA TAX MAP NUMBERS 073.01-03-03 AND 073.01-03-04 AND IS ZONED UT.
- OWNER: CITY OF ALEXANDRIA.
- DEED BOOK ____ PAGE ____, DEED BOOK ____ PAGE ____
- 110 CALLAHAN DRIVE, ALEXANDRIA, VA
- AREA TABULATION (TOTAL SITE AREA 3.40 AC (147,962 SF), CONSTRUCTION AREA 0.14 AC (6248 SF), DISTURBED AREA 0.14 AC (6248 SF), EXISTING IMPERVIOUS 1.78 AC (77701 SF), PROPOSED IMPERVIOUS 0.05 AC (2263 SF)
- THE NATURAL SOILS AT THE SITE CONSIST OF URBAN LAND AND URBAN LAND-GRIST MILL. SOIL INFORMATION OBTAINED FROM NATURAL RESOURCES CONSERVATION SERVICE, WEB SOIL SURVEY NATIONAL COOPERATIVE SOIL SURVEY.
- THE SITE IS LOCATED IN THE TIMBER BRANCH WATERSHED.
- CONSTRUCTION PERMITS ARE REQUIRED FOR THIS PROJECT. THE APPROVED SITE PLAN MUST BE ATTACHED TO THE PERMIT APPLICATION THAT FULLY DETAILS THE CONSTRUCTION AS WELL AS LAYOUTS AND SCHEMATICS OF THE MECHANICAL, ELECTRICAL, AND PLUMBING SYSTEMS.
- ALL PUBLIC AND PRIVATE EASEMENTS OR ALL KNOWN PUBLIC AND PRIVATE EASEMENTS, INCLUDING ALL UTILITY, EGRESS, AND CONSERVATION RESTRICTIONS ARE SHOWN. THE APPLICANT SHALL NOT CONSTRUCT ANY PERMANENT STRUCTURES OVER ANY EXISTING OR PROPOSED PUBLIC AND/OR PRIVATE EASEMENTS UNLESS OTHERWISE APPROVED BY THE PLANNING COMMISSION AND CITY OF ALEXANDRIA COUNCIL.
- PLAT SUBJECT TO RESTRICTIONS OF RECORD.
- BUILDING HEIGHT SHALL NOT EXCEED THE ALLOWABLE LIMIT BY CITY OF ALEXANDRIA ZONING ORDINANCE OR AS APPROVED BY THE PLANNING COMMISSION AND CITY OF ALEXANDRIA COUNCIL.
- ALL NEW CONSTRUCTION SHALL CONFORM TO THE CURRENT STANDARDS AND SPECIFICATIONS OF THE CITY OF ALEXANDRIA AND TO THE VIRGINIA UNIFORM STATEWIDE BUILDING CODE (USBC).
- FLOOR AREA CALCULATIONS WITH ALLOWABLE LIMITS, AS APPROVED BY PLANNING COMMISSION AND CITY COUNCIL, ARE DEMONSTRATED HEREIN.
- PRIOR TO COMMENCING NEW WORK, THE CONTRACTOR SHALL PROTECT FROM DAMAGE ALL EXISTING ADJACENT AREAS. IF CITY'S EXISTING PUBLIC INFRASTRUCTURE, INCLUDING BUT NOT LIMITED, TO STREETS, ALLEYS, DRIVEWAY APRONS, SANITARY AND STORM SEWERS, STREET LIGHTING, TRAFFIC AND PEDESTRIAN SIGNALS, SIDEWALKS, CURB AND GUTTER, AND STORM WATER DROP INLET STRUCTURES ARE DAMAGED BY THE CONTRACTOR OR BY ACTIVITIES RELATING TO THE SITE CONSTRUCTION THEN THE APPLICANT SHALL REPAIR THE SAME TO THE SATISFACTION OF DIRECTOR, TRANSPORTATION AND ENVIRONMENTAL SERVICES (T&ES). A PRE-CONSTRUCTION WALK/SURVEY OF THE SITE SHALL OCCUR WITH CONSTRUCTION AND INSPECTION STAFF TO DOCUMENT EXISTING CONDITIONS PRIOR TO ANY LAND DISTURBING ACTIVITY.
- ALL IMPROVEMENTS TO THE CITY'S RIGHT-OF-WAY SUCH AS CURB, GUTTER, SIDEWALK, AND DRIVEWAY APRONS, ETC., ARE DESIGNED PER THE CITY OF ALEXANDRIA STANDARDS AND SPECIFICATIONS.
- ALL STREET CUT AND PATCH WORK LOCATED IN PUBLIC RIGHT-OF-WAYS, REQUIRED FOR ANY UTILITY INSTALLATION SHALL BE PERFORMED IN STRICT ACCORDANCE WITH THE CITY OF ALEXANDRIA STANDARDS AND SPECIFICATIONS AND TO THE SATISFACTION OF THE DIRECTOR OF TRANSPORTATION AND ENVIRONMENTAL SERVICES (T&ES).
- CONTRACTOR MUST ENSURE THAT THERE IS NO DISTURBANCE ON ADJACENT PROPERTIES WITHOUT RECORDED EASEMENT OR NOTARIZED LETTER OF PERMISSION FROM THE ADJACENT PROPERTY OWNERS.
- ALL REQUIRED STATE AND FEDERAL PERMITS, WHICH COULD INCLUDE PERMITS FROM THE VIRGINIA DEPARTMENT OF CONSERVATION AND RECREATION (VDNR), VIRGINIA DEPARTMENT OF ENVIRONMENTAL QUALITY (VDEQ), VIRGINIA DEPARTMENT OF HISTORIC RESOURCES (VDHR), UNITED STATES ENVIRONMENTAL PROTECTION AGENCY (USEPA), ARMY CORPS OF ENGINEERS AND VIRGINIA MARINE RESOURCES, MUST BE IN PLACE FOR ALL PROJECT CONSTRUCTION AND MITIGATION WORK PRIOR TO RELEASE OF THE FINAL SITE PLAN. THIS INCLUDES THE STATE REQUIREMENT FOR A VIRGINIA STORMWATER MANAGEMENT PROGRAM (VSMP) GENERAL PERMIT FOR DISCHARGES OF STORMWATER FROM CONSTRUCTION ACTIVITIES FOR LAND DISTURBING ACTIVITIES GREATER THAN 2,500. INFORMATION REGARDING THE VSMP GENERAL PERMIT CAN BE FOUND ONLINE AT: http://www.dcr.virginia.gov/soil_and_water/vsmp.shtml.
- PERMITS FROM THE CITY OF ALEXANDRIA OFFICE OF ENVIRONMENTAL QUALITY (OEQ), TRANSPORTATION AND ENVIRONMENTAL SERVICES (T&ES), AND BUILDING AND FIRE CODE ADMINISTRATION SHALL BE OBTAINED BY THE APPLICANT, AS REQUIRED AND DOCUMENTED HEREIN. THE CONTRACTOR CAN CONTACT ALEXANDRIA FIRE AND CODE ADMINISTRATION DEPARTMENT AT (703) 838-4644 OR (703) 746-4200 WITH ANY QUESTIONS OR ADDITIONAL INFORMATION.
- ANY WORK IN THE PUBLIC RIGHT OF WAY SHALL REQUIRE A SEPARATE PERMIT FROM THE DIRECTOR, TRANSPORTATION AND ENVIRONMENTAL SERVICES. THE CONTRACTOR CAN CONTACT THE DEPARTMENT OF TRANSPORTATION AND ENVIRONMENTAL SERVICES AT (703) 746-4035 WITH ANY QUESTIONS OR ADDITIONAL INFORMATION.
- THE PROPERTY ADDRESS MUST BE CLEARLY MARKED IN THE FRONT AND BACK OF THE PROPOSED DEVELOPMENT SITE DURING CONSTRUCTION FOR EMERGENCY RESPONSE PURPOSES IN CONTRASTING COLORS FOR EASY IDENTIFICATION.
- THE APPLICANT SHALL CONTACT THE CRIME PREVENTION UNIT OF THE ALEXANDRIA POLICE DEPARTMENT AT 703-838-4520 REGARDING SECURITY HARDWARE FOR NEW CONSTRUCTION. THIS SHALL BE COMPLETED PRIOR TO ISSUANCE OF A BUILDING PERMIT.
- THE CONTRACTOR MUST ENSURE THAT POSITIVE DRAINAGE OCCURS ON SITE TO PREVENT PONDING OR DRAINAGE PROBLEMS ON ADJACENT PROPERTIES.
- A SEPARATE DESIGN IS REQUIRED FOR ALL WALLS 24" AND OVER IN HEIGHT FROM THE GRADE AND SUBJECT TO SEPARATE PERMITS TO BE OBTAINED BY THE OWNERS. GEOTECHNICAL AND STRUCTURAL DESIGN IS TO BE COMPLETED BY OTHERS. THIS FINAL SITE PLAN SHOWS LOCATION, PROPOSED GRADING, AND DESIGN OF ALL THE WALLS.
- SUBMIT A SURVEY, CONSISTENT WITH THE REQUIREMENTS FOR CERTIFICATE OF OCCUPANCY CHECKLIST, TO THE DEPARTMENT OF TRANSPORTATION AND ENVIRONMENTAL SERVICES PRIOR TO REQUESTING AN INSPECTION FOR A CERTIFICATE OF OCCUPANCY.
- ALL SANITARY SEWER LATERALS AND/OR SEWERS NOT SHOWN IN THE EASEMENTS SHALL BE OWNED AND MAINTAINED PRIVATELY.
- ALL STORM DRAINS NOT SHOWN WITHIN AN EASEMENT OR IN A PUBLIC RIGHT OF WAY SHALL BE OWNED AND MAINTAINED PRIVATELY.

CITY STANDARD GENERAL NOTES CONTINUED:

- ALL WATER FACILITY CONSTRUCTION SHALL CONFORM TO VIRGINIA AMERICAN (VAV) STANDARDS AND SPECIFICATIONS. NO WORK CAN BE COMPLETED ON EXISTING AND PROPOSED WATER FACILITIES UNTIL ALL EASEMENTS AND AGREEMENTS WITH VAV ARE FINALIZED, EXECUTED AND RECORDED. DEVELOPER OR CONTRACTOR SHALL CONTACT VAV AT 703-706-3889 TO OBTAIN AN APPROVED PROPOSAL AND PAY ALL REQUIRED FEES, PRIOR TO THE START OF CONSTRUCTION, DEMOLITION AND INSPECTION OF WATER FACILITIES, INCLUDING, BUT NOT LIMITED TO, WATER MAIN, FIRE HYDRANTS, DOMESTIC AND FIRE SERVICE LINES. ALL PROPOSED WET TAPS ON AN EXISTING WATERMAIN SHALL BE CONSTRUCTED BY VAV.
- THE SIDEWALKS SHALL REMAIN OPENED DURING CONSTRUCTION OR PEDESTRIAN ACCESS SHALL BE MAINTAINED TO THE SATISFACTION OF THE DIRECTOR OF TRANSPORTATION AND ENVIRONMENTAL SERVICES THROUGHOUT THE CONSTRUCTION OF THE PROJECT.
- PRIOR TO THE RELEASE OF THE FINAL SITE PLAN, A TRAFFIC CONTROL PLAN FOR CONSTRUCTION DETAILING PROPOSED CONTROLS TO TRAFFIC MOVEMENT, LANE CLOSURES, CONSTRUCTION ENTRANCES, HAUL ROUTES, AND STORAGE AND STAGING SHALL BE PROVIDED FOR INFORMATION PURPOSE; HOWEVER, AN AMENDED TRAFFIC CONTROL PLAN, IF REQUIRED BY THE DIRECTOR OF TRANSPORTATION AND ENVIRONMENTAL SERVICES SHALL BE SUBMITTED TO THE DIRECTOR OF TRANSPORTATION AND ENVIRONMENTAL SERVICES ALONG WITH THE BUILDING PERMIT APPLICATION. THE FINAL SITE PLAN SHALL INCLUDE A STATEMENT "FOR INFORMATION ONLY" ON THE TRAFFIC CONTROL PLAN SHEETS.

EMERGENCY VEHICLE EASEMENTS NOTE

- ALL EMERGENCY VEHICLE EASEMENTS ARE SHOWN ON THE PLAN AND SHALL BE RECORDED WITH ALEXANDRIA LAND RECORDS.

FLOOD PLAIN NOTES

- THE SITE LIES OUTSIDE 100-YEAR FLOOD PLAIN WATER SURFACE ELEVATION (WSE) PER THE DEMARCATION OF THE CURRENT FLOOD INSURANCE RATE MAP (FIRM) PUBLISHED BY FEDERAL EMERGENCY MANAGEMENT AGENCY (FEMA).
- THE PLAN DEMONSTRATES COMPLIANCE WITH THE CONDITIONS OF THE SITE PLAN APPROVAL.

ARCHAEOLOGY NOTES

- THE APPLICANT/DEVELOPER SHALL CALL ALEXANDRIA ARCHAEOLOGY IMMEDIATELY (703-746-4399) IF ANY BURIED STRUCTURAL REMAINS (WALL FOUNDATIONS, WELLS, PRIVIES, CISTERNS, ETC.) OR CONCENTRATIONS OF ARTIFACTS ARE DISCOVERED DURING DEVELOPMENT. WORK MUST CEASE IN THE AREA OF THE DISCOVERY UNTIL A CITY ARCHAEOLOGIST COMES TO THE SITE AND RECORDS THE FINDS.
- THE APPLICANT/DEVELOPER SHALL NOT ALLOW ANY METAL DETECTION AND/OR ARTIFACT COLLECTION TO BE CONDUCTED ON THE PROPERTY, UNLESS AUTHORIZED BY ALEXANDRIA ARCHAEOLOGY. FAILURE TO COMPLY SHALL RESULT IN PROJECT DELAYS.
- ALL REQUIRED ARCHAEOLOGICAL PRESERVATION MEASURES SHALL BE COMPLETED IN COMPLIANCE WITH SECTION 11-411 OF THE ZONING ORDINANCE.
- AS THIS PROJECT IS A FEDERAL UNDERTAKING, THE APPLICANT SHALL COMPLY WITH FEDERAL PRESERVATION LAWS, IN PARTICULAR SECTION 106 OF THE NATIONAL HISTORIC PRESERVATION ACT OF 1966. THE APPLICANT WILL COORDINATE WITH THE VIRGINIA DEPARTMENT OF HISTORIC RESOURCES AND THE FEDERAL AGENCY INVOLVED IN THE PROJECT, AS WELL AS ALEXANDRIA ARCHAEOLOGY.

ENVIRONMENTAL SITE ASSESSMENT

- THERE ARE NO TIDAL WETLANDS, TIDAL SHORES, TRIBUTARY STREAMS, CONNECTED TIDAL WETLANDS, ISOLATED WETLANDS, HIGHLY ERODIABLE/PERMEABLE SOILS OR BUFFER AREAS ASSOCIATED WITH SHORES, STREAMS, OR WETLANDS LOCATED ON THE SITE. FURTHER, THERE ARE NO WETLAND PERMITS REQUIRED FOR THIS DEVELOPMENT PROJECT. ADDITIONALLY, THERE ARE NO KNOWN UNDERGROUND STORAGE TANKS OR AREAS OF GROUNDWATER CONTAMINATION ON THE SITE.
- THE CITY OF ALEXANDRIA DEPARTMENT OF TRANSPORTATION AND ENVIRONMENTAL SERVICES, OFFICE OF ENVIRONMENTAL QUALITY MUST BE NOTIFIED IF UNUSUAL OR UNANTICIPATED CONTAMINATION OR UNDERGROUND STORAGE TANKS, DRUMS, AND CONTAINERS ARE ENCOUNTERED AT THE SITE. IF THERE IS ANY DOUBT ABOUT PUBLIC SAFETY OR A RELEASE TO THE ENVIRONMENT, THE ALEXANDRIA FIRE DEPARTMENT MUST BE CONTACTED IMMEDIATELY BY CALLING 911. THE TANK OR CONTAINER'S REMOVAL, ITS CONTENTS, ANY SOIL CONTAMINATION AND RELEASES TO THE ENVIRONMENT WILL BE HANDLED IN ACCORDANCE WITH FEDERAL, STATE, AND CITY REGULATIONS.
- ALL WELLS TO BE DEMOLISHED IN THIS PROJECT, INCLUDING MONITORING WELLS MUST BE CLOSED IN ACCORDANCE WITH VIRGINIA STATE WATER CONTROL BOARD (VSWCB) REQUIREMENTS. CONTACT ENVIRONMENTAL HEALTH SPECIALIST AND COORDINATE WITH THE ALEXANDRIA HEALTH DEPARTMENT AT 703-838-4400 EXT 267/255.
- ALL CONSTRUCTION ACTIVITIES MUST COMPLY WITH THE ALEXANDRIA NOISE CONTROL CODE TITLE 11, CHAPTER 5, WHICH PERMITS CONSTRUCTION ACTIVITIES TO OCCUR BETWEEN THE FOLLOWING HOURS:
MONDAY THROUGH FRIDAY FROM 7 AM TO 6 PM AND
SATURDAYS FROM 9 AM TO 6 PM.
NO CONSTRUCTION ACTIVITIES ARE PERMITTED ON SUNDAYS.
- PILE DRIVING IS FURTHER RESTRICTED TO THE FOLLOWING HOURS:
MONDAY THROUGH FRIDAY FROM 9 AM TO 6 PM AND
SATURDAYS FROM 10 AM TO 4 PM.

UTILITY WORKS

UNDERGROUND UTILITY LINES SHALL BE INSTALLED IN ACCORDANCE WITH THE FOLLOWING MINIMUM STANDARDS DESCRIBED IN SECTION 4VAC50-30-40 OF THE VIRGINIA EROSION AND SEDIMENT CONTROL HANDBOOK (VESCH) AND ADDITIONAL APPLICABLE PRACTICES FOLLOWED BY THE CITY OF ALEXANDRIA:

- ALL PRIVATE UTILITIES SHALL BE LOCATED OUTSIDE OF THE PUBLIC RIGHT-OF-WAY AND PUBLIC UTILITY EASEMENTS UNLESS THE UTILITY OWNERS HAVE FRANCHISE AGREEMENT WITH THE CITY OF ALEXANDRIA; HOWEVER, NO ELECTRIC TRANSFORMERS AND SWITCH GEARS OR CONTROL BOXES SHALL BE PLACED IN THE PUBLIC RIGHT OF WAY.
- ALL THE EXISTING AND PROPOSED PUBLIC AND PRIVATE UTILITIES AND EASEMENTS SHALL BE SHOWN AND A DESCRIPTIVE NARRATION OF VARIOUS UTILITIES SHALL BE PROVIDED ON THE PLAN.
- IT IS THE CONTRACTOR'S RESPONSIBILITY TO MAINTAIN UTILITY SERVICES AT ALL TIMES DURING CONNECTION AND/OR CONSTRUCTION.
- NO MORE THAN 500 LINEAR FEET OF TRENCH MAY BE OPENED AT ONE TIME.
- EXCAVATED MATERIAL SHALL BE PLACED ON THE UPHILL SIDE OF TRENCHES.
- EFFLUENT FROM DEWATERING OPERATIONS SHALL BE FILTERED OR PASSED THROUGH AN APPROVED SEDIMENT TRAPPING DEVICE, OR BOTH, AND DISCHARGED IN A MANNER THAT DOES NOT ADVERSELY AFFECT FLOWING STREAMS OR OFF-SITE PROPERTY.
- MATERIAL USED FOR BACKFILLING TRENCHES SHALL BE PROPERLY COMPACTED IN ACCORDANCE WITH THE CITY OF ALEXANDRIA STANDARDS AND SPECIFICATIONS TO MINIMIZE EROSION AND PROMOTE STABILIZATION.
- SHOULD UTILITY CONSTRUCTION BE PERFORMED AFTER COMPLETING EARTHWORK, THE CONTRACTOR SHALL BE RESPONSIBLE FOR ACHIEVING 98 PERCENT OF THE MODIFIED PROCTOR MAXIMUM DRY DENSITY (ASTM D-1551) COMPACTION IN ALL TRENCH BACKFILL.
- RESTALLIZATION SHALL BE ACCOMPLISHED IN ACCORDANCE WITH THE VIRGINIA REGULATIONS §4VAC50-30 EROSION AND SEDIMENT CONTROL REGULATIONS, VIRGINIA EROSION AND SEDIMENT CONTROL HANDBOOK (VESCH).
- APPLICABLE SAFETY REGULATIONS SHALL BE COMPLIED WITH.
- THE CONTRACTOR IS RESPONSIBLE FOR INSTALLATION OF ANY ADDITIONAL CONTROL MEASURES AS NECESSARY TO PREVENT EROSION AND SEDIMENTATION, AS DETERMINED BY THE DIRECTOR OF TRANSPORTATION AND ENVIRONMENTAL SERVICES, CITY OF ALEXANDRIA.
- A REMEDIATION PLAN SHALL BE SUBMITTED DETAILING HOW CONTAMINATED SOILS AND/OR GROUNDWATER WILL BE DEALT WITH, INCLUDING PLANS TO REMEDIATE UTILITY CORRIDORS.
- UTILITY CORRIDORS IN CONTAMINATED SOIL SHALL BE OVER EXCAVATED BY 2 FEET AND BACKFILLED WITH "CLEAN" SOIL.
- GRADING CAN BE PERFORMED ON INSTALLATION OF UTILITIES.
- ALL NEW INSTALLATIONS AND/OR UTILITIES SUCH AS ELECTRICAL LINES, GAS PIPES, COMMUNICATION CABLES, INCLUDING WATER AND SEWER LATERALS BOTH ON PRIVATE PROPERTY AND IN THE PUBLIC RIGHT OF WAY IN THE CITY OF ALEXANDRIA SHALL BE PROVIDED WITH 3" AND 6" WIDE 5 MIL OVERALL THICKNESS DETECTABLE UNDERGROUND WARNING TAPE (DUWT). THE DUWT SHALL BE INSTALLED AT DEPTHS OF 12" TO 18" AND 6" WIDE AT A DEPTH OF 24" SO AS TO MAKE UNDERGROUND INSTALLATIONS EASY TO FIND USING A NON-FERROUS LOCATOR. THE DUWT SHALL BE WITH ALUMINUM BACKING OR SOLID ALUMINUM CORE LAMINATED WITH A PROTECTIVE CLEAR FILM ON BOTH SIDES, SEALING AND PROTECTING THE GRAPHICS FROM UNDERGROUND MOISTURE, ACIDS, ALKALIS, AND OTHER SOIL SUBSTANCES. ALL DUWT TAPES SHALL BE PRINTED IN BLACK INK ON AMERICAN PUBLIC WORKS ASSOCIATION (APWA) APPROVED COLORS TO MEET OR EXCEED INDUSTRY STANDARDS. THE FOLLOWING ARE THE APWA COLOR CODES:

COLOR	CODES
RED	CAUTION BURIED ELECTRIC POWER LINES, CABLES, CONDUITS, AND LIGHTING CABLES
YELLOW	CAUTION GAS, OIL, STEAM, PETROLEUM, OR GASEOUS MATERIALS
ORANGE	CAUTION COMMUNICATIONS, ALARM OR SIGNAL LINES, CABLES, OR CONDUITS
BLUE	CAUTION POTABLE WATER
PURPLE	CAUTION RECLAIMED WATER, IRRIGATION AND SLURRY
GREEN	CAUTION SEWER, DRAIN LINES, AND FORCE MAIN LINES

APPROVED SPECIAL USE PERMIT NO. DEPARTMENT OF PLANNING & ZONING	
DIRECTOR _____	DATE _____
DEPARTMENT OF TRANSPORTATION & ENVIRONMENTAL SERVICES	
SITE PLAN NO. <u>DSP2011-0027</u>	
DIRECTOR _____	DATE _____
CHAIRMAN, PLANNING COMMISSION _____ DATE _____	
DATE RECORDED _____	
INSTRUMENT NO. _____	DEED BOOK NO. _____ PAGE NO. _____

DATUM:
(HZ) NAD 83
(VT) NAVD 88

60% SUBMITTAL

CONTRACT NO:	REVISIONS						VIRGINIA RAILWAY EXPRESS ALEXANDRIA PEDESTRIAN TUNNEL	DISCIPLINE:	DRAWING NO:	
PROJECT NO:	BY	NO	DATE					DESCRIPTION	GENERAL NOTES	C-001
DESIGNED:	GF	001						DEV. CONCEPT PLAN (30%)	SCALE:	DATE ISSUED:
DRAFTED:	GF	002	6/20/16	DEV. SITE PLAN	NONE	6/20/16				
CHECKED:										
APPROVED:										

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LEGEND

EXISTING CONDITIONS

PROPERTY LINE	---
EDGE OF ROADWAY PAVING AND GUTTER	=====
CURB OR CURB AND GUTTER	=====
EXISTING GROUND CONTOURS (10')	--- 30 ---
EXISTING GROUND CONTOURS (1')	--- 31 ---
RAILROAD	+++++
FENCE	- X - X -
FIRE HYDRANT	⊙
EDGE OF WOODED AREAS	~~~~~
TREE (FREE STANDING)	⊙
WETLAND LIMITS	⊙
SIGN	⊙
LIGHT POLE	⊙
UTILITY POLE	⊙
STORM DRAIN	---
STORM DRAIN	- D - D -
SANITARY SEWER	- S - S -
WATER	- W - W -
GAS	- G - G -
ELECTRICAL HAND BOX - SIGNALS	H.B.
ELECTRIC	- E - E -
TELEPHONE	- T - T -
PLANTATION	- P -
PETROLEUM LINE	---
STORM DRAIN MANHOLE	⊙
STORM DRAIN INLET	⊙
SANITARY MANHOLE	⊙
CLEANOUT	CO
SANITARY STRUCTURE	⊙
WATER VALVE	⊙
GAS VALVE	⊙
GAS METER	⊙
ELEC STRUCTURE	⊙
ELEC STRUCTURE	⊙
ELEC VAULT	EV
TELEPHONE STRUCTURE	⊙
MISC. MANHOLE	⊙
TEST HOLE	⊙
BORING	⊙

PROPOSED CONSTRUCTION

LIMIT OF DISTURBANCE	LOD
GRADING ELEVATION CONTOURS (10')	30
STORM DRAIN PIPE	---
CLEAN OUT	CO

ABBREVIATIONS

AASHTO	AMERICAN ASSOCIATION OF STATE HIGHWAY TRANSPORTATION OFFICIALS	HDWL	HEADWALL	RW or R/W	RIGHT OF WAY
ADT	AVERAGE DAILY TRAFFIC	HERCP	HORIZONTAL ELLIPTICAL REINFORCED CONCRETE PIPE	RCPP	REINFORCED CONCRETE PIPE
AHD	AHEAD	HP	HIGH POINT	R.Q.D.	ROCK QUALITY DESIGNATION
APPROX.	APPROXIMATE	IN	INCH	R.M.	ROOMMATE
⊙ or B/L	BASELINE	I.S.T	INLET SEDIMENT TRAP	S	SOUTH
BK	BACK / BOOK	INV.	INVERT	SAN.	SANITARY SEWER
BIT.	BITUMINOUS	J.B.	JUNCTION BOX	SB or S/B	SOUTHBOUND
B.C.	BITUMINOUS CONCRETE	K'	K' INLET	S.D.	STORM DRAIN
B.M.	BENCH MARK	L	LENGTH	S.D.D.	SURFACE DRAIN DITCH
BOT.	BOTTOM	LF	LINEAR FEET	S/E	SUPER ELEVATION
C.C.	CENTER OF CURVE	L.L.	LIQUID LIMIT	SF	SILT FENCE
CAP	CORRUGATED ALUMINUM PIPE	LP	LOW POINT	SF	SQUARE FEET
CAPA	CORRUGATED ALUMINUM PIPE ARCH	L.P.	LIGHT POLE	SHT.	SHEET
CATV	CABLE TELEVISION	LT.	LEFT	SPP	STRUCTURAL STEEL PLATE PIPE
C.B.R.	CALIFORNIA BEARING RATIO	MAC.	MACADAM	SPPA	STRUCTURAL STEEL PLATE PIPE ARCH
⊙ or C/L	CENTERLINE	M.C.	MOISTURE CONTENT	S.P.T.	STANDARD PENETRATION TESTING
CL.	CLASS	MAX.	MAXIMUM	SRP	STEEL SPIRAL RIB PIPE - ALUMINIZED TYPE 2
CLF	CHAINLINK FENCE	M.D.D.	MAXIMUM DRY CONTENT	SRPA	STEEL SPIRAL RIB PIPE ARCH - ALUMINIZED TYPE 2
CMP	CORRUGATED METAL PIPE	MOD.	MODIFIED	SSD	STOPPING SIGHT DISTANCE
C.O.	CLEANOUT	MIN.	MINIMUM	SSF	SUPER SILT FENCE
COMB.	COMBINATION	N	NORTH	STD.	STANDARD
CONC.	CONCRETE	NB	NORTHBOUND	STA.	STATION
CONSTR.	CONSTRUCTION	NE	NORTHEAST	SO.	SINGLE OPENING
COR.	CORNER	N.P.	NON-PLASTIC	SY	SQUARE YARDS
CORR.	CORRECTION	O.C.	ON CENTER	SWM	STORMWATER MANAGEMENT
CPP-S	CORRUGATED POLYETHYLENE PIPE - TYPE 'S'	OHE	OVERHEAD ELECTRIC	T	TANGENT
CSP	CORRUGATED STEEL PIPE - ALUMINIZED TYPE 2	O.M.	OPTIMUM MOISTURE	T	TELEPHONE
CSPA	CORRUGATED STEEL PIPE ARCH - ALUMINIZED TYPE 2	PAVT.	PAVEMENT	T.C.	TOP OF COVER
DC	DEGREE OF CURVE	PC	POINT OF CURVATURE	T.C.	TOP OF COVER
D.H.V.	DESIGN HOURLY VOLUME	PCC	POINT OF COMPOUND CURVATURE	T.G.	TOP OF GRATE
D.I.	DROP INLET	P/C	POINT OF CROWN	T or TL	TRAVERSE LINE
DIA.	DIAMETER	P/GE	PROFILE GRADE ELEVATION	T.M.	TOP OF MANHOLE
D.O.	DOUBLE OPENING	P.G.E.	PROFILE GROUND ELEVATION	TRAV.	TRAVERSE
E	EAST	P.G.L.	PROFILE GRADE LINE	TS	TEMPORARY SWALE
E	ELECTRIC	P/GL	PROFILE GROUND LINE	T.S.	TOP OF SLAB
E	EXTERNAL DISTANCE	P/R	POINT OF ROTATION	T.S.	TOPSOIL
EA	EACH	P.I.	PLASTICITY INDEX	TYP.	TYPICAL
EB	EASTBOUND	PI	POINT OF INTERSECTION	U.D.	UNDER DRAIN
ELEV	ELEVATION	POT	POINT ON TANGENT	U.G.	UNDERGROUND
ES	END SECTION	PPWP	POLYVINYL CHLORIDE PROFILE WALL PIPE	U.P.	UTILITY POLE
EX or EXIST	EXISTING	PROP	PROPOSED	USDA	UNITED STATES DEPARTMENT OF AGRICULTURE
FT	FEET	PRC	POINT OF REVERSE CURVE	VCL	VERTICAL CLEARANCE
F or FL	FLOWLINE	PT	POINT	V.C.L.	VERTICAL CURVE LENGTH
F.B.D.	FLAT BOTTOM DITCH	PT	POINT OF TANGENCY	W	WEST
F.H.	FIRE HYDRANT	PVC	POINT OF VERTICAL CURVE	WB	WESTBOUND
FWD.	FORWARD	PVC	POLYVINYL CHLORIDE	WB	WETLAND BUFFER
G	GAS	PVI	POINT OF VERTICAL INTERSECTION	W.M.	WATER METER
G.V.	GAS VALVE	PVRC	POINT OF VERTICAL REVERSE CURVE	W.S.	WRAPPED STEEL
H.B.	HANDBOX	PVT	POINT OF VERTICAL TANGENCY	WUS	WATERS OF THE UNITED STATES
HOPE	HIGH DENSITY POLYETHYLENE	R	RADIUS	W.V.	WATER VALVE
		R.F.	ROCK FRAGMENTS		
		RT	RIGHT		

MISS UTILITY OF VIRGINIA - DESIGN UTILITY TICKET DATA

TICKET	STATE	ADDRESS	MARKING CODE	DESCRIPTION	RESPONSE	MARKING CODE	DESCRIPTION	RESPONSE
A519502543	VA	110 CALLAHAN DR	LTC	LEVEL 3 COMMUNICATIONS (LTC903)	08/04/15 08:56 PM 30	WGL	WASHINGTON GAS (WGL904)	08/04/15 12:25 PM 30
ALR			MCI	ALEXANDRIA RENEW - SEWER (ALR549)	07/15/15 02:16 PM 30	WGN	WINDSTREAM KDL (WGN456)	08/05/15 07:44 AM 96
ALX			OBV	ALEXANDRIA CITY UTILITIES (ALX901)	08/03/15 03:14 PM 52	ZAY	ZAYO - COMMUNICATIONS (ZAY828)	08/03/15 03:29 PM 30
ATT			PPL	AT&T (ATT392)	08/03/15 03:22 PM 70			
CMC			QCS	COMCAST (CMC259)	08/04/15 02:42 PM 30			
DOM			QWE	DOMINION VA POWER ELEC. DI (DOM400)	08/04/15 12:25 PM 32			
DOM			VAW	DOMINION VA POWER COMMUNI (DOM711)	08/04/15 02:42 PM 30			
FBL			VZN	FIBERLIGHT (FBL410)	08/04/15 09:40 PM 30			

APPROVED SPECIAL USE PERMIT NO. _____
 DEPARTMENT OF PLANNING & ZONING
 DIRECTOR _____ DATE _____
 DEPARTMENT OF TRANSPORTATION & ENVIRONMENTAL SERVICES
 SITE PLAN NO. DSP2011-0027
 DIRECTOR _____ DATE _____
 CHAIRMAN, PLANNING COMMISSION _____ DATE _____
 DATE RECORDED _____
 INSTRUMENT NO. _____ DEED BOOK NO. _____ PAGE NO. _____

DATUM:
(HZ) NAD 83
(VT) NAVD 88

60% SUBMITTAL

CONTRACT NO:	
PROJECT NO:	
DESIGNED:	
DRAFTED:	
CHECKED:	
APPROVED:	


REVISIONS			
BY	NO	DATE	DESCRIPTION
GF	001		DEV. CONCEPT PLAN (30%)
GF	002	6/20/16	DEV. SITE PLAN



VIRGINIA RAILWAY EXPRESS
 ALEXANDRIA
 PEDESTRIAN TUNNEL

DISCIPLINE:	CIVIL
LEGEND AND ABBREVIATIONS	
SCALE:	NONE
DATE ISSUED:	6/20/16

DRAWING NO:	C-002
LIST NO:	

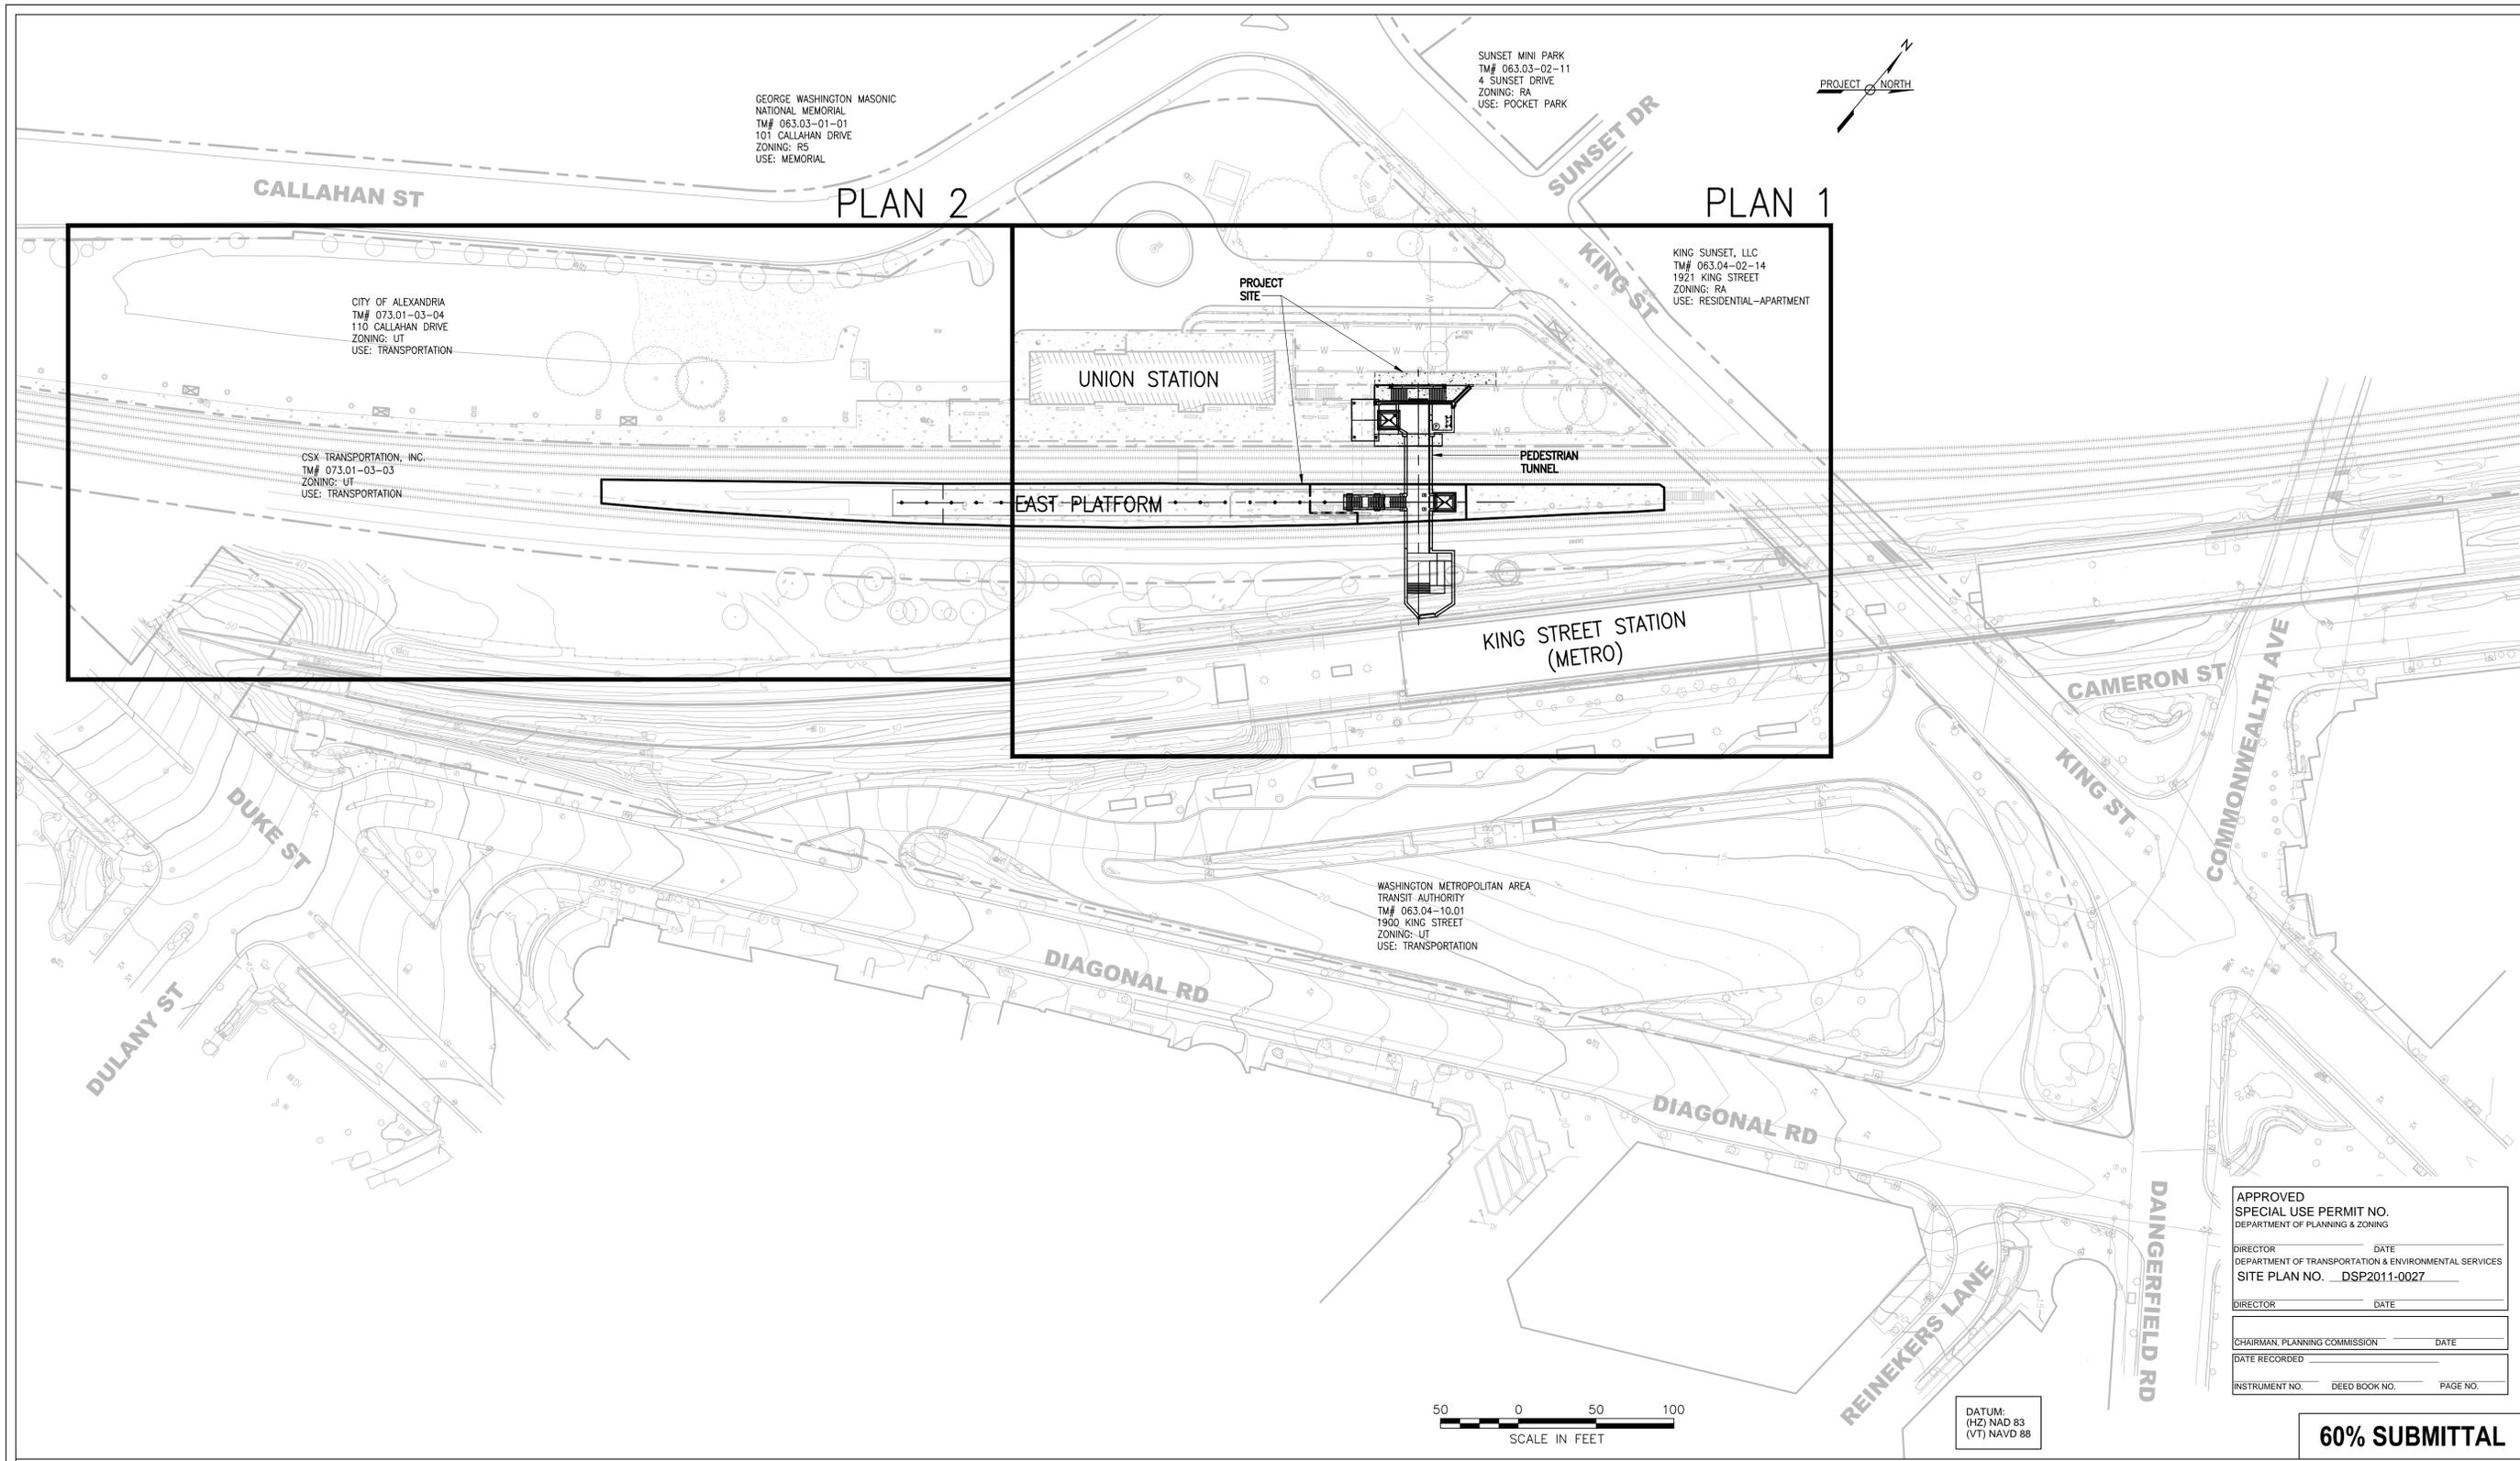

APPROVED SPECIAL USE PERMIT NO.	
DEPARTMENT OF PLANNING & ZONING	
DIRECTOR _____	DATE _____
DEPARTMENT OF TRANSPORTATION & ENVIRONMENTAL SERVICES	
SITE PLAN NO. <u>DSP2011-0027</u>	
DIRECTOR _____	DATE _____
CHAIRMAN, PLANNING COMMISSION _____ DATE _____	
DATE RECORDED _____	
INSTRUMENT NO. _____	DEED BOOK NO. _____ PAGE NO. _____

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CONTRACT NO:	
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APPROVED:	

REVISIONS			
BY	NO	DATE	DESCRIPTION
GF	001		DEV. CONCEPT PLAN (30%)
GF	002	6/20/16	DEV. SITE PLAN




VIRGINIA RAILWAY EXPRESS
 ALEXANDRIA
 PEDESTRIAN TUNNEL

DISCIPLINE:	CIVIL
OVERALL SITE PLAN / CONTEXTUAL PLAN	
SCALE:	1"=50'
DATE ISSUED:	6/20/16

DRAWING NO:	C-101
LIST NO:	

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- GENERAL NOTES**
- EXISTING TOPOGRAPHY FOR THE UNION STATION SITE IS BASED ON FIELD RUN SURVEYS PERFORMED BY CHRISTOPHER CONSULTANTS DATED JANUARY AND APRIL 2015.
 - HORIZONTAL DATUM: NAD 83.
 - VERTICAL DATUM: NAVD 88.
 - THE UNDERGROUND UTILITIES SHOWN ARE BASED ON EXISTING DRAWINGS AND LOCATION OF SURFACE FEATURES. THE OWNER DOES NOT WARRANT OR GUARANTEE THE ACCURACY OF THIS PORTRAYAL.
 - THE CONTRACTOR SHALL NOTIFY "MISS UTILITY OF VIRGINIA" AT 811 AT LEAST THREE WORKING DAYS PRIOR TO COMMENCING WORK ON THIS PROJECT TO ARRANGE FOR UTILITY LOCATION AND MARKING. NO WORK CAN PROCEED UNTIL UTILITY MARKING IS COMPLETE.
 - FOR AREAS AND/OR UTILITIES WHICH "MISS UTILITY OF VIRGINIA" WILL NOT LOCATE, THE CONTRACTOR SHALL UTILIZE THE SERVICES OF A PRIVATE UTILITY LOCATOR TO IDENTIFY THE LOCATION OF SUBSURFACE UTILITIES WITHIN THE LIMITS OF WORK.
 - PROPERTY LINES ARE BASED ON FIELD SURVEYS PERFORMED BY CHRISTOPHER CONSULTANTS DATED FEBRUARY 2000 AND AVAILABLE DEEDS AND PLATS OF RECORD.
 - THE SITE HAS NO KNOWN AREAS OF MARINE CLAY.
 - THERE IS NO KNOWN OR EXPECTED CONTAMINATION ON THE SITE. A PRELIMINARY SITE ASSESSMENT WAS PERFORMED BY CARDNO MM&A, ON DECEMBER 14, 2012 WHICH DOCUMENTS THE EXISTING CONDITION.

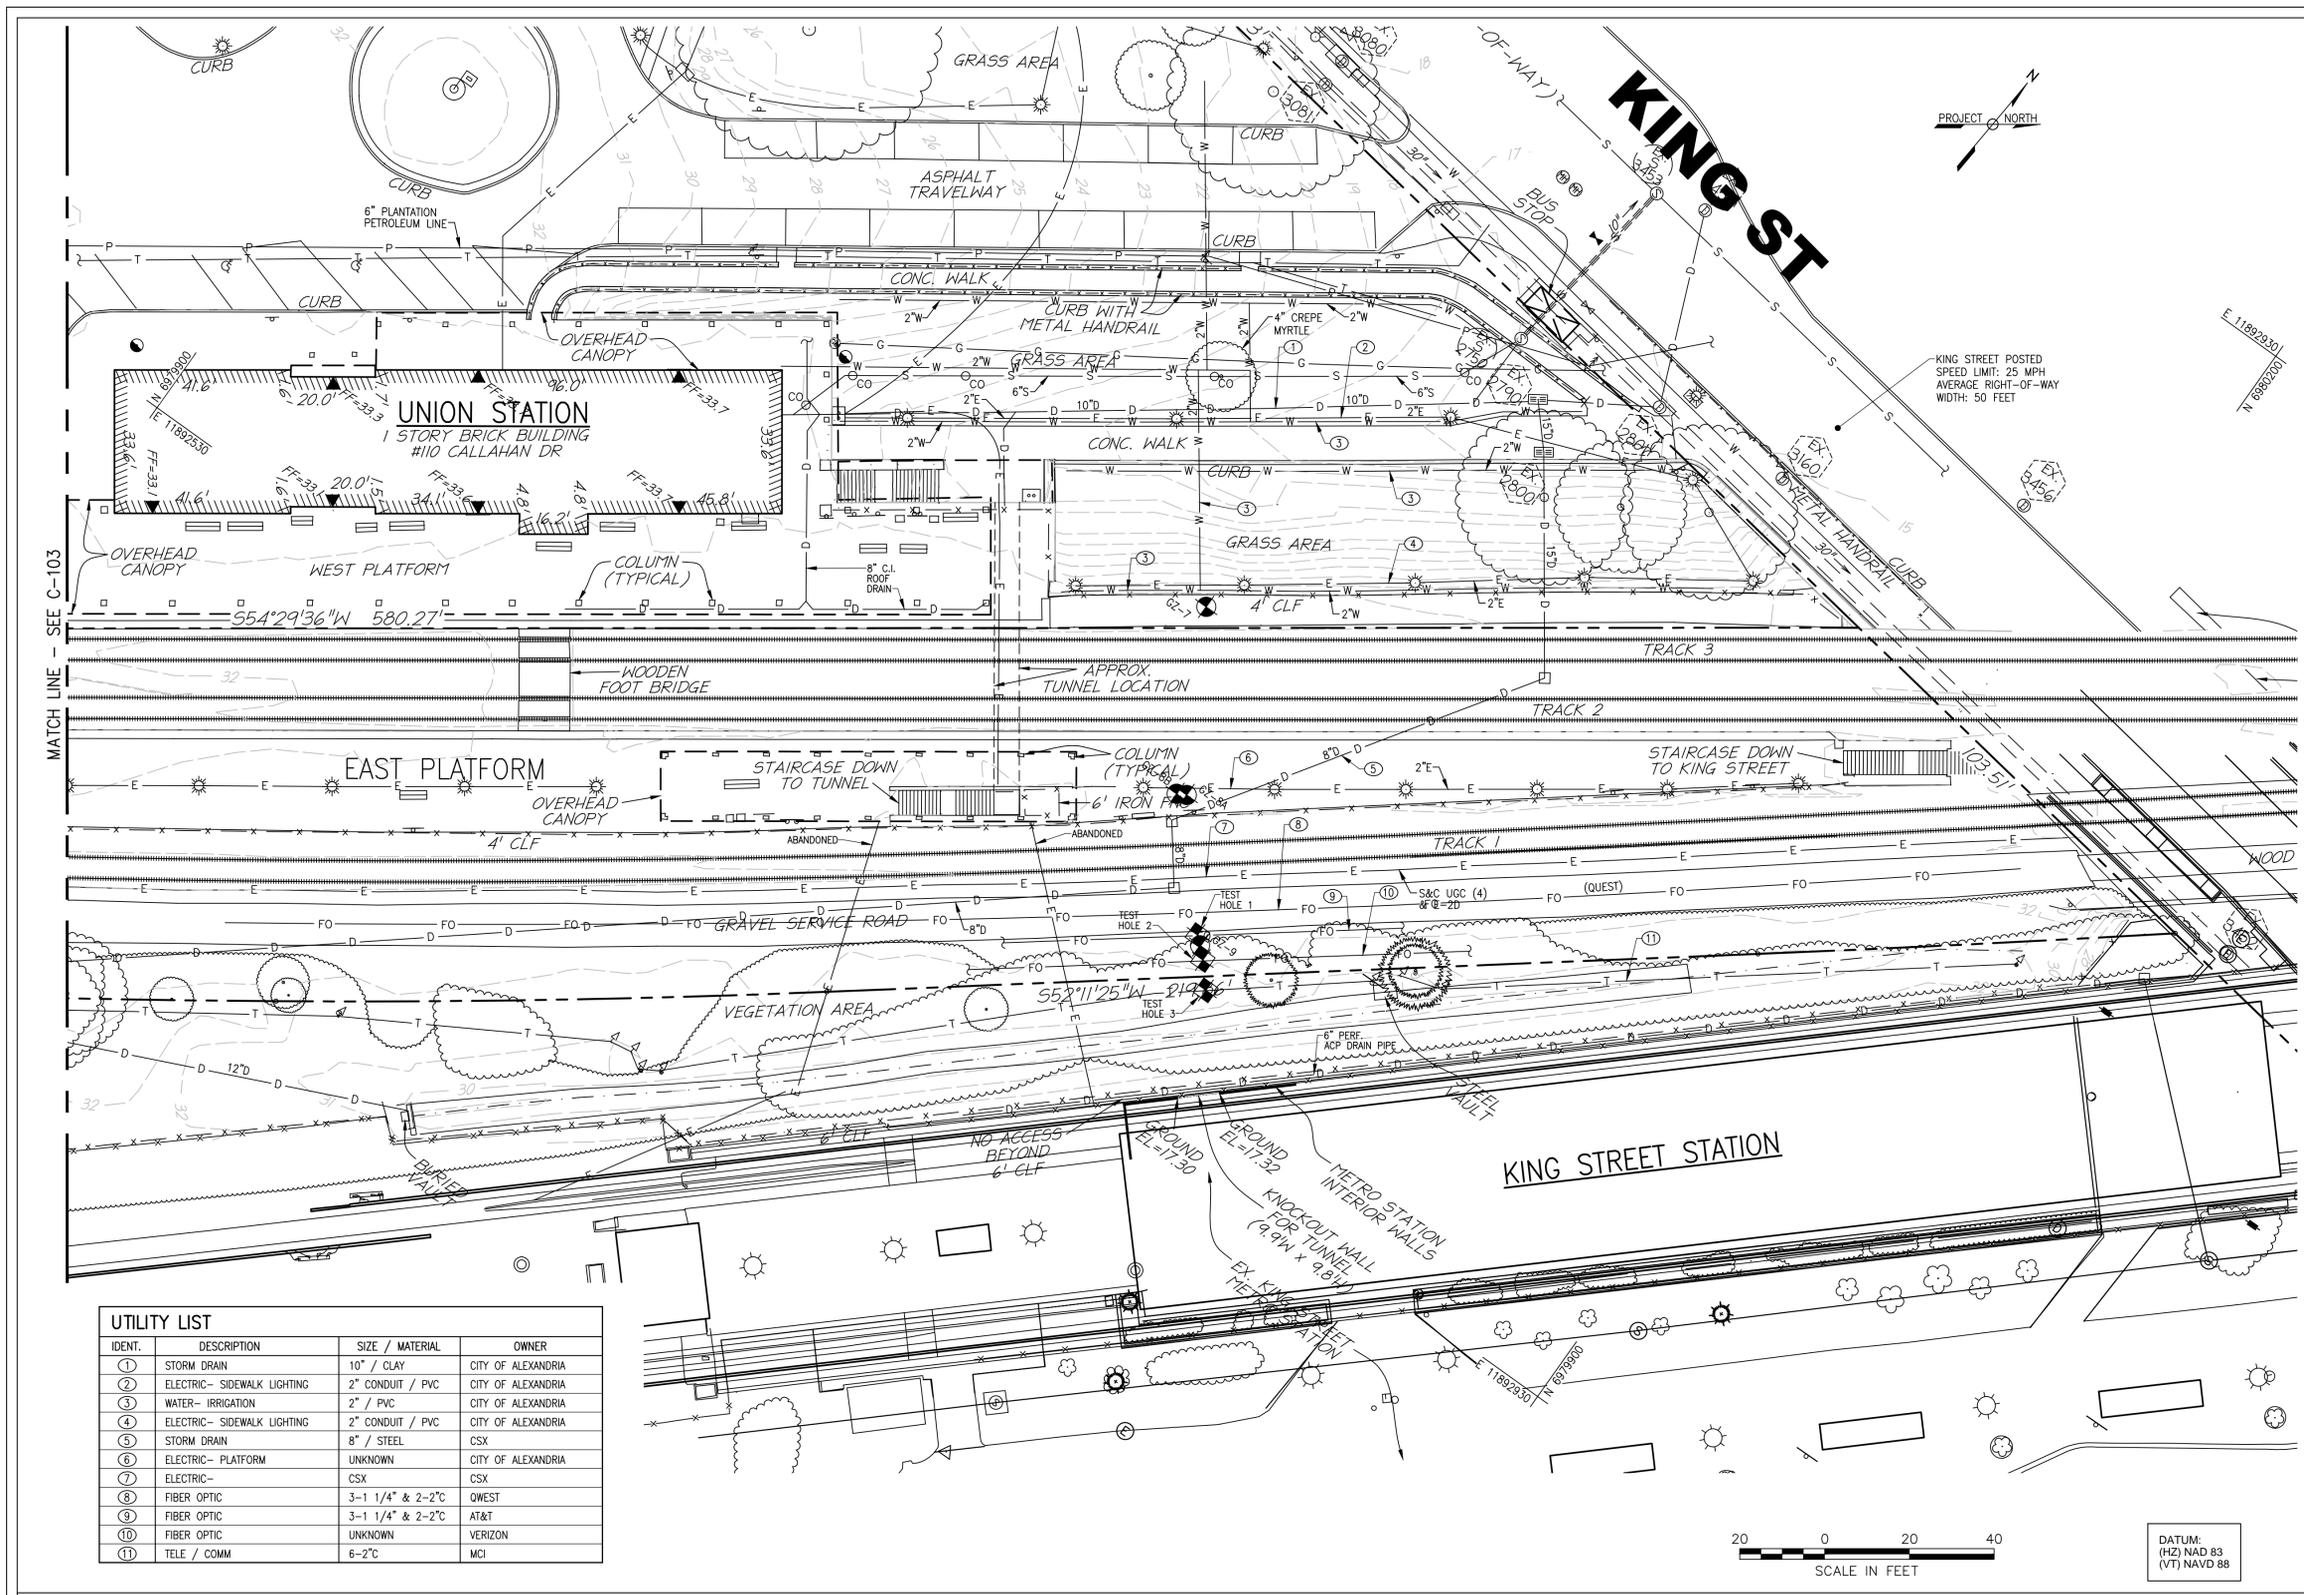UTILITY LIST

IDENT.	DESCRIPTION	SIZE / MATERIAL	OWNER
①	STORM DRAIN	10" / CLAY	CITY OF ALEXANDRIA
②	ELECTRIC- SIDEWALK LIGHTING	2" CONDUIT / PVC	CITY OF ALEXANDRIA
③	WATER- IRRIGATION	2" / PVC	CITY OF ALEXANDRIA
④	ELECTRIC- SIDEWALK LIGHTING	2" CONDUIT / PVC	CITY OF ALEXANDRIA
⑤	STORM DRAIN	8" / STEEL	CSX
⑥	ELECTRIC- PLATFORM	UNKNOWN	CITY OF ALEXANDRIA
⑦	ELECTRIC-	CSX	CSX
⑧	FIBER OPTIC	3-1 1/4" & 2-2"	QWEST
⑨	FIBER OPTIC	3-1 1/4" & 2-2"	AT&T
⑩	FIBER OPTIC	UNKNOWN	VERIZON
⑪	TELE / COMM	6-2"	MCI

APPROVED
SPECIAL USE PERMIT NO.
DEPARTMENT OF PLANNING & ZONING

DIRECTOR: _____ DATE: _____
DEPARTMENT OF TRANSPORTATION & ENVIRONMENTAL SERVICES
SITE PLAN NO. DSP2011-0027
DIRECTOR: _____ DATE: _____

CHAIRMAN, PLANNING COMMISSION _____ DATE: _____
DATE RECORDED: _____
INSTRUMENT NO. _____ DEED BOOK NO. _____ PAGE NO. _____



DATUM:
(H2) NAD 83
(VT) NAVD 88

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CONTRACT NO:	REVISIONS		
PROJECT NO:	BY	NO	DATE
DESIGNED:	GF	001	
DRAFTED:	GF	002	6/20/16
CHECKED:			
APPROVED:			
			DESCRIPTION
			DEV. CONCEPT PLAN (30%)
			DEV. SITE PLAN




VIRGINIA RAILWAY EXPRESS
ALEXANDRIA
PEDESTRIAN TUNNEL

DISCIPLINE:	DRAWING NO:
CIVIL EXISTING CONDITIONS PLAN 1	C-102
SCALE:	LIST NO:
1"=20'	
DATE ISSUED:	
6/20/16	

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CALLAHAN ST

CALLAHAN STREET
(PUBLIC RIGHT-OF-WAY)

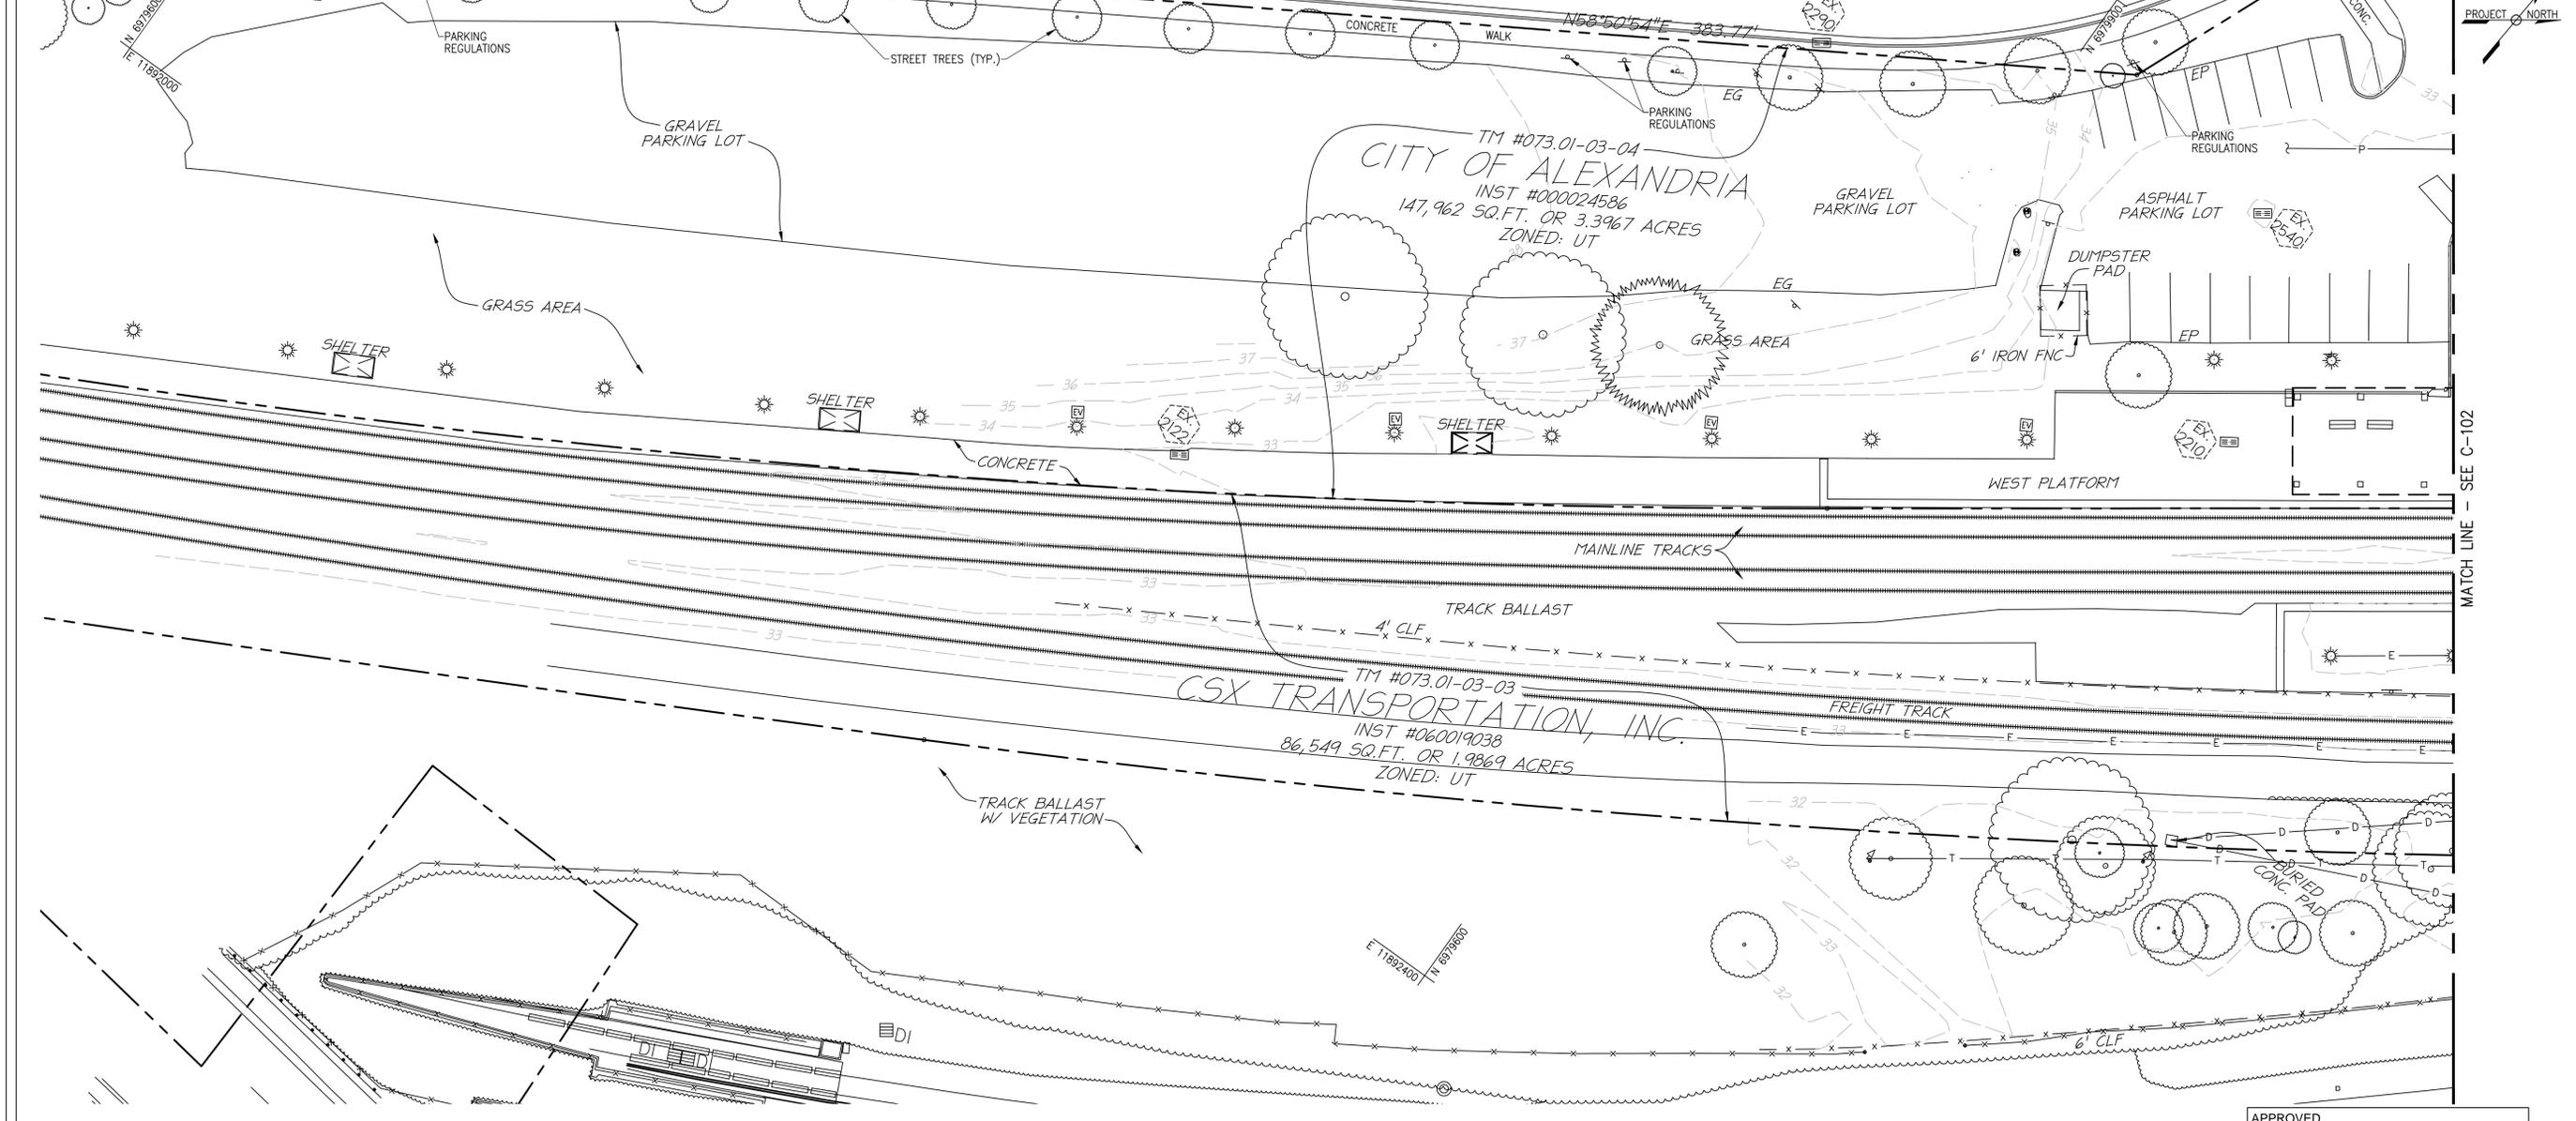

MATCH LINE - SEE C-102

APPROVED
SPECIAL USE PERMIT NO.
DEPARTMENT OF PLANNING & ZONING

DIRECTOR: _____ DATE: _____
DEPARTMENT OF TRANSPORTATION & ENVIRONMENTAL SERVICES
SITE PLAN NO. DSP2011-0027

DIRECTOR: _____ DATE: _____

CHAIRMAN, PLANNING COMMISSION: _____ DATE: _____

DATE RECORDED: _____

INSTRUMENT NO. _____ DEED BOOK NO. _____ PAGE NO. _____



DATUM:
(H2) NAD 83
(VT) NAVD 88

60% SUBMITTAL

CONTRACT NO:	REVISIONS			
PROJECT NO:	BY	NO	DATE	DESCRIPTION
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	GF	002	6/20/16	DEV. SITE PLAN
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DRAFTED:				
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APPROVED:				



VIRGINIA RAILWAY EXPRESS

ALEXANDRIA
PEDESTRIAN TUNNEL

DISCIPLINE:
CIVIL
EXISTING CONDITIONS PLAN 2


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DATE ISSUED: 6/20/16


DRAWING NO:
C-103

LIST NO:

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LEGEND

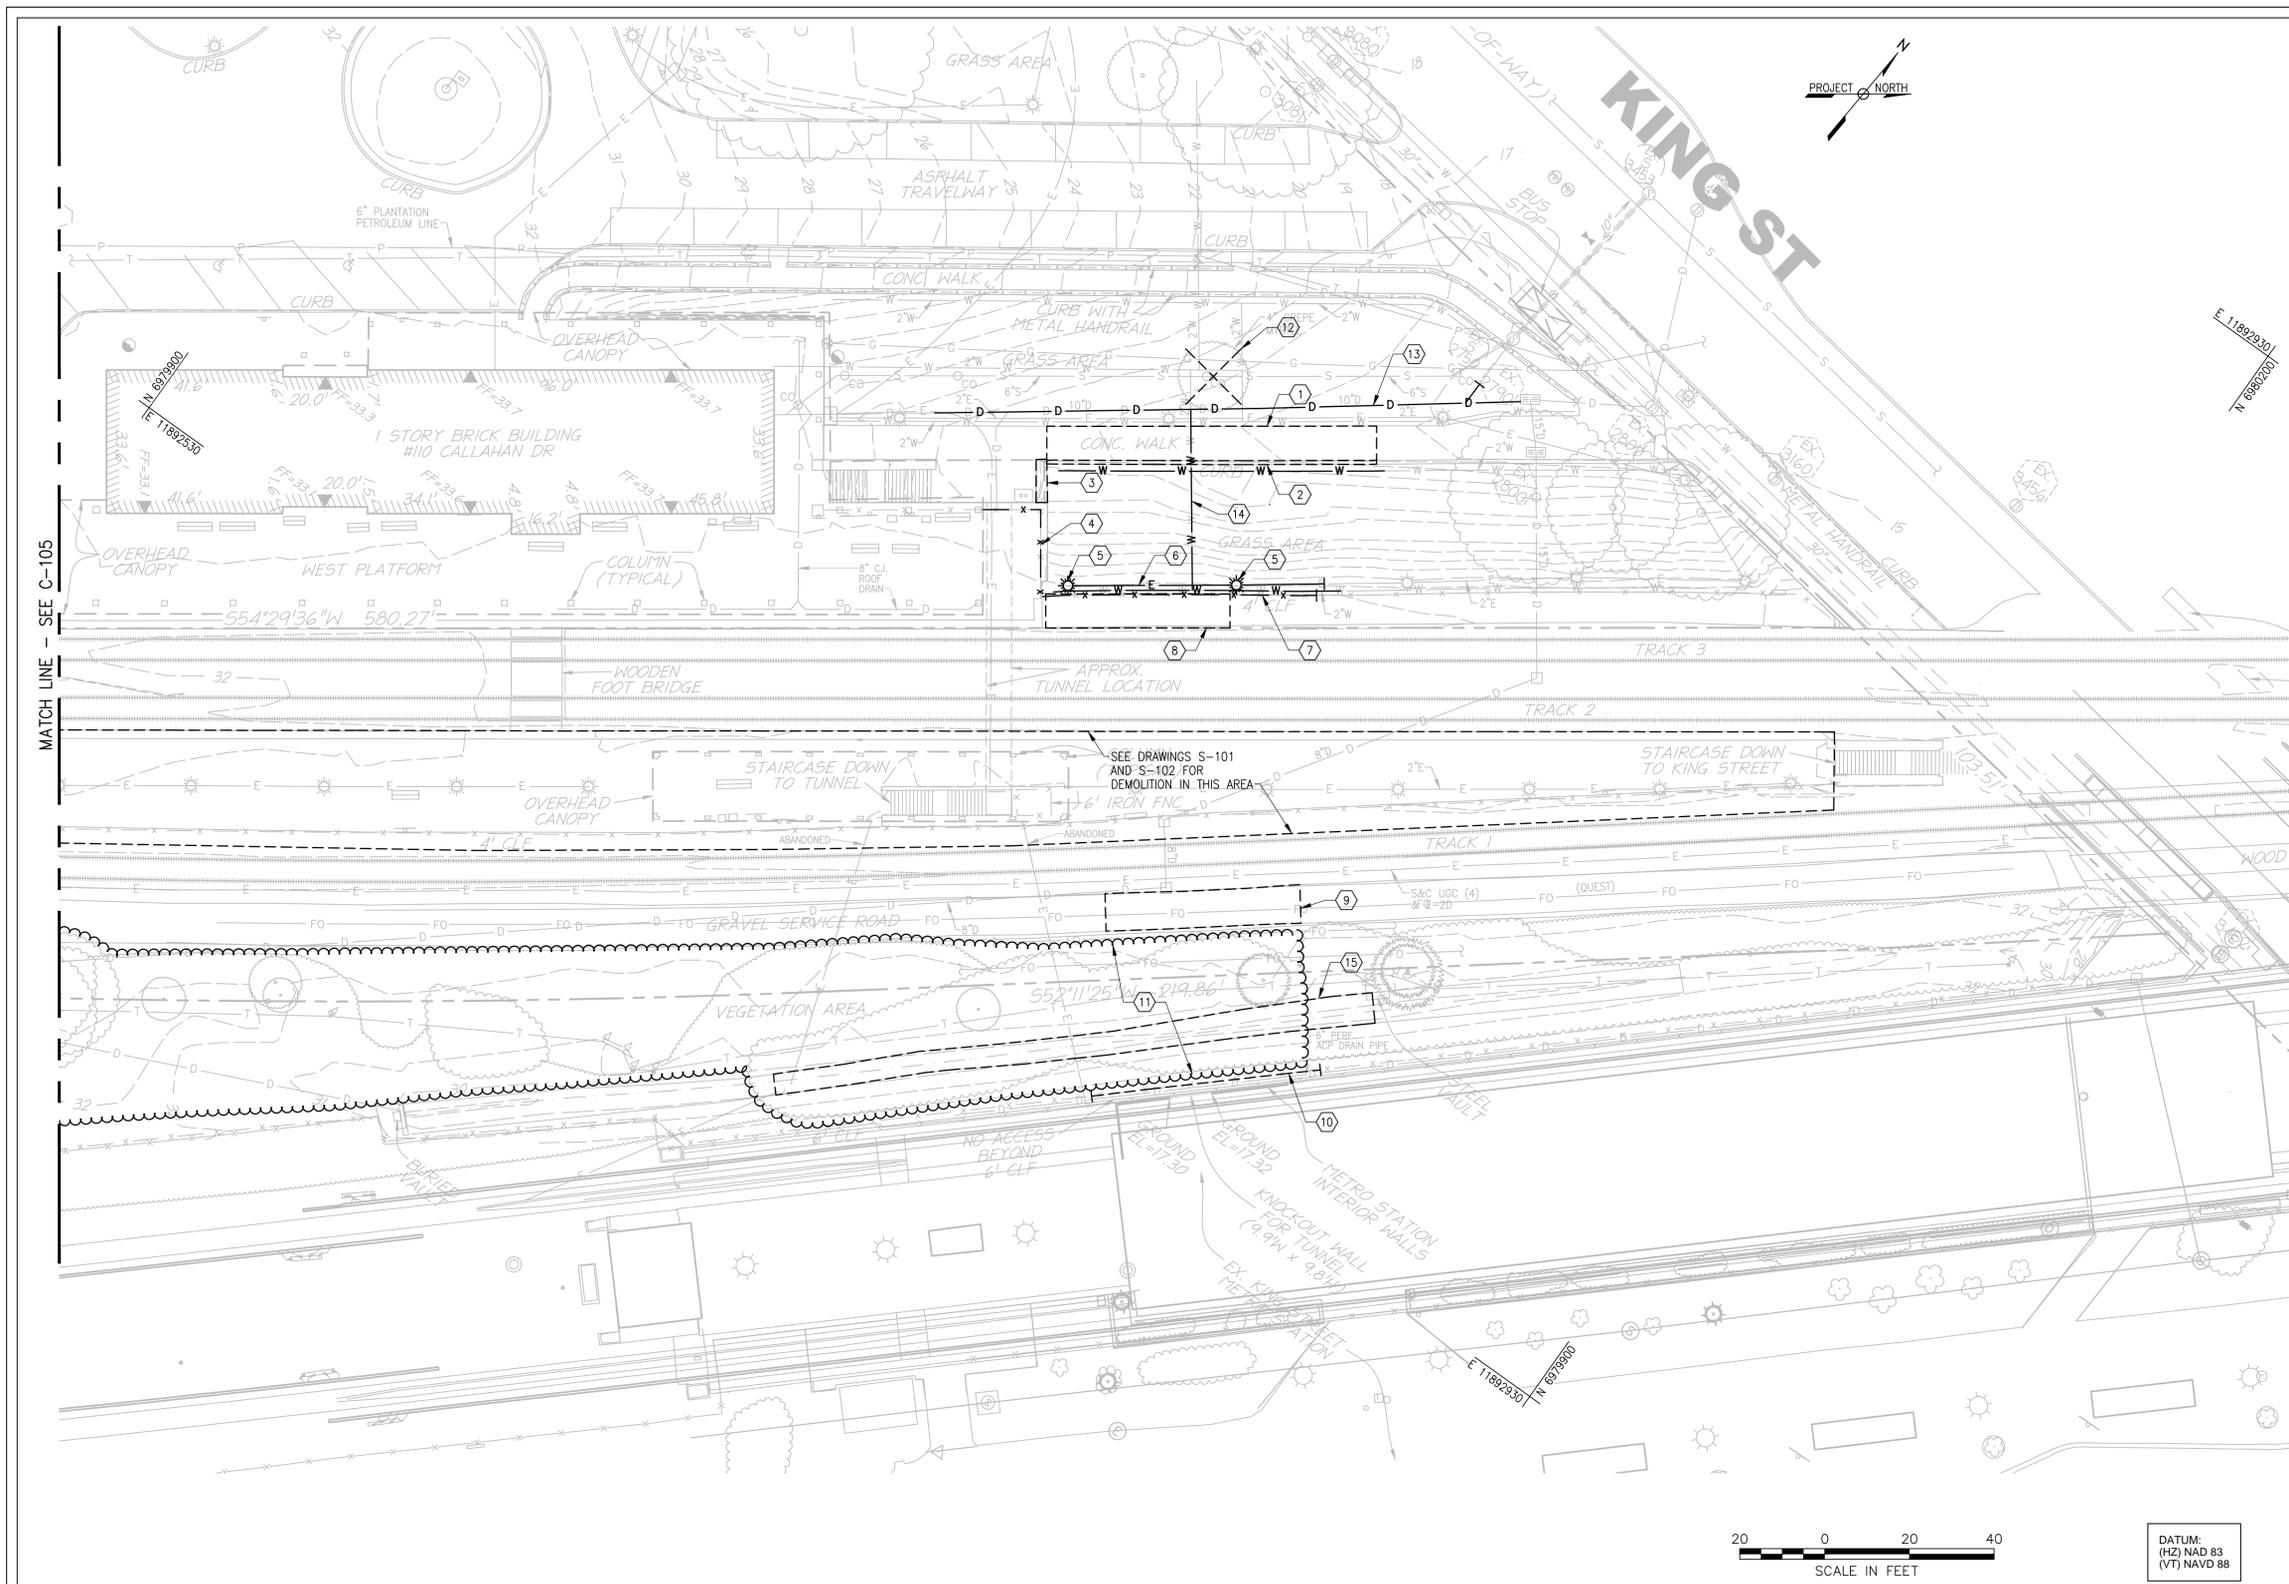

NOTES

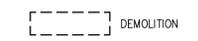1. CONSTRUCTION/DEMOLITION ACTIVITIES CANNOT INTERFERE IN ANYWAY WITH EXISTING RAIL AND PASSENGER TRANSPORT OPERATIONS.
2. ALL NECESSARY EROSION AND SEDIMENT CONTROLS MUST BE IN PLACE AND FUNCTIONAL PRIOR TO COMMENCEMENT OF CONSTRUCTION ACTIVITIES.
3. STRUCTURE DEMOLITION SHALL BE PERFORMED IN ACCORDANCE WITH THE STRUCTURAL DEMOLITION DRAWINGS.
4. PROTECT AND PRESERVE ALL EXISTING UNDERGROUND UTILITY MARKERS.
5. DEMOLISH THE EXISTING CANOPY AS SHOWN ON THE CANOPY DEMOLITION PLAN ON DRAWING NO. S-103 VERIFY.
6. CONTRACTOR TO VERIFY THE LOCATION AND CAP AND SEAL THE EXISTING CANOPY UNDERGROUND.
7. DISPOSAL OF DEMOLITION WASTES SHALL BE ADDRESSED IN ACCORDANCE WITH SPECIFICATION.

DEMOLITION NOTES

- 1 REMOVE 6" THICK CONCRETE SIDEWALK AND AGGREGATE BASE
- 2 REMOVE CONCRETE CURB
- 3 REMOVE MASONRY KNEE WALL
- 4 REMOVE 4' HIGH CHAIN LINK FENCE, POSTS AND FABRIC
- 5 REMOVE LIGHT POLE (SALVAGE AND RE-USE)
- 6 REMOVE CONDUIT AND WIRE
- 7 REMOVE 4' HIGH CHAIN LINK FENCE, POSTS AND FABRIC
- 8 REMOVE CONCRETE PLATFORM
- 9 REMOVE 12" THICK GRAVEL SERVICE ROAD
- 10 REMOVE 6" HIGH CHAIN LINK FENCE
- 11 REMOVE TREES, SHRUBS AND STUMPS
- 12 REMOVE TREE
- 13 REMOVE 10" STORM DRAIN
- 14 REMOVE 2" WATER
- 15 REMOVE DRAINAGE CHANNEL

APPROVED
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DEPARTMENT OF PLANNING & ZONING

DIRECTOR _____ DATE _____
DEPARTMENT OF TRANSPORTATION & ENVIRONMENTAL SERVICES
SITE PLAN NO. DSP2011-0027

DIRECTOR _____ DATE _____

CHAIRMAN, PLANNING COMMISSION _____ DATE _____

DATE RECORDED _____

INSTRUMENT NO. _____ DEED BOOK NO. _____ PAGE NO. _____



DATUM:
(HZ) NAD 83
(VT) NAVD 88

60% SUBMITTAL

CONTRACT NO:		REVISIONS	
PROJECT NO:	BY	NO	DATE
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DESIGNED:	GF	002	6/20/16
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			DEV. CONCEPT PLAN (30%)
			DEV. SITE PLAN




VIRGINIA RAILWAY EXPRESS
ALEXANDRIA
PEDESTRIAN TUNNEL

DISCIPLINE:
CIVIL
DEMOLITION PLAN 1

SCALE: 1"=20'
DATE ISSUED: 6/20/16

DRAWING NO:
C-104
LIST NO:

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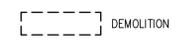


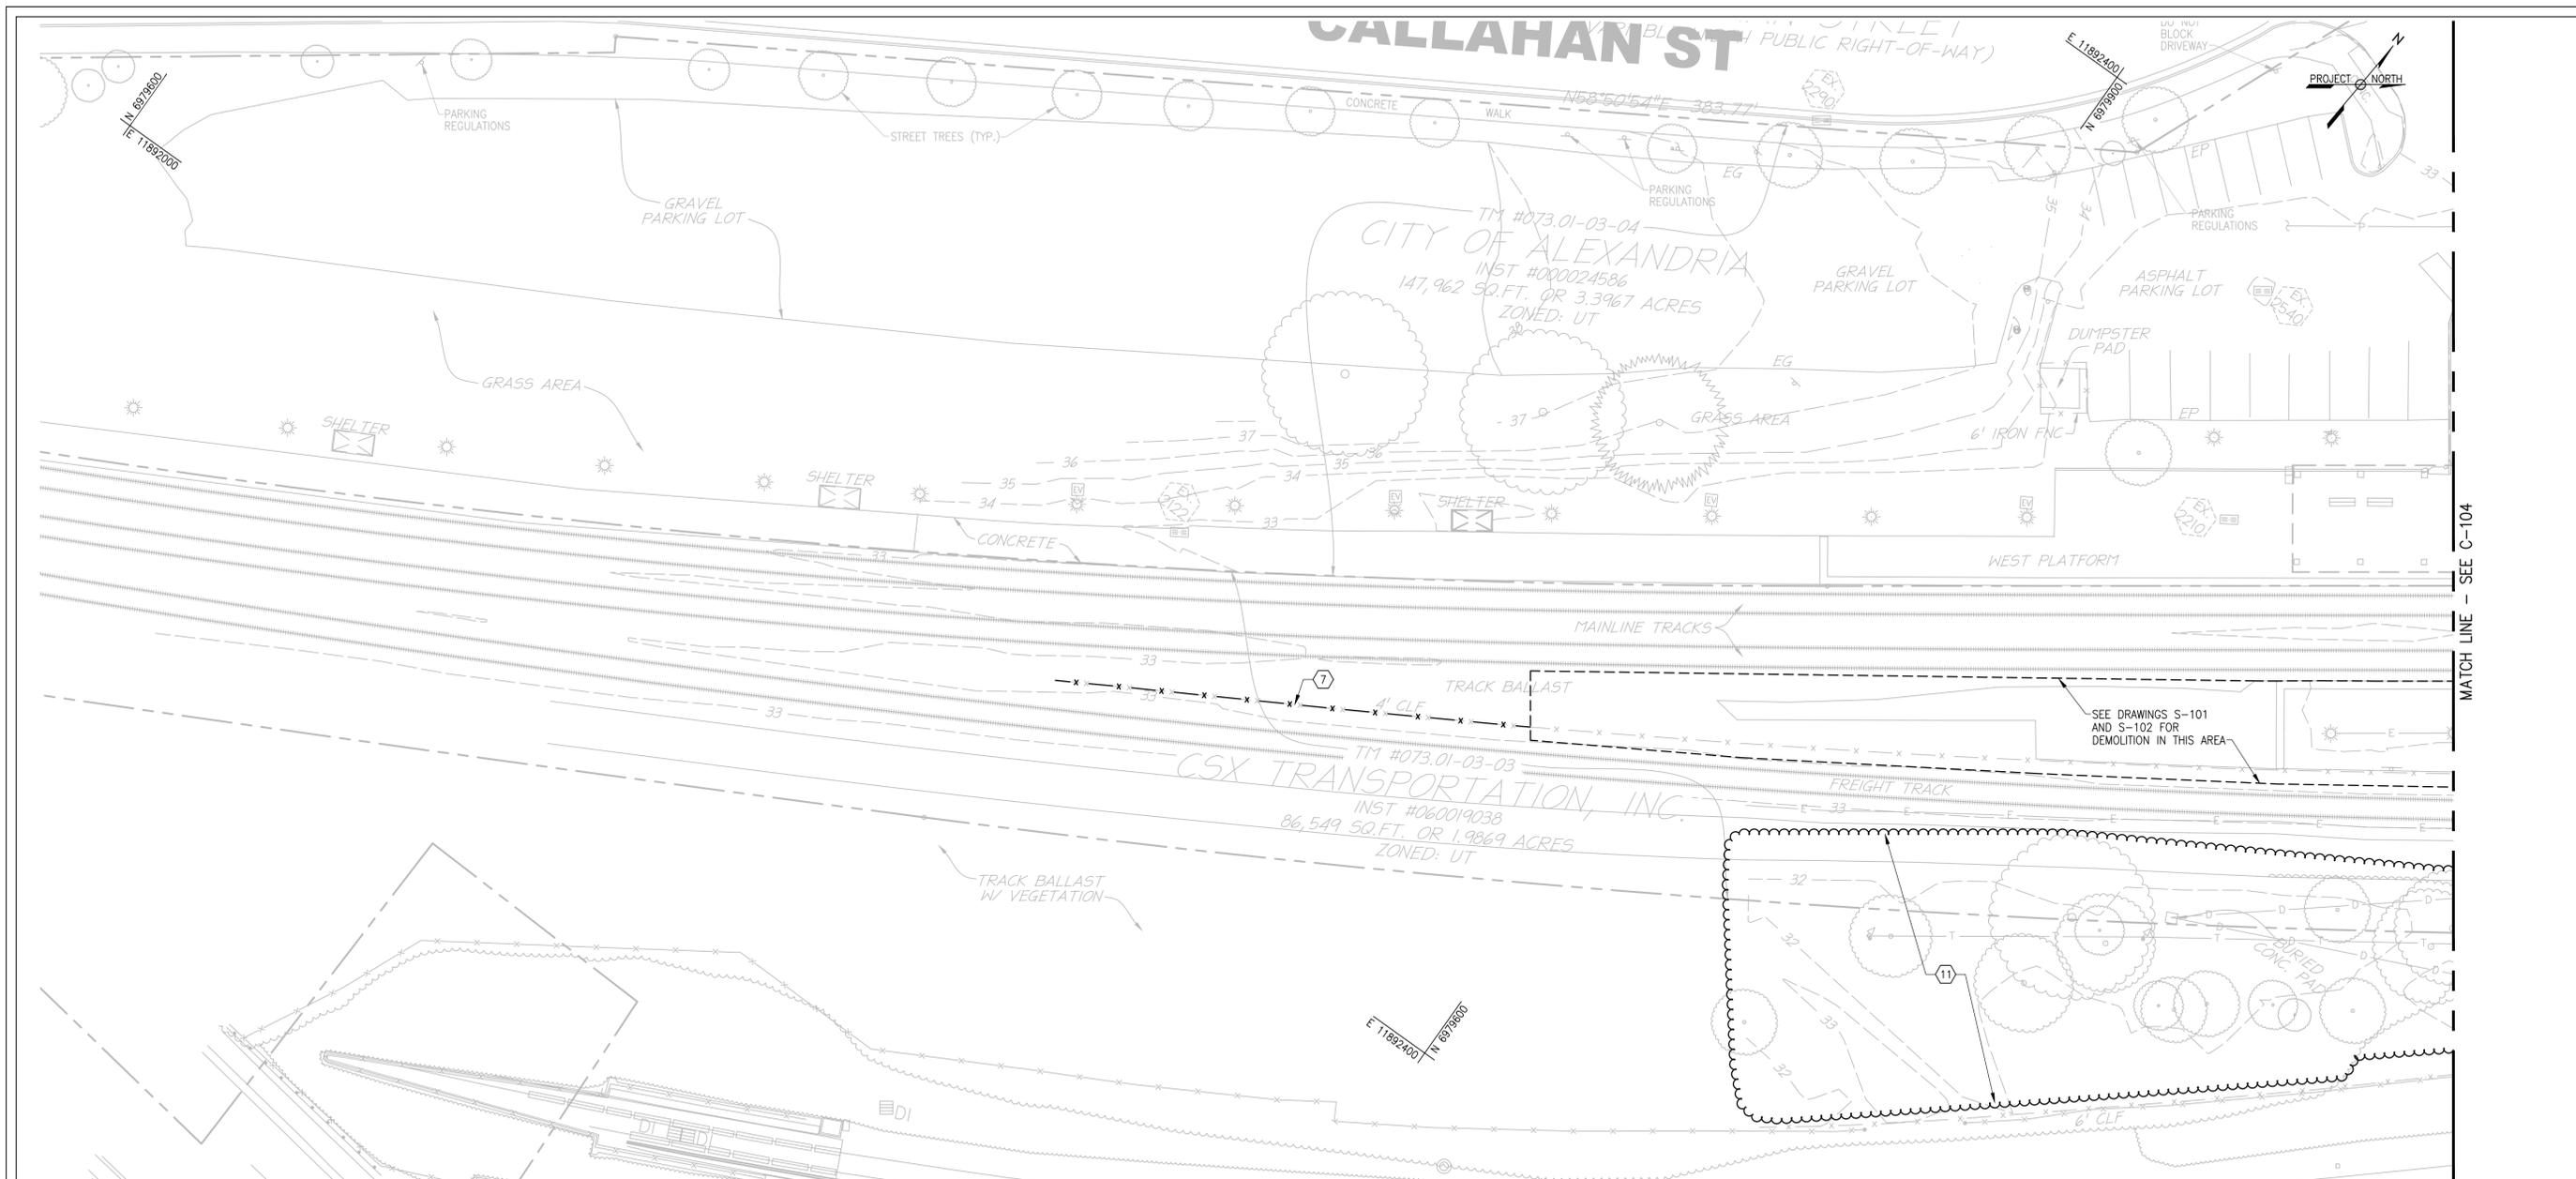MATCH LINE - SEE C-104

NOTES

1. CONSTRUCTION/DEMOLITION ACTIVITIES CANNOT INTERFERE IN ANYWAY WITH EXISTING RAIL OPERATIONS.
2. ALL NECESSARY EROSION AND SEDIMENT CONTROLS MUST BE IN PLACE AND FUNCTIONAL PRIOR TO COMMENCEMENT OF CONSTRUCTION ACTIVITIES.
3. STRUCTURE DEMOLITION SHALL BE PERFORMED IN ACCORDANCE WITH THE STRUCTURAL DEMOLITION DRAWINGS.
4. DISPOSAL OF DEMOLITION WASTES SHALL BE ADDRESSED IN ACCORDANCE WITH SPECIFICATIONS.

LEGEND



DEMOLITION NOTES

- ① REMOVE 6" THICK CONCRETE SIDEWALK AND AGGREGATE BASE
- ② REMOVE CONCRETE CURB
- ③ REMOVE MASONRY KNEE WALL
- ④ REMOVE 4' HIGH CHAIN LINK FENCE, POSTS AND FABRIC
- ⑤ REMOVE LIGHT POLE (SALVAGE)
- ⑥ REMOVE CONDUIT AND WIRE
- ⑦ REMOVE 4' HIGH CHAIN LINK FENCE, POSTS AND FABRIC
- ⑧ REMOVE CONCRETE PLATFORM
- ⑨ REMOVE 12" THICK GRAVEL SERVICE ROAD
- ⑩ REMOVE 6' HIGH CHAIN LINK FENCE
- ⑪ REMOVE TREES, SHRUBS AND STUMPS



DATUM:
(HZ) NAD 83
(VT) NAVD 88

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DIRECTOR _____	DATE _____
DEPARTMENT OF TRANSPORTATION & ENVIRONMENTAL SERVICES	
SITE PLAN NO. <u>DSP2011-0027</u>	
DIRECTOR _____	DATE _____
CHAIRMAN, PLANNING COMMISSION _____	
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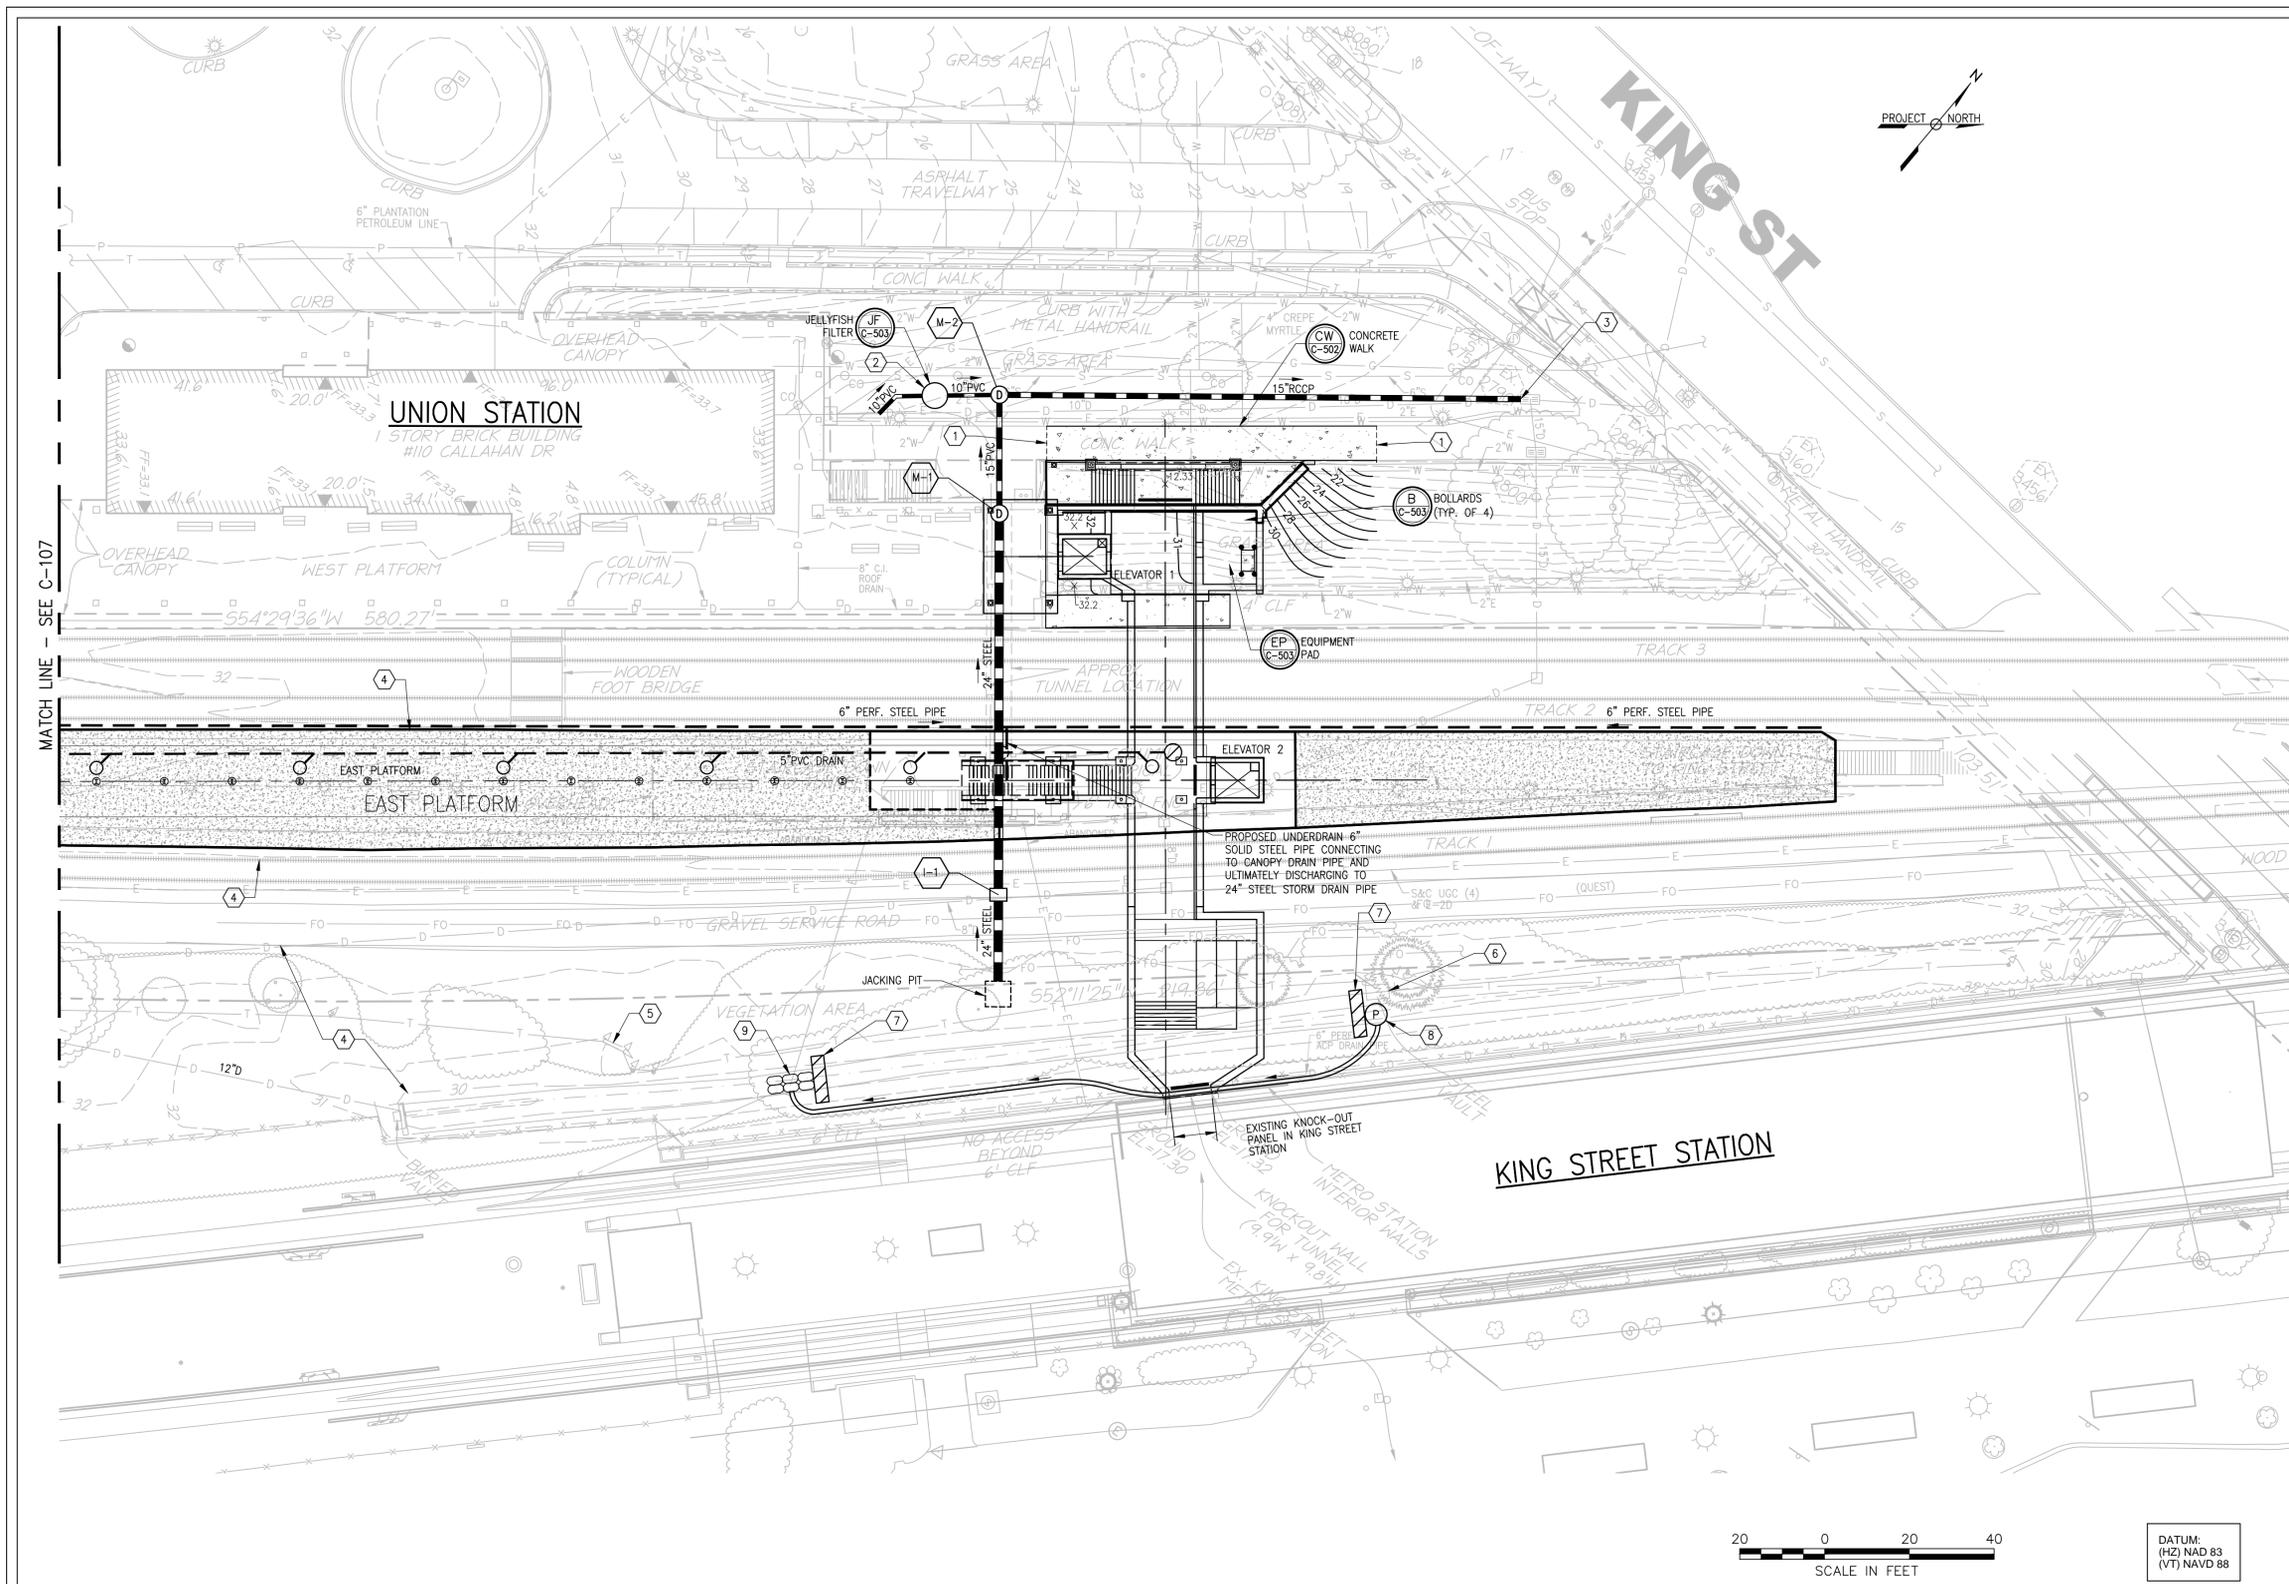
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			DEV. SITE PLAN



VIRGINIA RAILWAY EXPRESS
ALEXANDRIA
PEDESTRIAN TUNNEL

DISCIPLINE:		DRAWING NO:	
CIVIL DEMOLITION PLAN 2		C-105	
SCALE: 1"=20'		DATE ISSUED: 6/20/16	
		LIST NO:	

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- ### CONSTRUCTION NOTES
1. SAW CUT SIDEWALK TO BE REMOVED AT EX. JOINT LOCATION. NEW SIDEWALK TO MATCH EXISTING SIDEWALK ELEVATION.
 2. INSTALL CONTECH JELLYFISH FILTER STORMWATER FILTRATION SYSTEM, MODEL JF6-4-1, PER THE LOCATION AND ELEVATIONS APPROVED, AND IN ACCORDANCE WITH THE MANUFACTURER'S RECOMMENDATIONS, STANDARD DETAILS, AND GENERAL NOTES HEREON.
 3. CONNECT TO EXISTING STORM DRAIN INLET.
 4. RESTORE DISTURBED SURFACE WITH 12" BALLAST.
 5. PROTECT EXISTING UTILITY MARKERS.
 6. PROTECT EXISTING UTILITY VAULT.
 7. SAND BASE DIKE AT LIMITS OF OPEN CHANNEL TO REMAIN.
 8. PUMP AROUND - PUMP AND FORCE MAIN.
 9. RIP RAP SPLASH PAD AT FORCE MAIN DISCHARGE.

- ### GENERAL NOTES
1. CALL ALEXANDRIA ARCHAEOLOGY IF ARTIFACTS OR OLD STRUCTURAL REMAINS ARE UNCOVERED. NO METAL DETECTING, OTHER THAN UTILITY LOCATING, ALLOWED DURING THE PROJECT.
 2. ALLOW NO METAL DETECTING ON THE PROPERTY WITHOUT AUTHORIZATION OF ALEXANDRIA ARCHAEOLOGY.

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DATUM:
(HZ) NAD 83
(VT) NAVD 88

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VIRGINIA RAILWAY EXPRESS
ALEXANDRIA
PEDESTRIAN TUNNEL


DISCIPLINE:
CIVIL
GRADING AND DRAINAGE PLAN 1

SCALE: 1"=20'

DATE ISSUED: 6/20/16

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C-106
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CONSTRUCTION NOTES

① RESTORE SURFACE TO EXISTING GRADE. STABILIZE WITH 12" BALLAST.

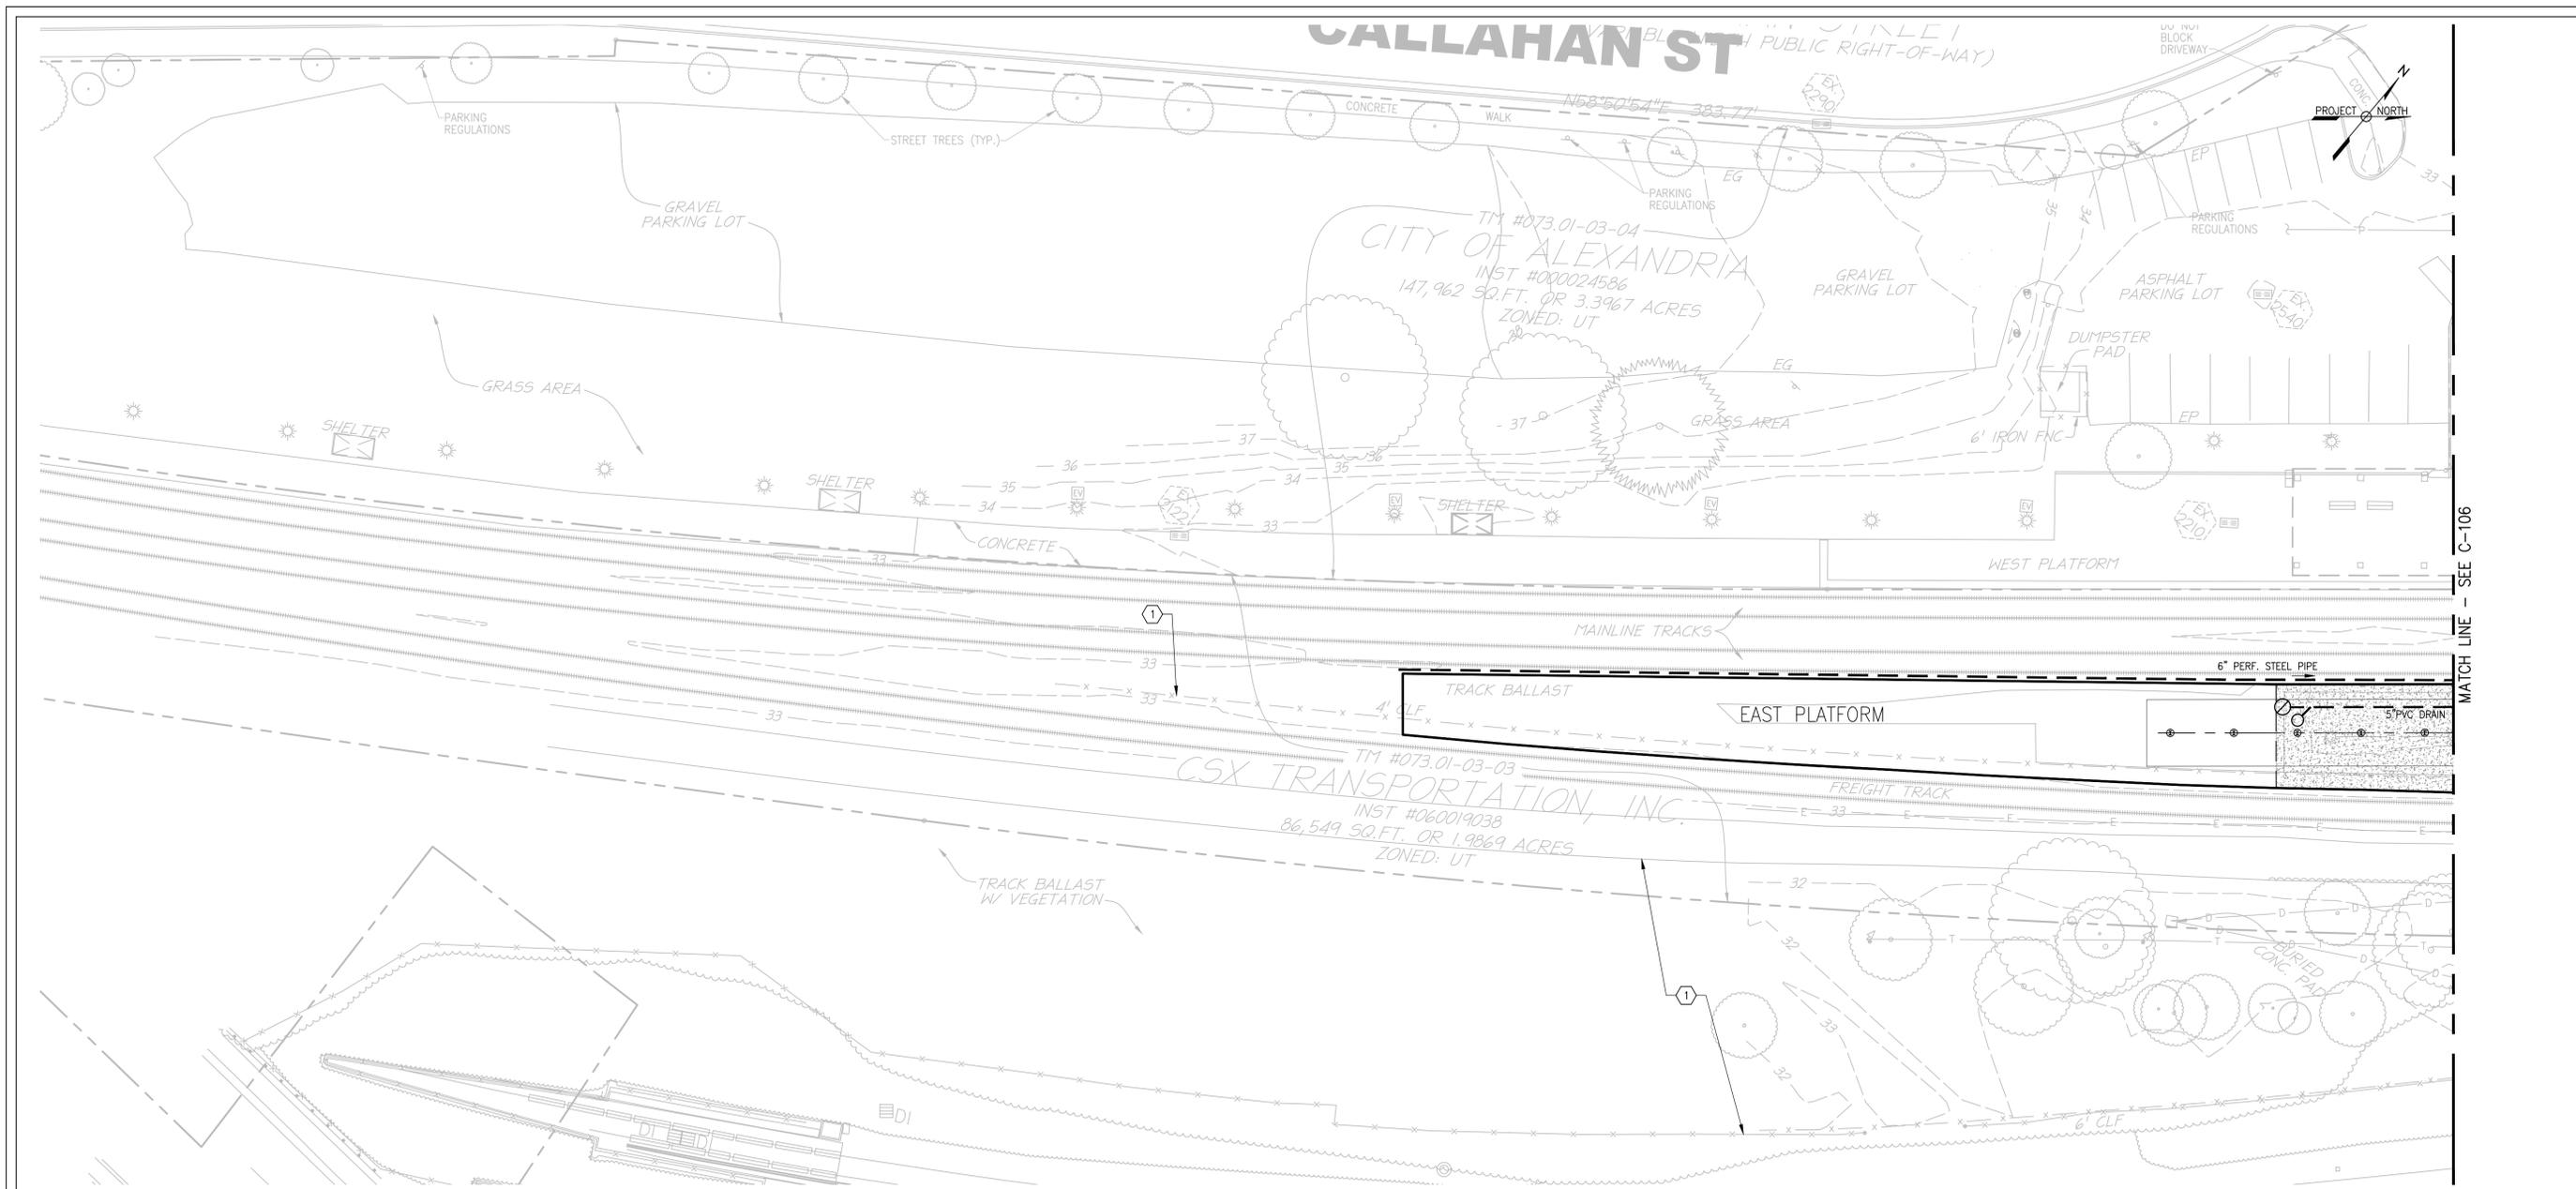GENERAL NOTES

1. CALL ALEXANDRIA ARCHAEOLOGY IF ARTIFACTS OR OLD STRUCTURAL REMAINS ARE UNCOVERED. NO METAL DETECTING, OTHER THAN UTILITY LOCATING, ALLOWED DURING THE PROJECT.

2. ALLOW NO METAL DETECTING ON THE PROPERTY WITHOUT AUTHORIZATION OF ALEXANDRIA ARCHAEOLOGY.



DATUM:
(HZ) NAD 83
(VT) NAVD 88

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VIRGINIA RAILWAY EXPRESS
ALEXANDRIA
PEDESTRIAN TUNNEL



DISCIPLINE:
**CIVIL
GRADING AND DRAINAGE PLAN 2**



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C-107

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STRUCTURES			
PNT NO	NORTH	EAST	DESCRIPTION
100	N 6980009.8853	E 11892679.2881	JELLYFISH FILTER
101	N 6980018.9142	E 11892691.5949	DRAINAGE MANHOLE M-2
102	N 6979996.1774	E 11892707.7576	DRAINAGE MANHOLE M-1
103	N 6979923.1676	E 11892759.5314	INLET I-1
104	N 6979906.6033	E 11892771.2777	24" RCP



DATUM:
(HZ) NAD 83
(VT) NAVD 88

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DIRECTOR _____	DATE _____
DEPARTMENT OF TRANSPORTATION & ENVIRONMENTAL SERVICES SITE PLAN NO. <u>DSP2011-0027</u>	
DIRECTOR _____	DATE _____
CHAIRMAN, PLANNING COMMISSION _____ DATE _____	
DATE RECORDED _____	
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GF	001		DEV. CONCEPT PLAN (30%)
GF	002	6/20/16	DEV. SITE PLAN

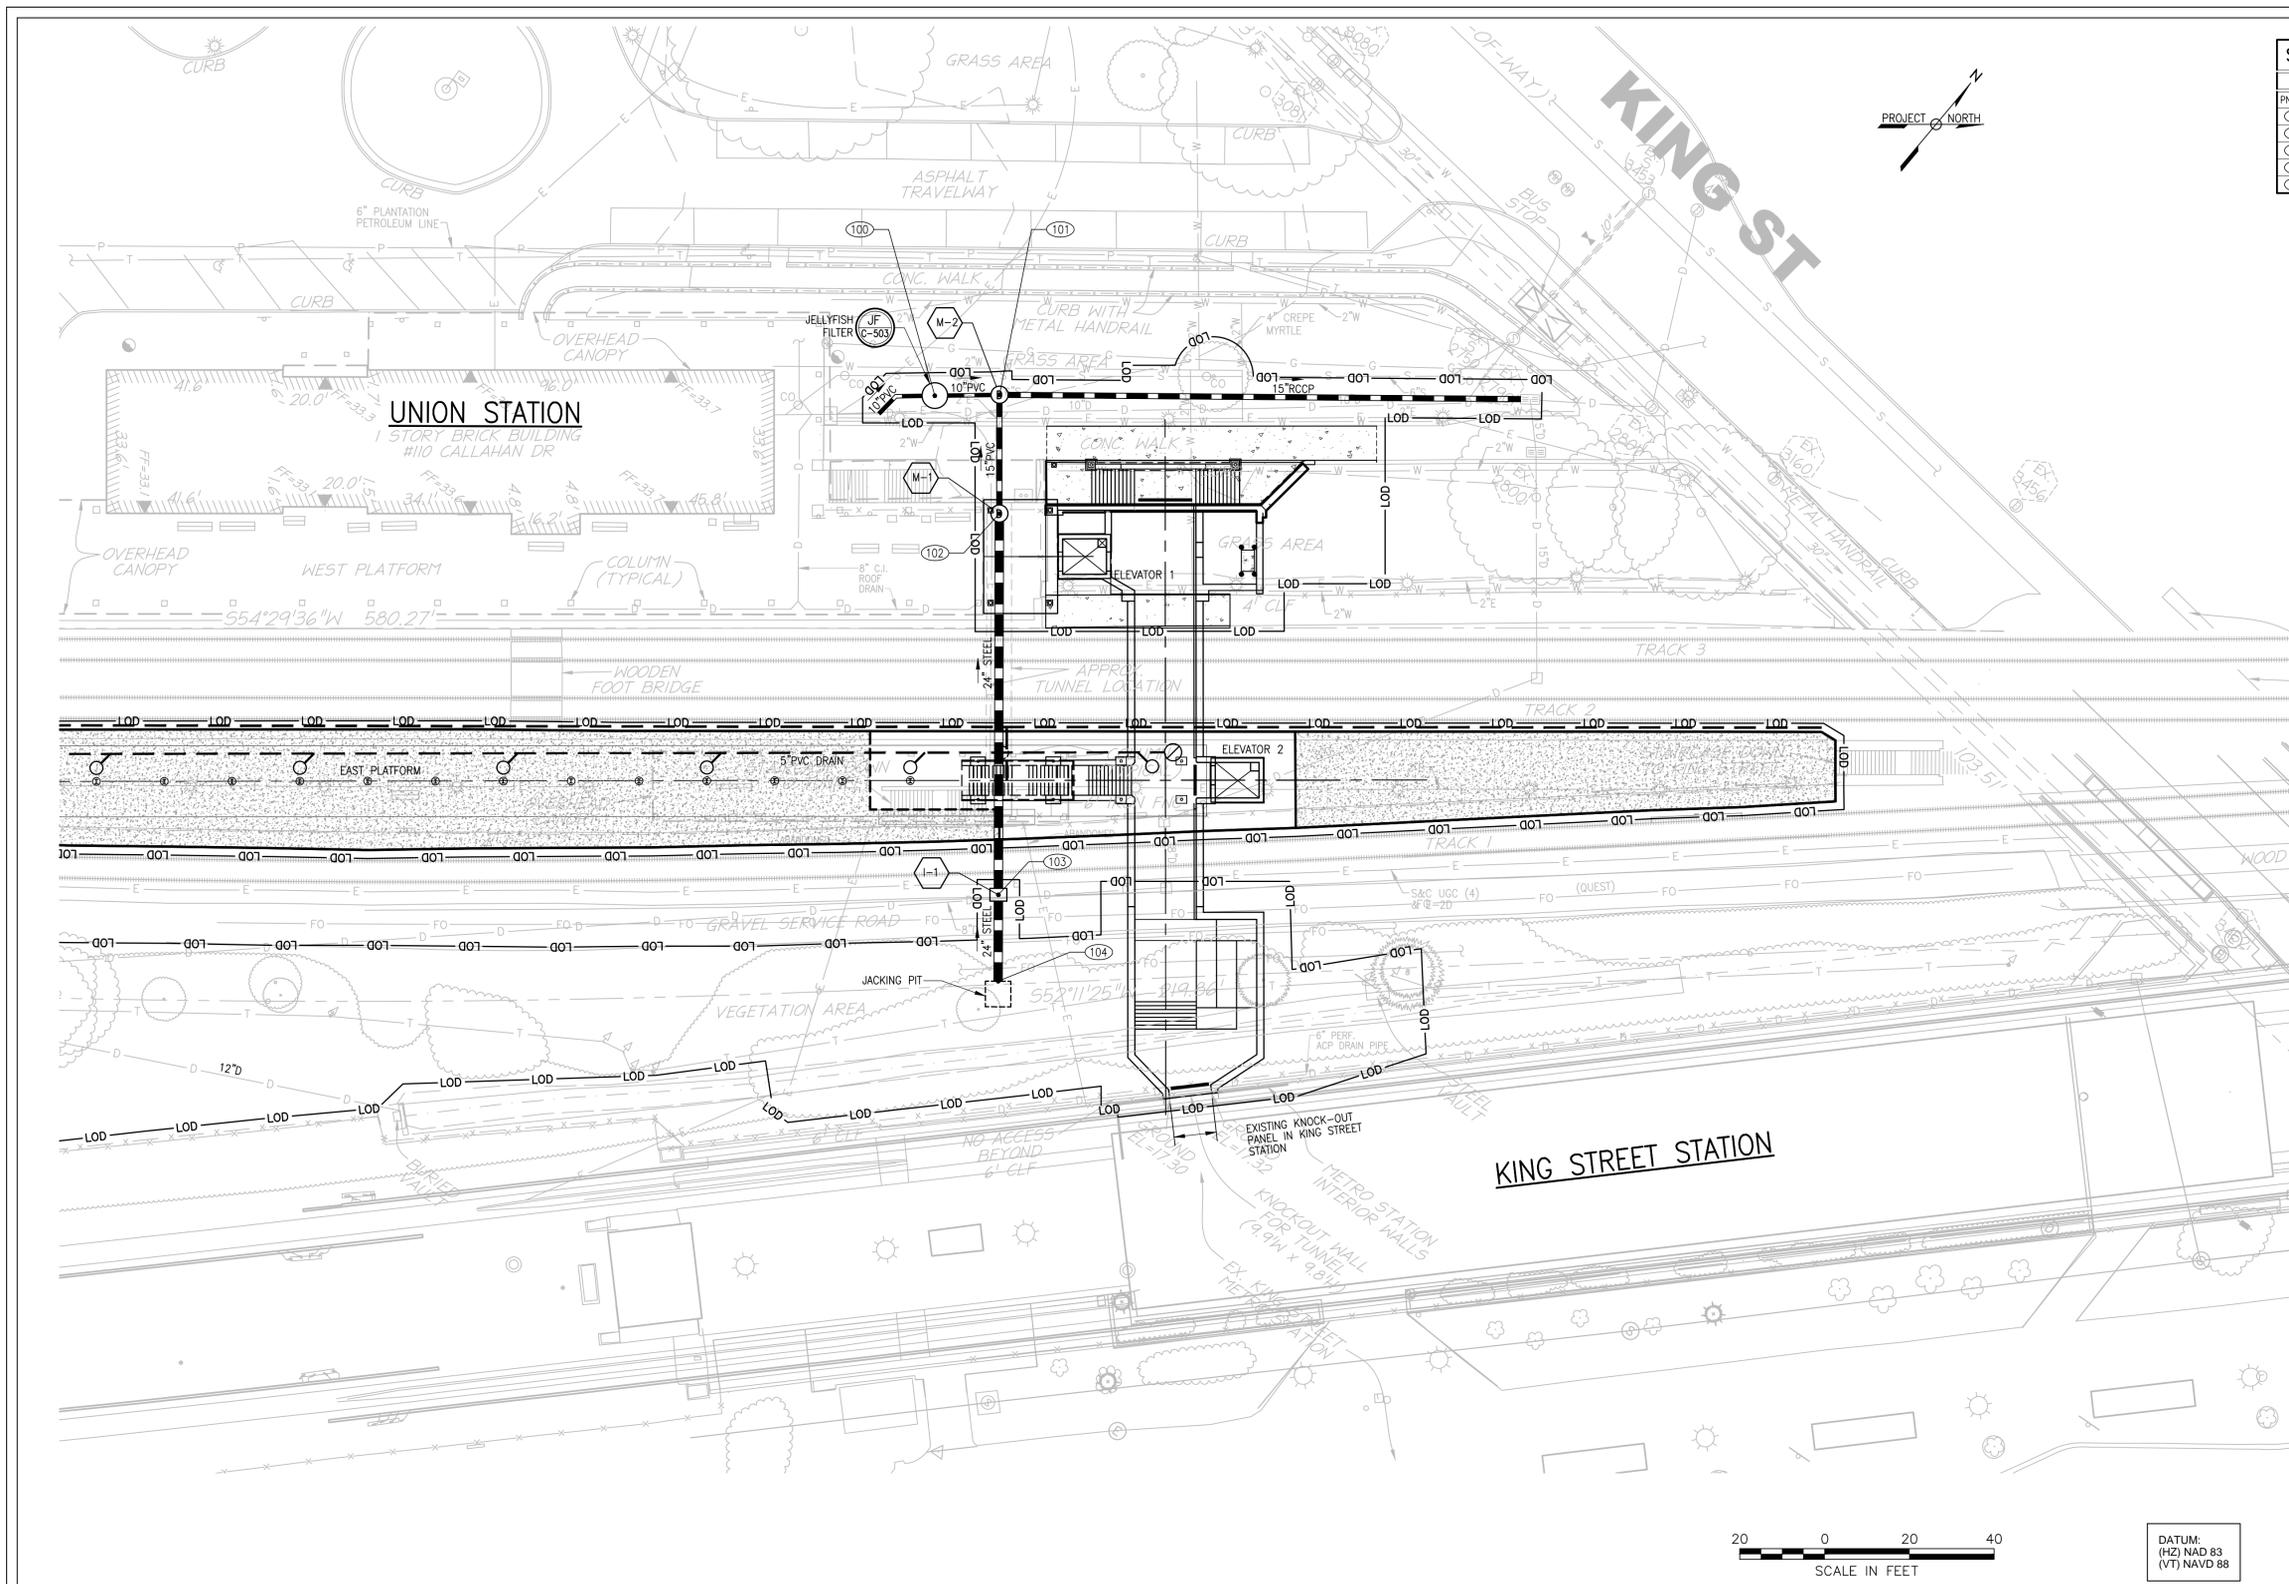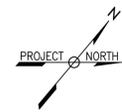


VIRGINIA RAILWAY EXPRESS
ALEXANDRIA
PEDESTRIAN TUNNEL

DISCIPLINE:
CIVIL
STAKEOUT PLAN

SCALE:	1"=20'	DATE ISSUED:	6/20/16
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DRAWING NO:	C-109
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STORMWATER MANAGEMENT PLAN NOTES:

1. IN COMPLIANCE WITH ARTICLE XIII OF THE ZONING ORDINANCE, A REQUEST TO WAIVE THE STORMWATER QUANTITY REQUIREMENT IS PRESENTED ON SHEET C-111.
2. SHEET C-111 PROVIDES DETAILS FOR THE WATER QUALITY ASSESSMENT AND EXHIBIT, AND SHEET C-120 PRESENTS VRRM WORKSHEETS.
3. DUE TO SITE CONSTRAINTS, THE PROPOSED BMP IS UNABLE TO COLLECT AND TREAT ON-SITE IMPERVIOUS AREA. TO OFFSET, A GREATER AMOUNT OF OFF-SITE IMPERVIOUS AREA IS UTILIZED TO TREAT AND THUS MEET BEYOND THE WATER QUALITY REQUIREMENTS. THE TARGET REDUCTION IS EXCEEDED BY 0.4 LB/YEAR.
4. WATER QUALITY FOR THE ENTIRE PROJECT SITE IS PROVIDED BY ONE MANUFACTURED BMP - JELLYFISH FILTER.

BMP SYSTEM JELLYFISH FILTER NOTES:

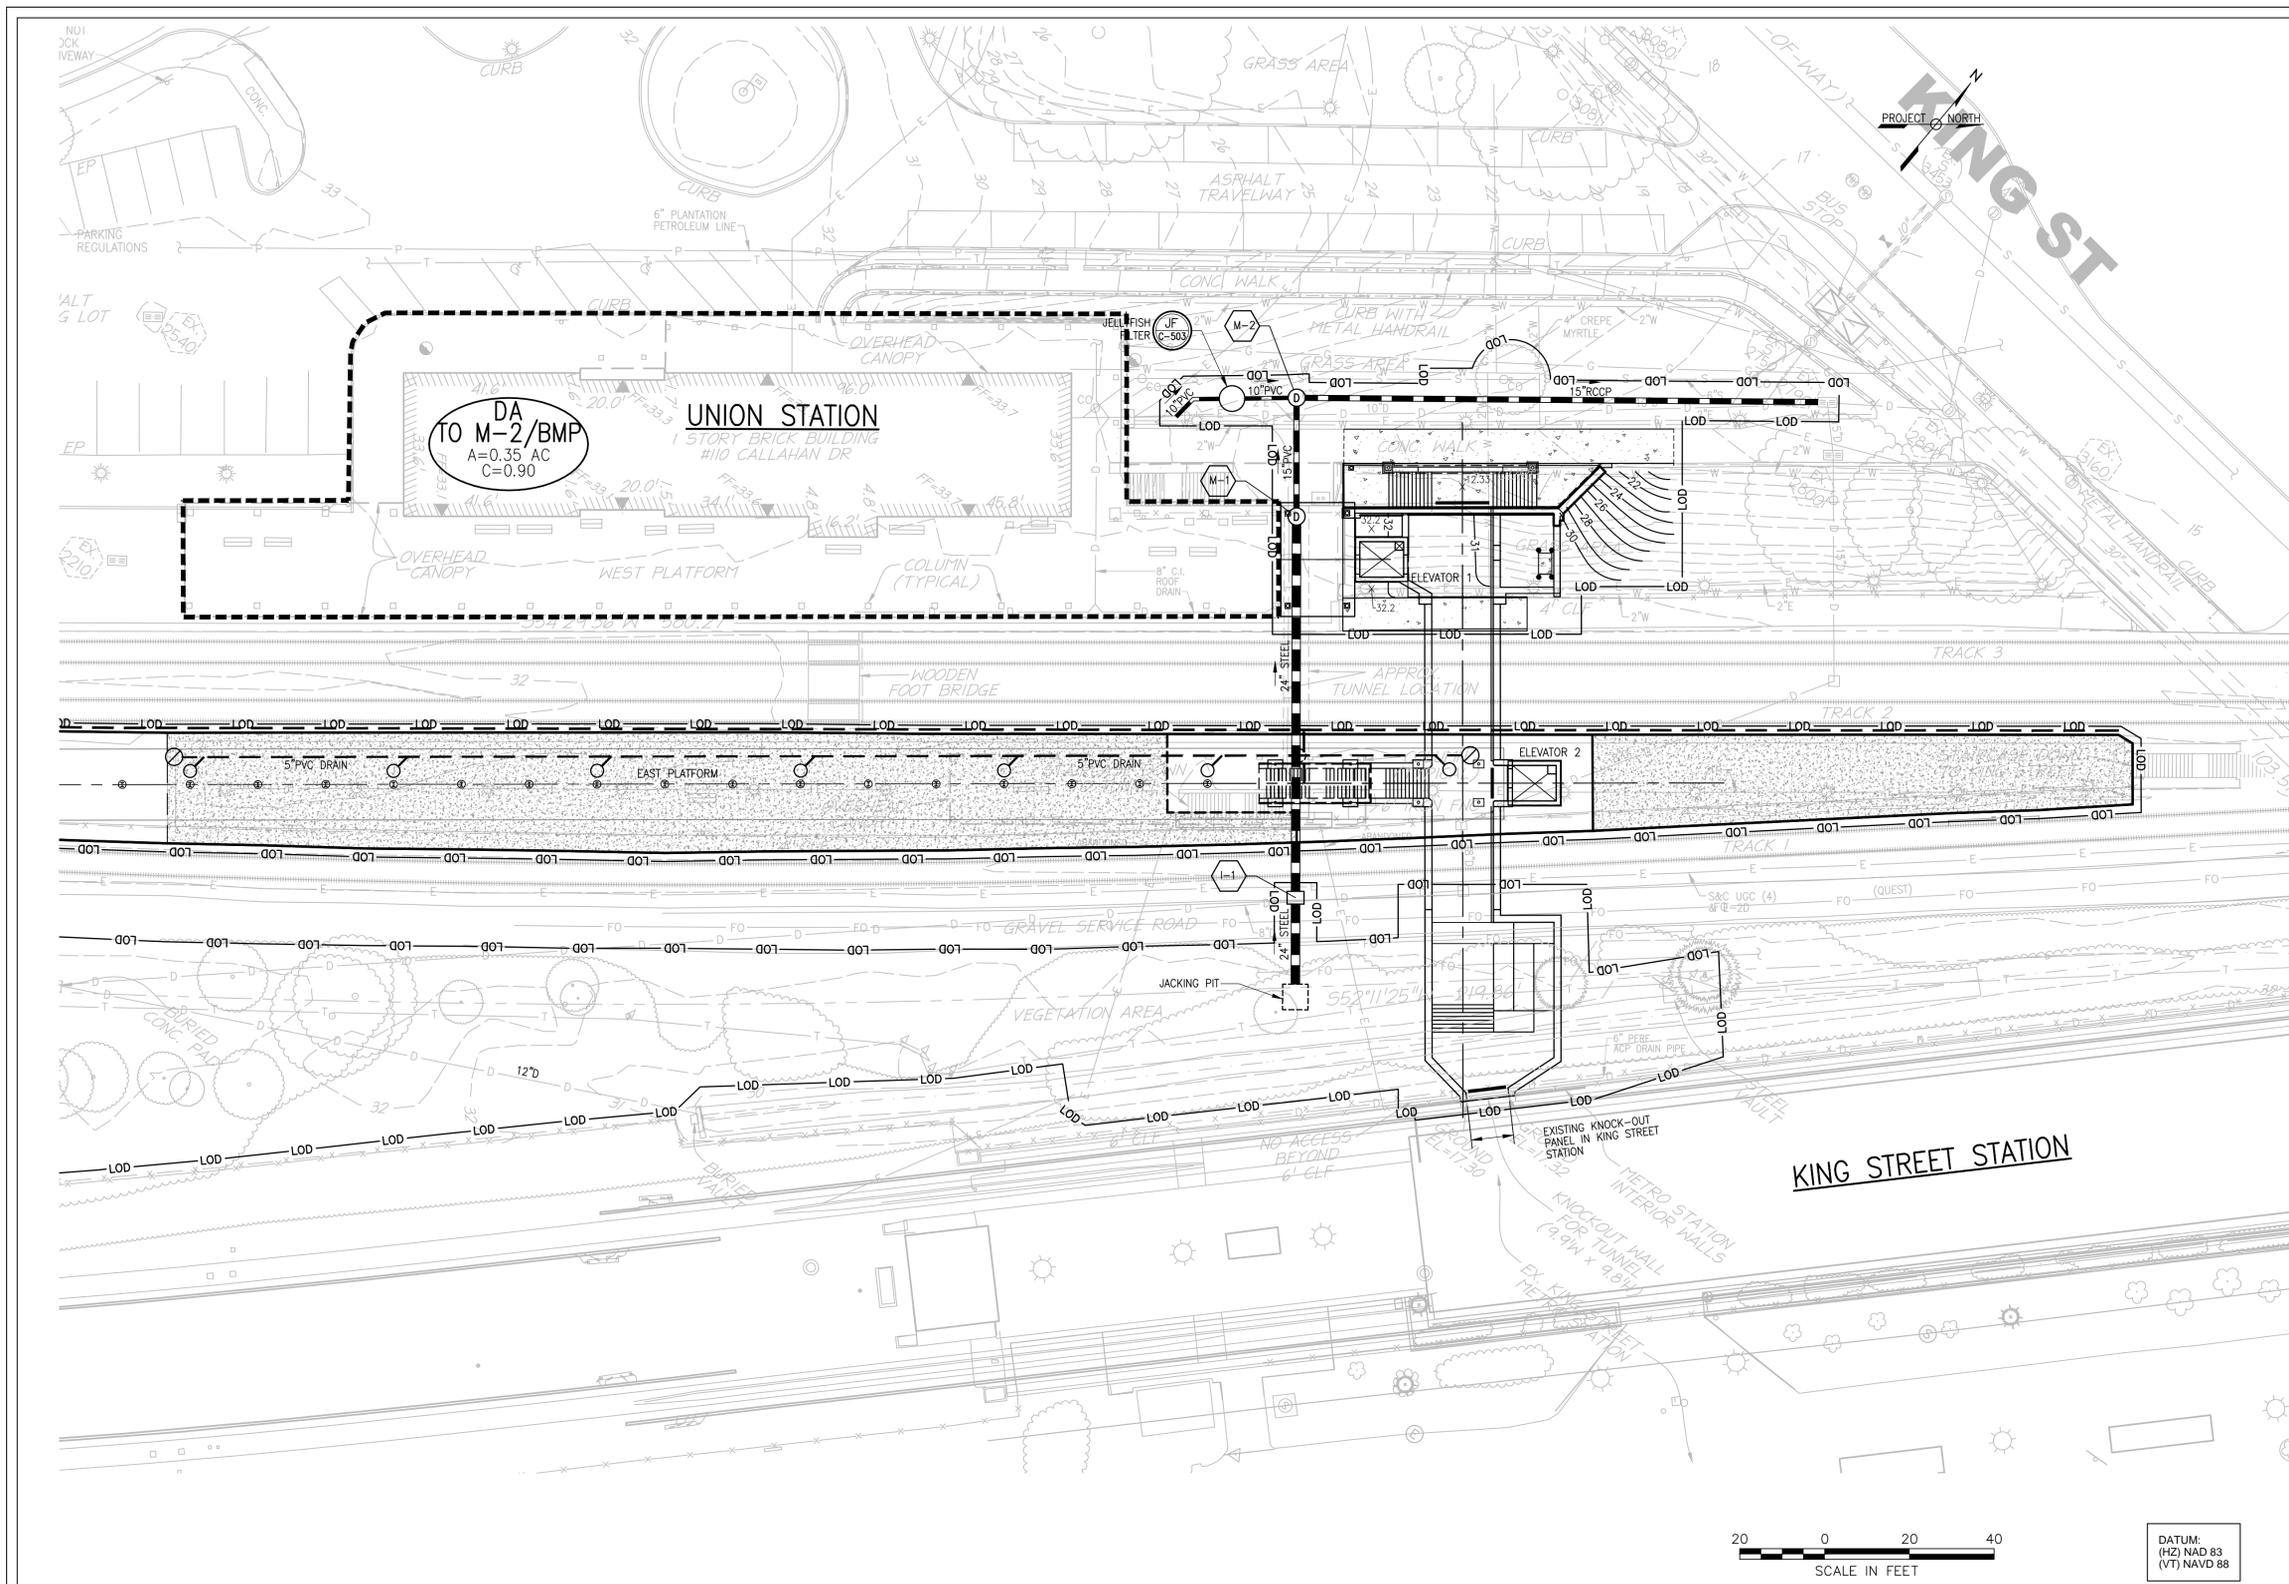1. THE STORMWATER QUALITY TREATMENT SHALL BE PROVIDED UTILIZING THE VIRGINIA DEPARTMENT OF ENVIRONMENTAL QUALITY (VA DEQ) AND THE CITY OF ALEXANDRIA APPROVED MANUFACTURED BMP SYSTEM JELLYFISH FILTER. THE JELLYFISH FILTER IS A STORMWATER QUALITY TREATMENT TECHNOLOGY IS A HIGH FLOW PRETREATMENT AND MEMBRANE FILTRATION IN A COMPACT STAND-ALONE SYSTEM. JELLYFISH REMOVES FLOATABLES, TRASH, OIL, DEBRIS, TSS, FINE SILT-SIZED PARTICLES, AND A HIGH PERCENTAGE OF PARTICULATE-BOUND POLLUTANTS, INCLUDING PHOSPHORUS, NITROGEN, METALS, AND HYDROCARBONS. THE BMP STRUCTURAL DETAILS, INSTALLATION NOTES, AND GENERAL NOTES ARE PROVIDED ON SHEET C-503.
2. THE STORMWATER BEST MANAGEMENT PRACTICE (BMP) REQUIRED FOR THIS PROJECT SHALL BE CONSTRUCTED AND INSTALLED UNDER THE DIRECT SUPERVISION OF THE DESIGN ENGINEER OR HIS DESIGNATED REPRESENTATIVE. THE DESIGN ENGINEER SHALL MAKE A WRITTEN CERTIFICATION TO THE CITY THAT THE BMP IS CONSTRUCTED AND INSTALLED AS DESIGNED AND IN ACCORDANCE WITH THE APPROVED SITE PLAN. IN ADDITION, AGGREGATE LAYERS AND COLLECTOR PIPES MAY NOT BE INSTALLED UNLESS THE DESIGN ENGINEER OR HIS REPRESENTATIVE IS PRESENT.
3. THE CONTRACTOR SHALL FURNISH THE CITY WITH AN OPERATION AND MAINTENANCE MANUAL FOR THE PROPOSED BMP ON THE PROJECT. THE MANUAL SHALL INCLUDE AN EXPLANATION OF THE FUNCTIONS AND OPERATIONS OF THE BMP AND ANY SUPPORTING UTILITIES, CATALOGUE CUTS ON ANY MECHANICAL OR ELECTRICAL EQUIPMENT AND A SCHEDULE OF ROUTINE MAINTENANCE FOR THE BMP AND SUPPORTING EQUIPMENT.

PROPOSED STORM DRAIN SYSTEM NOTES:

1. COMPUTATION OF PEAK RUNOFF RATE: THE POST DEVELOPMENT PEAK RATE OF RUNOFF IS COMPUTED BY THE RATIONAL METHOD IN ACCORDANCE WITH THE VDOT HYDRAULIC DESIGN ADVISORY HDA 05-03. THE "ATLAS 14" RAINFALL PRECIPITATION FREQUENCY DATA, PUBLISHED B, D, & E FACTORS AVAILABLE FOR NEAREST LOCATION TO THE PROJECT SITE ARE CHOSEN, AND EMPLOYED FOR RECURRENCE INTERVAL STORM DURATIONS.
2. IN COMPLIANCE WITH CSX DESIGN REQUIREMENT: THE PROPOSED STORM SEWER SYSTEM, FROM STRUCTURE I-1 TO EXISTING 2790, IS PARTIALLY LOCATED IN CSX PROPERTY. THE SYSTEM CAPACITY IS SUFFICIENTLY DESIGNED FOR 100 YEAR STORM INCIDENCE PROBABILITY AND THUS MEET CSX DESIGN REQUIREMENT.
3. STORM SEWER COMPUTATIONS: THE VDOT STORM-SEWER WORKSHEET, LD-229, IS EMPLOYED TO COMPUTE THE PROPOSED STORM DRAINAGE SYSTEM. AN INLET TIME OF CONCENTRATION OF 5 MINUTES IS USED FOR THIS ULTRA-URBAN ENVIRONMENT SETTING. ALL HYDROLOGIC ANALYSES RELATE TO PRE AND POST DEVELOPMENT ARE BASED ON THE EXISTING WATERSHED CHARACTERISTICS AND THE ULTIMATE DEVELOPMENT OF THE PROJECT.
4. CIVIL DRAINAGE AREA MAP, SHEET C-112, DEMONSTRATES THE DRAINAGE DIVIDE AREAS TO EACH STRUCTURES OF THE SYSTEM.

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DIRECTOR: _____ DATE: _____
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SITE PLAN NO. DSP2011-0027

DIRECTOR: _____ DATE: _____

CHAIRMAN, PLANNING COMMISSION: _____ DATE: _____

DATE RECORDED: _____

INSTRUMENT NO. _____ DEED BOOK NO. _____ PAGE NO. _____

60% SUBMITTAL

CONTRACT NO:	REVISIONS			
PROJECT NO:	BY	NO	DATE	DESCRIPTION
DESIGNED:	GF	001		DEV. CONCEPT PLAN (30%)
DRAFTED:	GF	002	6/20/16	DEV. SITE PLAN
CHECKED:				
APPROVED:				



VIRGINIA RAILWAY EXPRESS
ALEXANDRIA
PEDESTRIAN TUNNEL

DISCIPLINE:
CIVIL
STORMWATER MANAGEMENT PLAN

SCALE: 1"=20'

DATE ISSUED: 6/20/16

DRAWING NO:
C-110
LIST NO:

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WATER QUALITY NARRATIVE


THE PROJECT INVOLVES CONSTRUCTION OF A NEW PEDESTRIAN TUNNEL LINKING THE VRE UNION STATION (110 CALLAHAN DRIVE) WITH THE WMATA KING STREET STATION (1900 KING STREET) IN ALEXANDRIA, VA. ADDITIONAL WORK INVOLVES 2 FOOT WIDENING OF 150 LINEAR FEET OF THE EXISTING EAST PLATFORM. FURTHER, THE EXISTING PLATFORM CANOPY WILL BE EXPANDED BY 300 LINEAR FEET.

THIS PROJECT IS A LINEAR PROJECT AND IT OUTFALLS TO HOOFF'S RUN. THE PROJECT WILL HAVE A NEGLIGIBLE IMPACT ON THE POTOMAC RIVER WATERSHED. THE PROJECT IS CONSIDERED RE-DEVELOPMENT AND IT WILL MINIMIZE ADVERSE IMPACTS ON WATER QUALITY AND DISCHARGE TO THE POTOMAC RIVER. THE RUNOFF REDUCTION METHOD REDEVELOPMENT SUMMARY WORKSHEET IS USED TO PERFORM THE WATER QUALITY ASSESSMENT, INCLUDED ON SHEET C-120. THE STORMWATER MANAGEMENT WATER QUALITY TREATMENT REQUIREMENT SHALL BE ACHIEVED ENTIRELY BY UTILIZING ONE (1) 6 FOOT DIAMETER JELLYFISH FILTER UNIT. THIS STRUCTURE IS TO PROVIDE UP TO 50% EFFICIENCY (AS PER THE CITY OF ALEXANDRIA GUIDANCE) IN REMOVING POLLUTANTS FROM THE STORMWATER RUNOFF. THE PROPOSED BMP STRUCTURE SHALL BE INSTALLED AND CONNECTED TO THE EXISTING CLOSED CONDUIT STORM SEWER SYSTEM. A BIENNIAL MAINTENANCE WILL INCLUDE REMOVING TRASH AND DEBRIS AND REPLACING THE MULCH INSIDE THE STRUCTURE.

AS PRESENTED ON SHEET C-120, THE TOTAL SITE (PROJECT) AREA IS 0.27 ACRES. THE TOTAL IMPERVIOUS AREAS IN PRE-DEVELOPMENT AND POST-DEVELOPMENT CONDITIONS ARE 0.13 ACRE AND 0.18 ACRE, RESPECTIVELY. THE VIRGINIA RUNOFF REDUCTION METHOD RE-DEVELOPMENT WORKSHEET IS EMPLOYED FOR THE WATER QUALITY ASSESSMENT AND COMPLIANCE CALCULATION. THE MANUFACTURED BMP JELLYFISH FILTER, WITH AN EFFICIENCY OF 50%, IS UTILIZED TO REDUCE THE POST-DEVELOPMENT LOAD. THE TOTAL PHOSPHORUS LOAD REDUCTION ACHIEVED (0.38 LB/YR) IS GREATER THAN THE TOTAL PHOSPHORUS LOAD REDUCTION REQUIRED (0.12 LB/YR). THUS, THE TARGET REDUCTION IS EXCEEDED BY 0.26 LB/YR. SEE SHEETS C-110 FOR STORMWATER MANAGEMENT PLAN AND C-503 FOR STORMWATER MANAGEMENT DETAILS.

VARIANCE REQUEST FOR RUNOFF REDUCTION VOLUME REQUIREMENT, 19 MINIMUM STANDARDS AND DISCHARGING TO A COMBINED SEWER SYSTEM

THE PROPOSED CONSTRUCTION IS LINEAR REDEVELOPMENT AND REPAIR WORK FOR THE VIRGINIA RAILWAY EXPRESS (VRE) WITH A TOTAL DISTURBANCE ESTIMATED UNDER 10,000 SQUARE FEET. NO MORE LAND SHALL BE DISTURBED THAN IS NECESSARY TO PROVIDE THE CONSTRUCTION OF A TUNNEL AND MINOR EXPANSION OF EXISTING PLATFORM. THE ENTIRE PROJECT IS LOCATED OUTSIDE THE 100 FOOT RESOURCE PROTECTION AREA (RPA) BUFFER AND 50 FEET OUTSIDE THE TOP OF STREAM BANK FOR NATURAL INTERMITTENT STREAMS. THE PROJECT MEETS THE CITY CODE 13-123- EXEMPTIONS REQUIREMENT. THEREFORE, IT IS REQUESTED TO WAIVE THE RUNOFF REDUCTION TREATMENT VOLUME (702 CUBIC FEET) REQUIREMENT, 19 MINIMUM STANDARDS REQUIREMENTS ADEQUATE OUTFALL ANALYSIS, AND ALLOW TO DISCHARGE TO A COMBINED SEWER SYSTEM. AN ESC PLAN WILL BE DEVELOPED TO EXPLAIN AND ILLUSTRATE THE CONTROL MEASURES TO BE USED DURING PROJECT CONSTRUCTION THAT MEETS THE INTENTS OF THE APPROPRIATE MINIMUM STANDARDS AS PRESENTED ON SHEET C-505.

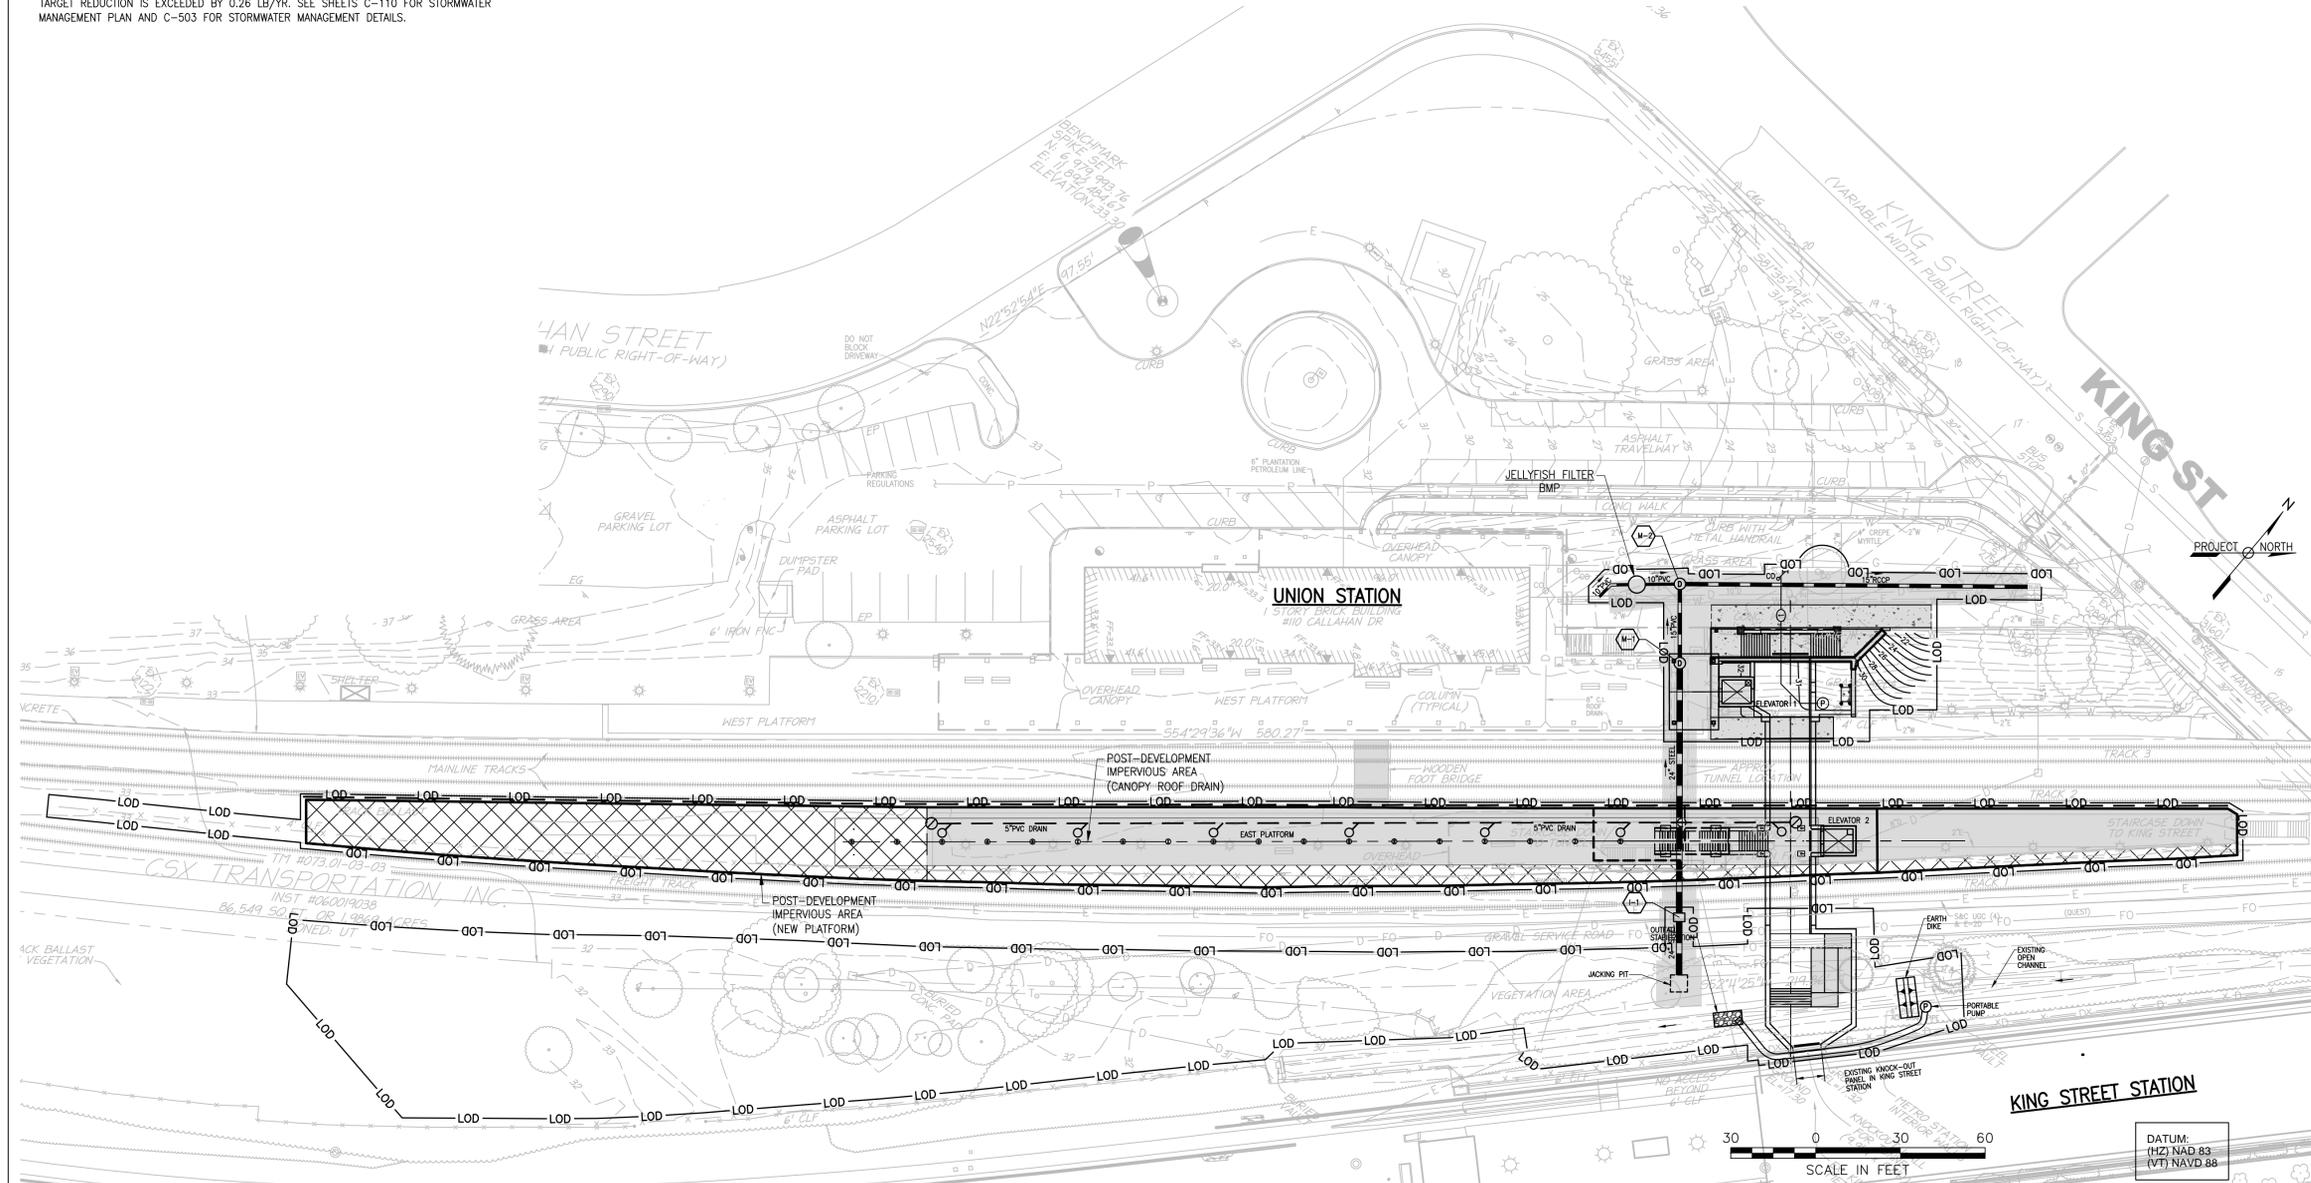

PRE-DEVELOPMENT LAND COVER

LAND COVER TYPE	D	SOILS AREA
FOREST/OPEN SPACE		NONE
MANAGED TURF		0.12 AC.
IMPERVIOUS COVER		0.13 AC.

POST-DEVELOPMENT LAND COVER

LAND COVER TYPE	D	SOILS AREA
FOREST/OPEN SPACE		NONE
MANAGED TURF		0.09 AC.
IMPERVIOUS COVER		0.18 AC.

LEGEND

- PRE-DEVELOPMENT AREA
- POST-DEVELOPMENT AREA
- SITE AREA

APPROVED SPECIAL USE PERMIT NO. DEPARTMENT OF PLANNING & ZONING

DIRECTOR: _____ DATE: _____
 DEPARTMENT OF TRANSPORTATION & ENVIRONMENTAL SERVICES
 SITE PLAN NO. DSP2011-0027

DIRECTOR: _____ DATE: _____

CHAIRMAN, PLANNING COMMISSION: _____ DATE: _____

DATE RECORDED: _____
 INSTRUMENT NO. _____ DEED BOOK NO. _____ PAGE NO. _____

60% SUBMITTAL

CONTRACT NO:	REVISIONS			
PROJECT NO:	BY	NO	DATE	DESCRIPTION
	GF	001		DEV. CONCEPT PLAN (30%)
	GF	002	6/20/16	DEV. SITE PLAN
DESIGNED:				
DRAFTED:				
CHECKED:				
APPROVED:				

Gannett Fleming

MARTHA JEAN AVERSO
 Lic. No. 17470
 PROFESSIONAL ENGINEER
 6-20-16


VRE

VIRGINIA RAILWAY EXPRESS
 ALEXANDRIA
 PEDESTRIAN TUNNEL

DISCIPLINE:
CIVIL WATER QUALITY ASSESSMENT SHEET
 SCALE: 1"=30' DATE ISSUED: 6/20/16

DRAWING NO:
C-111
 LIST NO:

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LEGEND
 - - - - - PROPOSED DRAINAGE AREA BOUNDARY
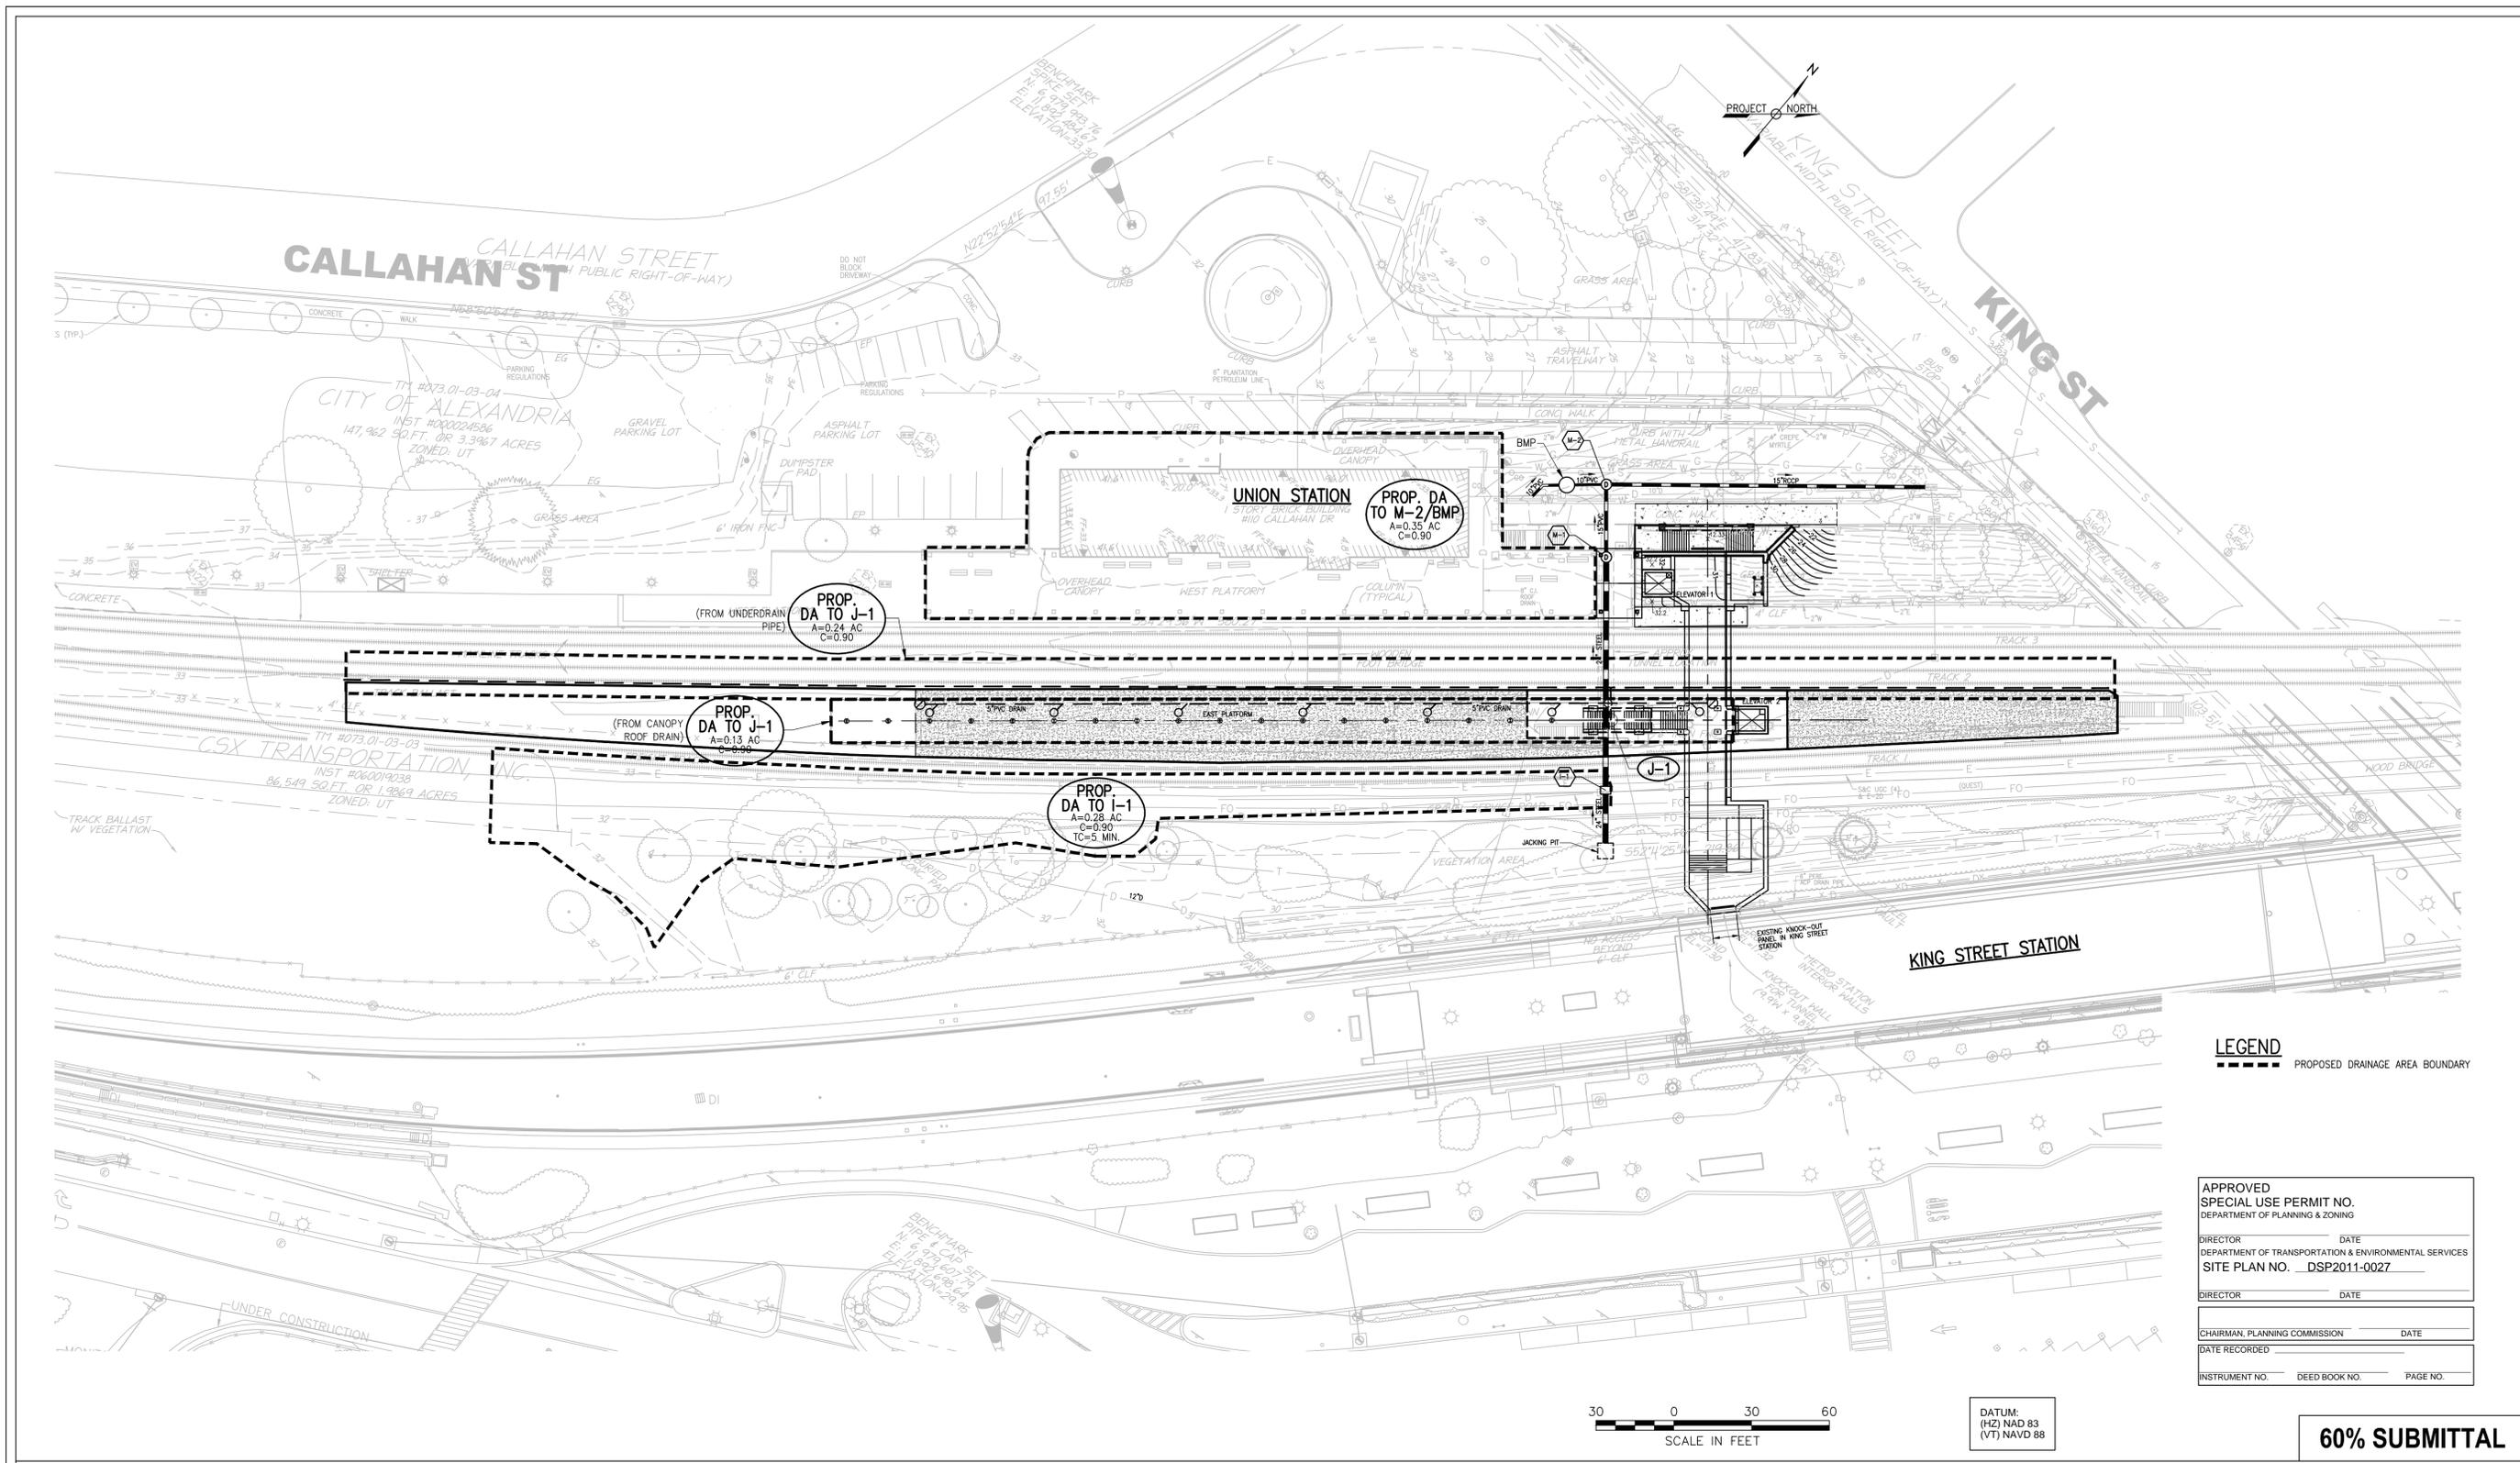
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 SITE PLAN NO. DSP2011-0027

DIRECTOR: _____ DATE: _____

CHAIRMAN, PLANNING COMMISSION: _____ DATE: _____
 DATE RECORDED: _____

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PROJECT NO:	BY	NO	DATE
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DESIGNED:	GF	002	6/20/16
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CHECKED:			
APPROVED:			
DATE:			
			DEV. CONCEPT PLAN (30%)
			DEV. SITE PLAN




VIRGINIA RAILWAY EXPRESS
 ALEXANDRIA
 PEDESTRIAN TUNNEL

DISCIPLINE:
 CIVIL
 PROPOSED DRAINAGE AREA MAP

SCALE: 1"=30' DATE ISSUED: 6/20/16

DRAWING NO:
 C-112
 LIST NO:

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CONSTRUCTION ACCESS/ STAGING NOTES

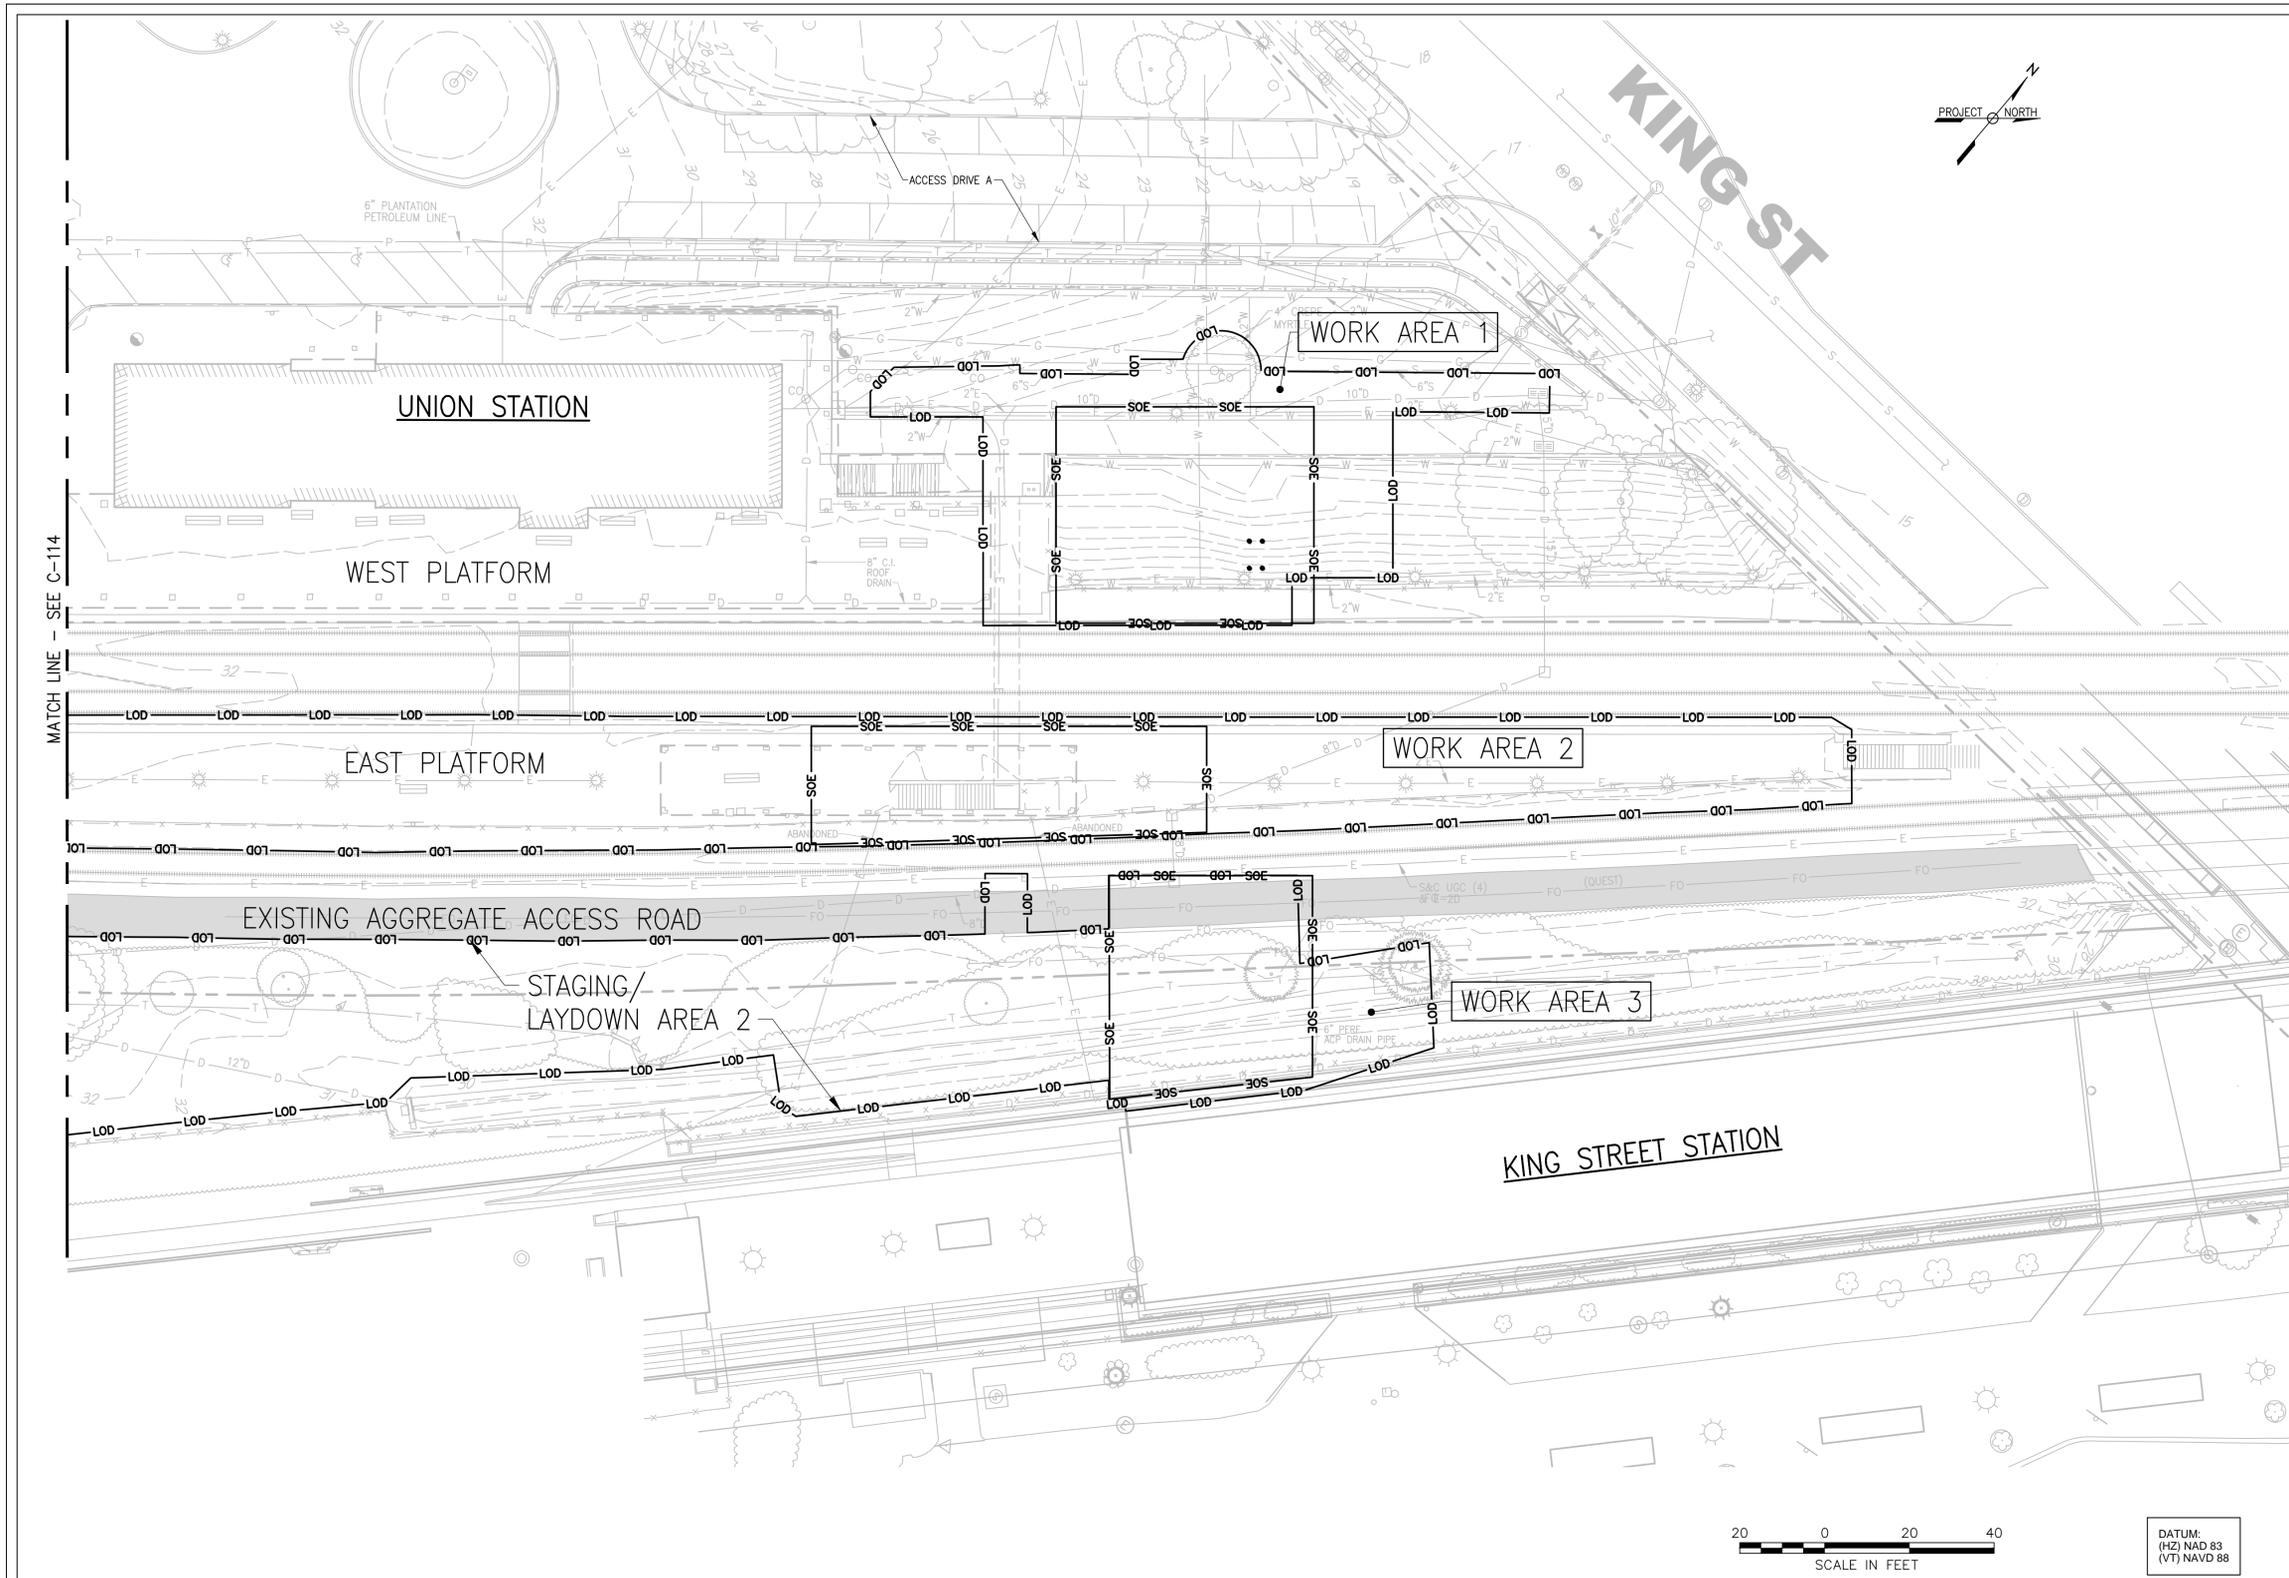- GENERAL**
1. SAFETY IS PARAMOUNT THROUGHOUT THE CONSTRUCTION PERIOD. SAFETY REQUIREMENTS WILL BE STRICTLY ENFORCED.
 2. UNION STATION, KING STREET STATION AND THE CSX RAILWAY IN THE WORK AREA SHALL REMAIN IN CONTINUOUS UNINTERRUPTED OPERATION THROUGHOUT THE CONSTRUCTION PERIOD.
 3. THE CONTRACTOR SHALL COORDINATE ALL PLANNED CONSTRUCTION OPERATIONS WITH THE VRE PROJECT MANAGER TO MINIMIZE IMPACTS TO FACILITY OPERATION.
 4. RESTRICTION OF OPERATIONS MAY BE REQUIRED DURING PEAK TRAVEL PERIODS, FOR PERFORMANCE OF FACILITY MAINTENANCE OR OTHER REASONS. THE VRE PROJECT MANAGER WILL COMMUNICATE THE NEED FOR ANY MODIFICATION OF CONSTRUCTION OPERATIONS TO THE CONTRACTOR.
 5. SEE THE MAINTENANCE OF TRAFFIC PLAN FOR PEDESTRIAN AND VEHICULAR TRAFFIC ROUTING DURING THE CONSTRUCTION PERIOD.

- WORK AREA 1**
1. WORK AREA 1 SHALL BE ACCESSED FROM KING STREET AND ACCESS DRIVE A.
 2. ACCESS TO THE WORK AREA SHALL BE RESTRICTED TO CONTRACTOR PERSONNEL ONLY BY A COMBINATION OF VEHICULAR AND PEDESTRIAN BARRICADES AND ORANGE SAFETY FENCE SURROUNDING ALL ACTIVE WORK AREAS.
 3. STAGING/LAYDOWN AREA 1 IS AVAILABLE FOR CONTRACTOR USE FOR THE CONSTRUCTION OFFICE, PARKING AND LAYDOWN. IF ADDITIONAL AREA IS REQUIRED THE CONTRACTOR SHALL SECURE SUCH AREAS OFFSITE.
 4. MATERIAL DELIVERIES TO THE STAGING AREA AND MATERIAL TRANSFER BETWEEN THE STAGING AREA AND THE TUNNEL PORTAL EXCAVATION AREA SHALL BE LIMITED TO OFF PEAK TRAVEL HOURS.

- WORK AREA 2**
1. WORK AREA 2 PERSONNEL ACCESS SHALL BE FROM THE WEST PLATFORM OR EXISTING TUNNEL.
 2. EQUIPMENT ACCESS SHALL BE VIA THE CSX AGGREGATE ACCESS ROAD.
 3. CONSTRUCTION EQUIPMENT SHALL BE LIFTED AND PLACED ON THE EAST PLATFORM FROM WORK AREA 3.
 4. NO EQUIPMENT CAN CROSS TRACK AREAS WITHOUT PRIOR APPROVAL FROM THE VRE PROJECT MANAGER AND CSX.

- WORK AREA 3**
1. WORK AREA 3 SHALL BE ACCESSED USING THE EXISTING CSX AGGREGATE PAVED ACCESS ROAD.
 2. THE EXISTING ACCESS ROAD SHALL BE ENTERED FROM AN EXISTING ACCESS POINT AT THE TERMINUS OF ROTH STREET. ACCESS ALONG AND THROUGH THE CSX TRACK AREA SHALL BE ALONG THE EXISTING ACCESS ROAD AS SHOWN ON THE PLANS.
 3. STAGING/LAYDOWN AREA 2 IS AVAILABLE FOR CONTRACTOR USE FOR PARKING AND LAYDOWN. IF ADDITIONAL AREA IS REQUIRED THE CONTRACTOR SHALL SECURE SUCH AREAS OFFSITE.
 4. MATERIAL DELIVERIES TO THE STAGING AREA SHALL BE LIMITED TO OFF PEAK TRAVEL HOURS AS ESTABLISHED BY CSX.
 5. THE CONTRACTOR SHALL KEEP THE TRACK AND ACCESS ROAD CLEAR OF ALL MUD AND DEBRIS THROUGHOUT PERFORMANCE OF THE WORK.

APPROVED SPECIAL USE PERMIT NO. DEPARTMENT OF PLANNING & ZONING	
DIRECTOR _____	DATE _____
DEPARTMENT OF TRANSPORTATION & ENVIRONMENTAL SERVICES	
SITE PLAN NO. <u>DSP2011-0027</u>	
DIRECTOR _____	DATE _____
CHAIRMAN, PLANNING COMMISSION _____ DATE _____	
DATE RECORDED _____	
INSTRUMENT NO. _____	DEED BOOK NO. _____ PAGE NO. _____



DATUM:
(HZ) NAD 83
(VT) NAVD 88

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PROJECT NO:	
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BY	NO	DATE	DESCRIPTION
GF	001		DEV. CONCEPT PLAN (30%)
GF	002	6/20/16	DEV. SITE PLAN






VIRGINIA RAILWAY EXPRESS
ALEXANDRIA
PEDESTRIAN TUNNEL

DISCIPLINE:	
CIVIL CONSTRUCTION ACCESS PLAN 1	
SCALE:	1"=20'
DATE ISSUED:	6/20/16

DRAWING NO:	C-113
LIST NO:	

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CALLAHAN ST

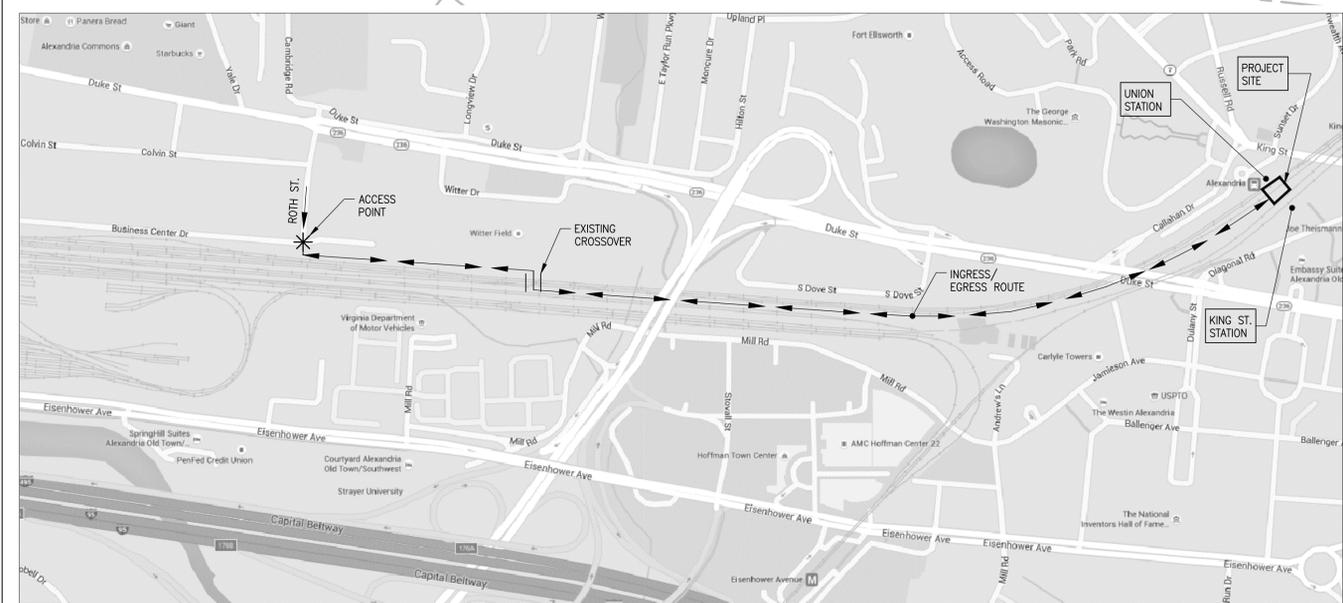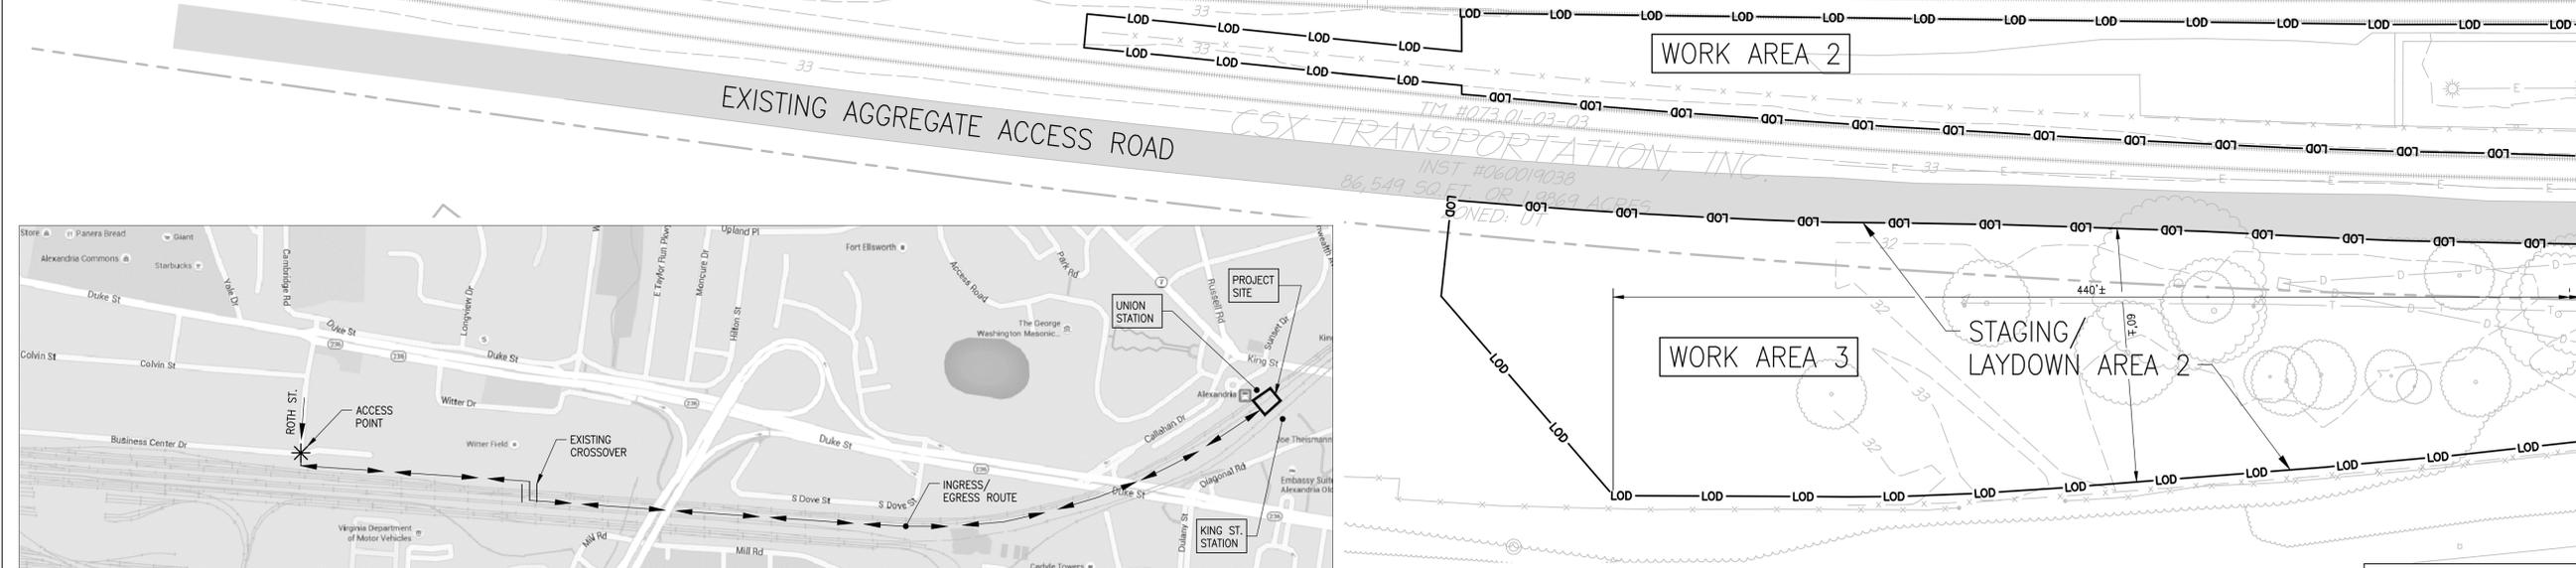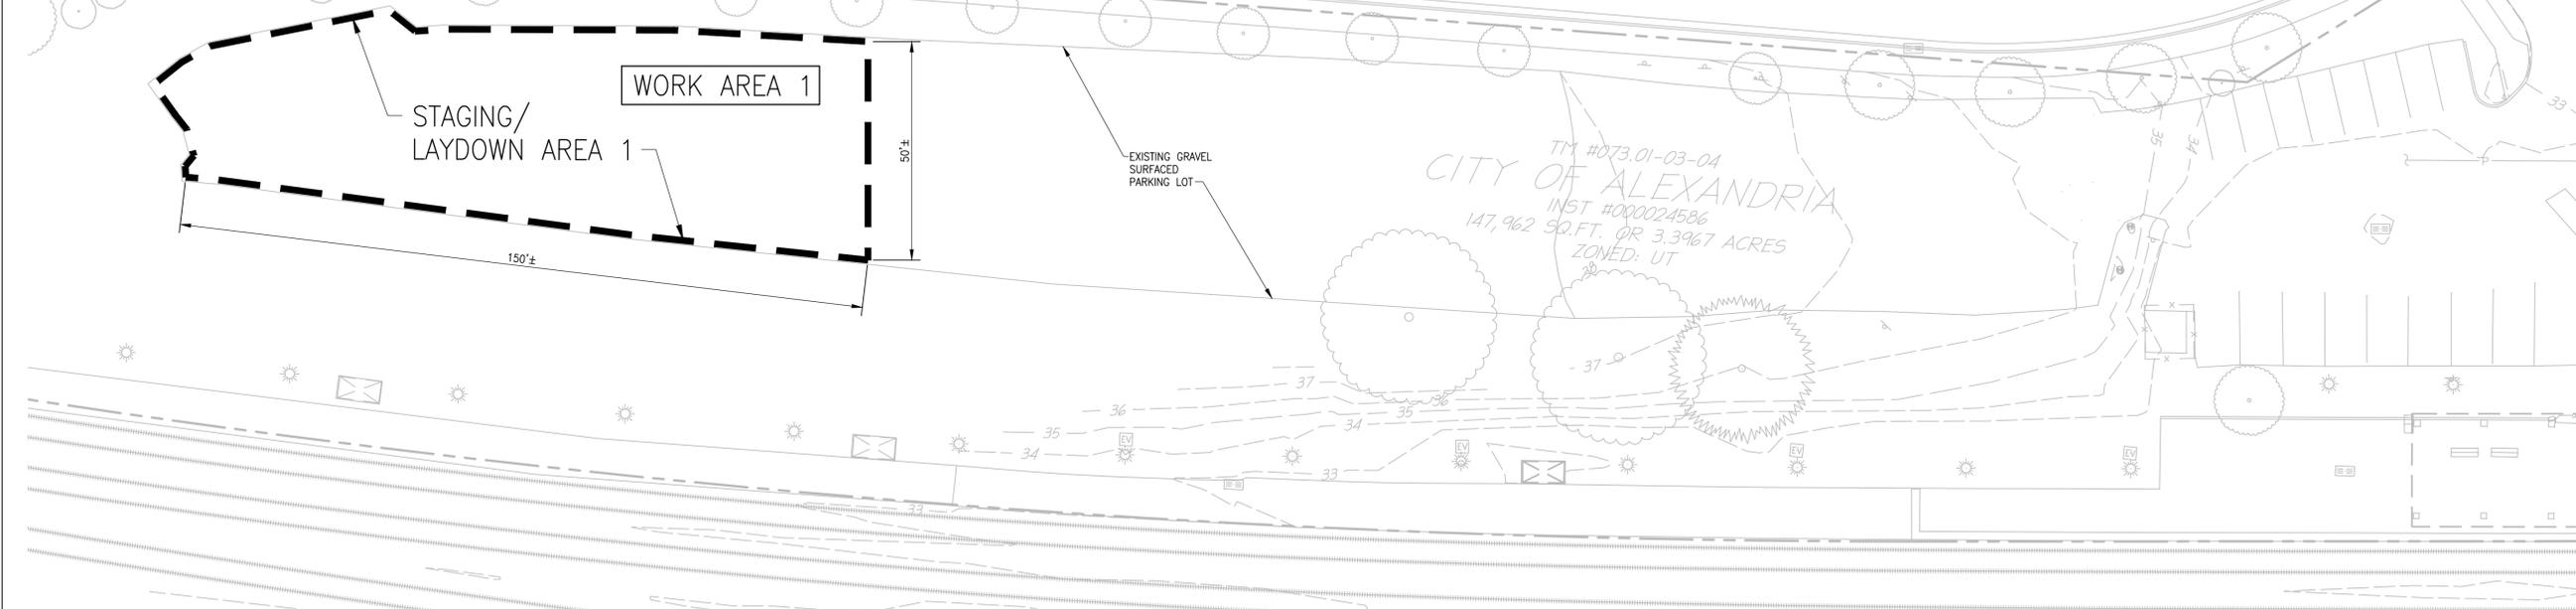

OVERALL CONSTRUCTION ACCESS PLAN
SCALE: 1"=500'



LEGEND

← INGRESS/EGRESS ROUTE ALONG EXISTING AGGREGATE SERVICE ROAD



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SITE PLAN NO. DSP2011-0027	
DIRECTOR	DATE
CHAIRMAN, PLANNING COMMISSION	
DATE RECORDED	
INSTRUMENT NO.	DEED BOOK NO. PAGE NO.

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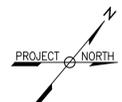
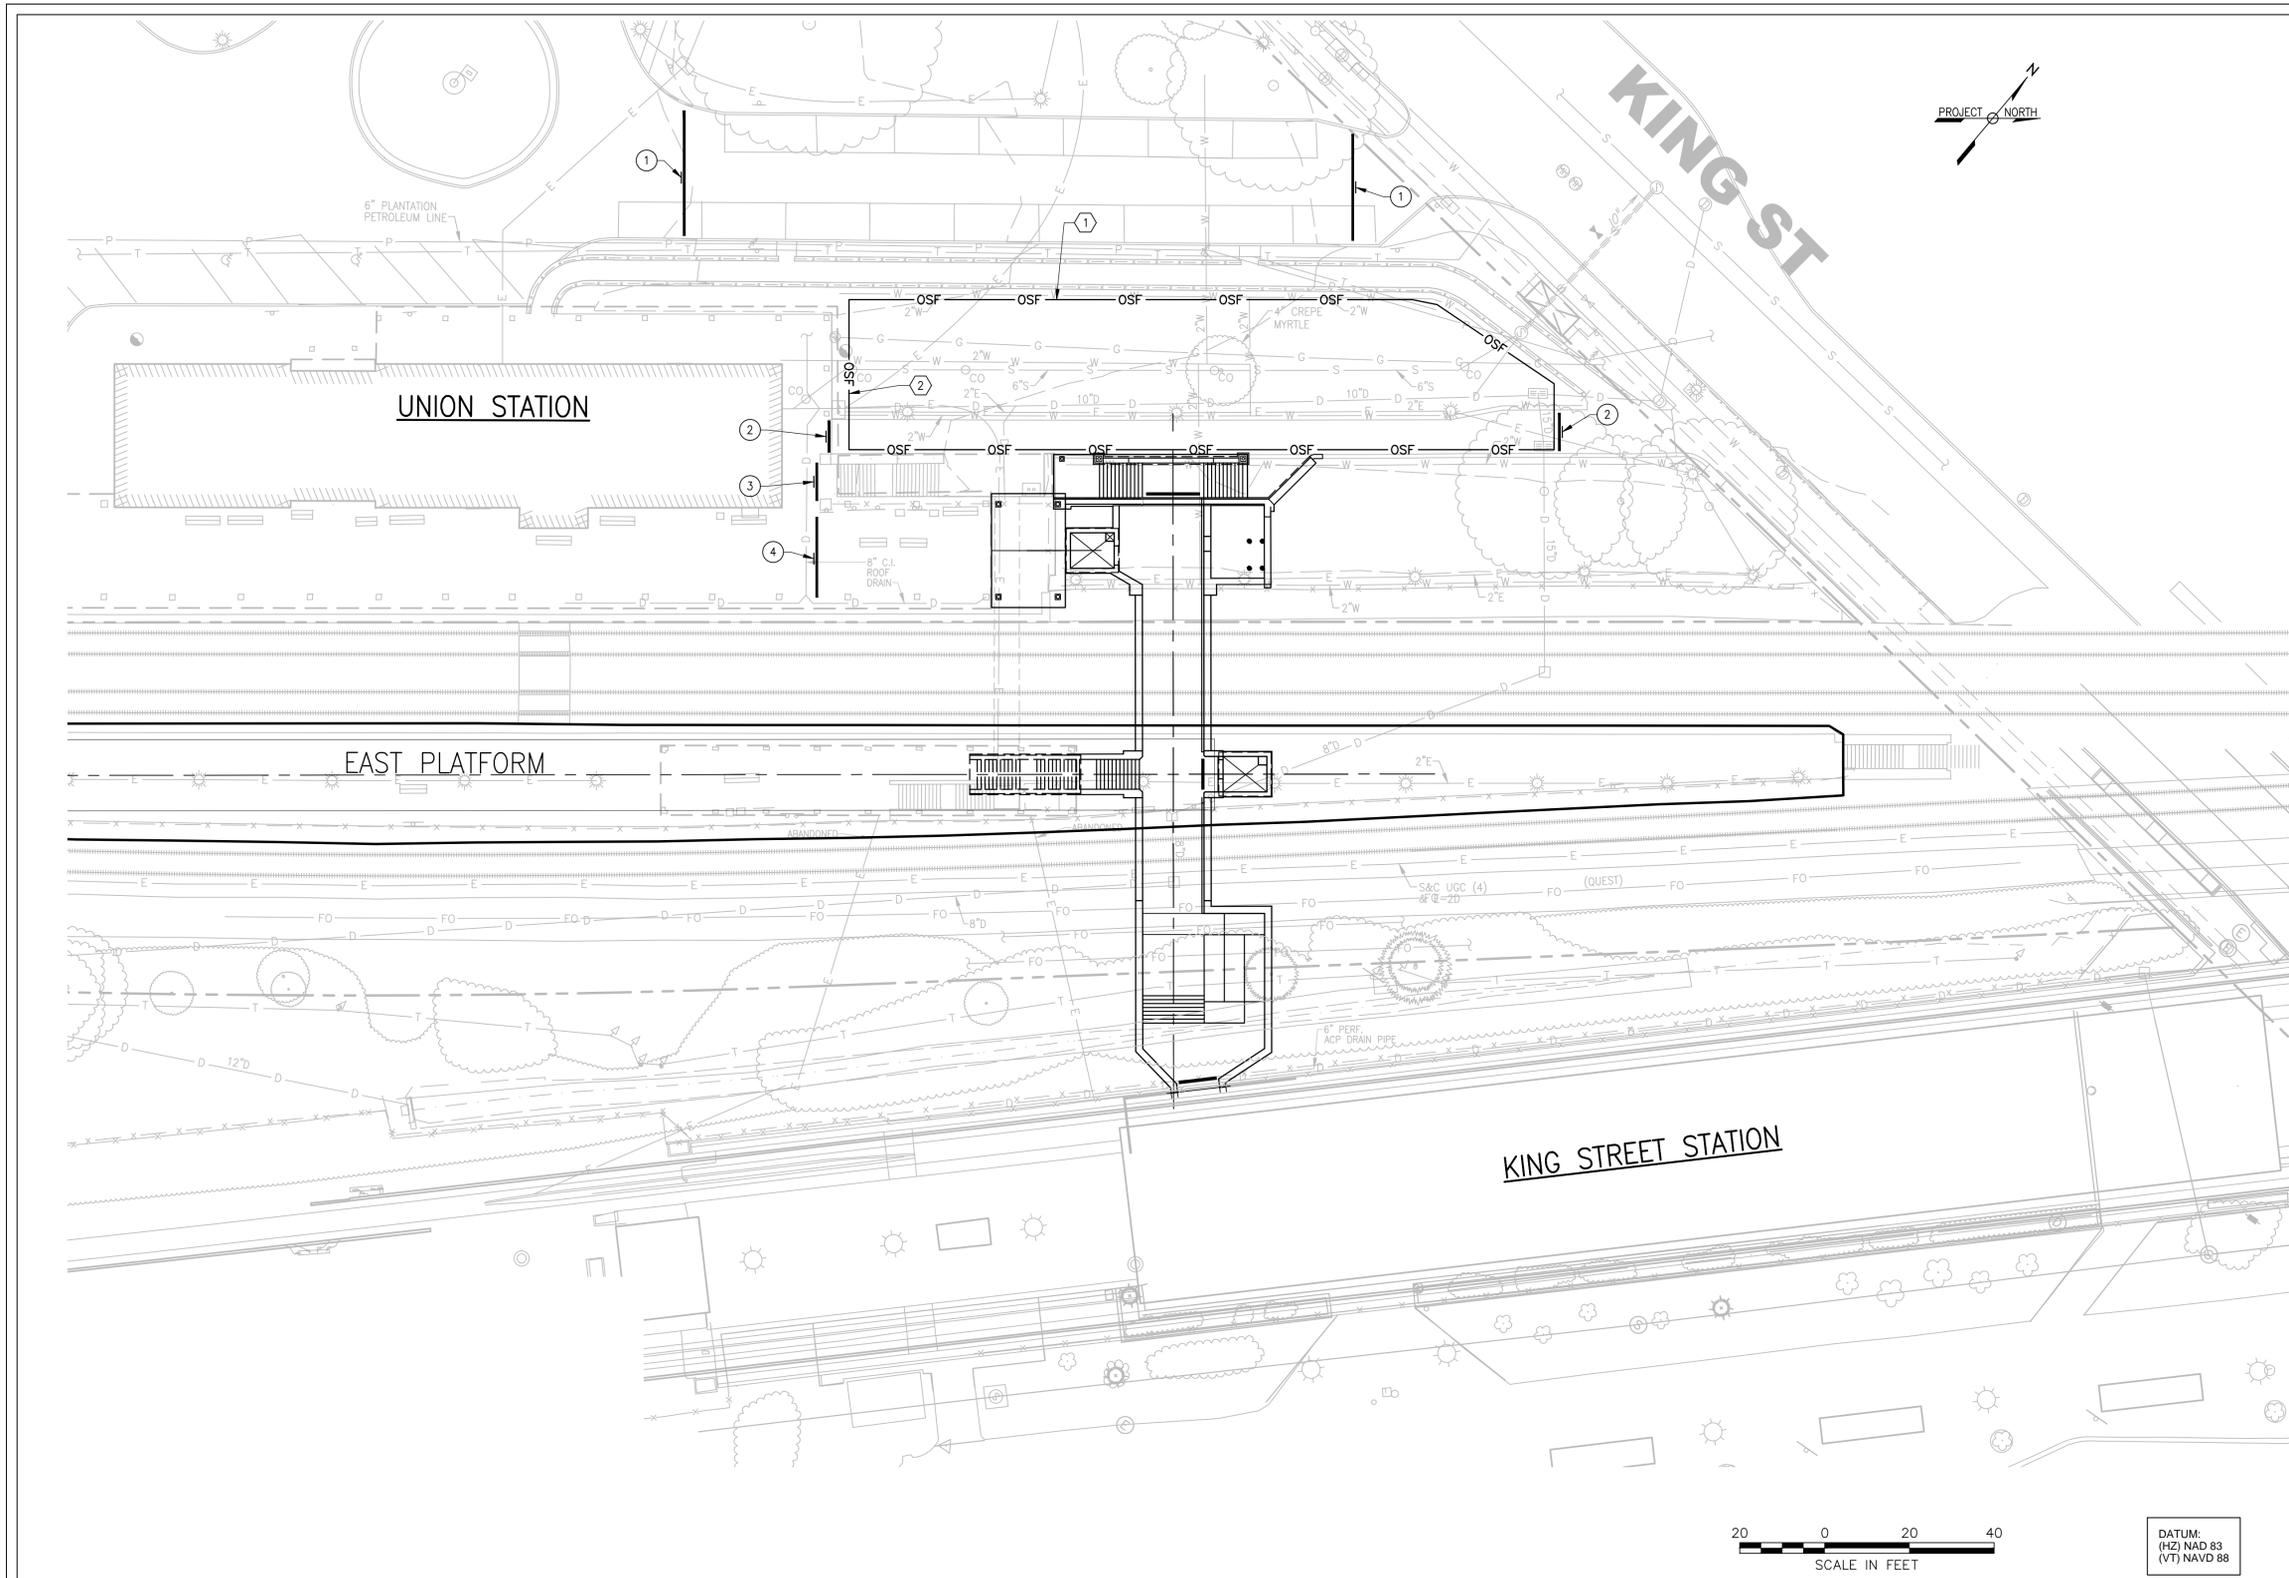
CONTRACT NO:		REVISIONS	
PROJECT NO:	DATE:	BY	NO
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		GF	002
DESIGNED:		DATE	DESCRIPTION
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VIRGINIA RAILWAY EXPRESS
ALEXANDRIA
PEDESTRIAN TUNNEL

DISCIPLINE:		DRAWING NO:	
CIVIL CONSTRUCTION ACCESS PLAN 2		C-114	
SCALE:	DATE ISSUED:	LIST NO:	
1"=20'	6/20/16		

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- MAINTENANCE OF TRAFFIC NOTES**
1. MAINTAIN PEDESTRIAN VEHICULAR TRAVEL WAYS OPEN DURING PEAK TRAVEL HOURS.
 2. INSTALL ROAD AND SIDEWALK CLOSURES DURING PERIODS OF ACTIVE WORK.

- NOTES**
- ① INSTALL ORANGE SAFETY FENCE (42" HEIGHT) ALONG PERIMETER OF LAWN AREA.
 - ② MAINTAIN ACCESS FOR VRE AND CITY OF ALEXANDRIA OPERATIONS PERSONNEL.

SIGN DETAILS

- ① **ROAD CLOSED**
R11-2
(48"X 30")
- ② **SIDEWALK CLOSED**
(24"X 36")
- ③ **SIDEWALK/
STAIRS
CLOSED**
(24"X 36")
- ④ **PLATFORM
CLOSED**
(24"X 36")

APPROVED
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DEPARTMENT OF PLANNING & ZONING

DIRECTOR _____ DATE _____
DEPARTMENT OF TRANSPORTATION & ENVIRONMENTAL SERVICES
SITE PLAN NO. DSP2011-0027

DIRECTOR _____ DATE _____

CHAIRMAN, PLANNING COMMISSION _____ DATE _____

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(HZ) NAD 83
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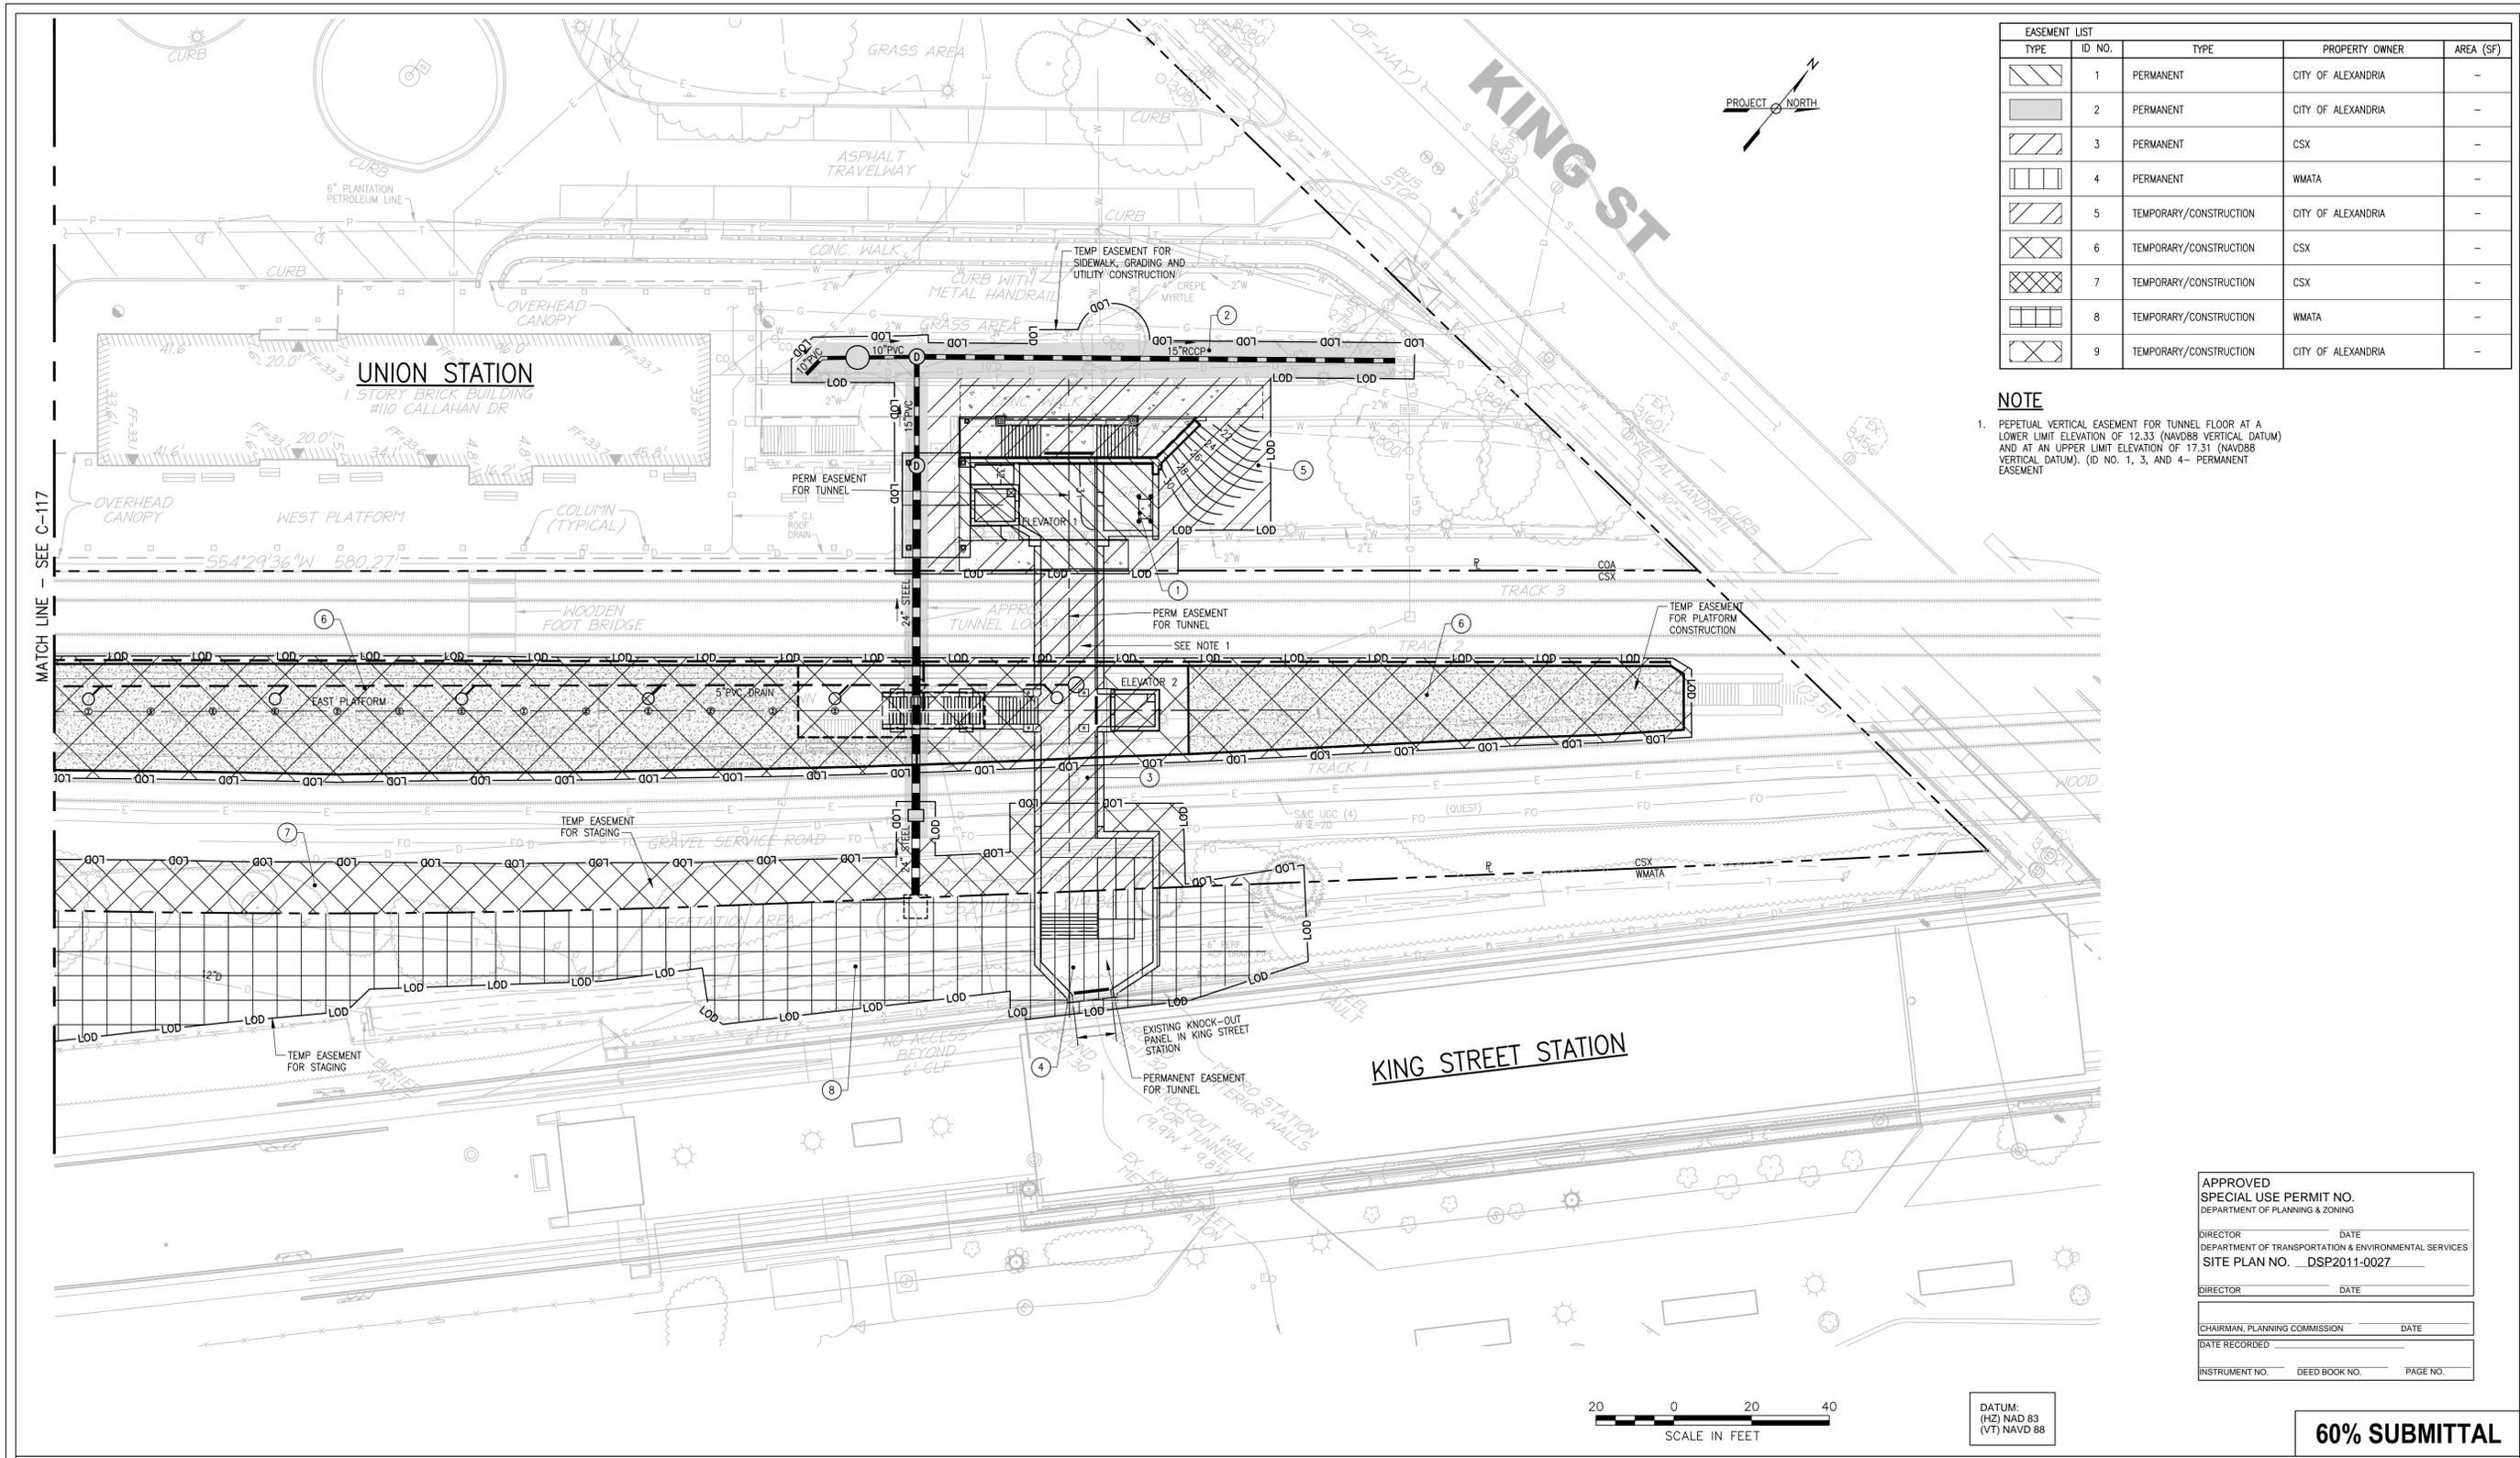
CONTRACT NO:	REVISIONS			
PROJECT NO:	BY	NO	DATE	DESCRIPTION
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DESIGNED:	GF	002	6/20/16	DEV. SITE PLAN
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VIRGINIA RAILWAY EXPRESS
ALEXANDRIA
PEDESTRIAN TUNNEL

DISCIPLINE:	DRAWING NO:
CIVIL MAINTENANCE OF TRAFFIC PLAN	C-115
SCALE: 1"=20'	LIST NO:
DATE ISSUED: 6/20/16	

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EASEMENT LIST				
TYPE	ID NO.	TYPE	PROPERTY OWNER	AREA (SF)
	1	PERMANENT	CITY OF ALEXANDRIA	-
	2	PERMANENT	CITY OF ALEXANDRIA	-
	3	PERMANENT	CSX	-
	4	PERMANENT	WMATA	-
	5	TEMPORARY/CONSTRUCTION	CITY OF ALEXANDRIA	-
	6	TEMPORARY/CONSTRUCTION	CSX	-
	7	TEMPORARY/CONSTRUCTION	CSX	-
	8	TEMPORARY/CONSTRUCTION	WMATA	-
	9	TEMPORARY/CONSTRUCTION	CITY OF ALEXANDRIA	-

NOTE
 1. PERPETUAL VERTICAL EASEMENT FOR TUNNEL FLOOR AT A LOWER LIMIT ELEVATION OF 12.33 (NAVD88 VERTICAL DATUM) AND AT AN UPPER LIMIT ELEVATION OF 17.31 (NAVD88 VERTICAL DATUM). (ID NO. 1, 3, AND 4 - PERMANENT EASEMENT)

APPROVED
 SPECIAL USE PERMIT NO.
 DEPARTMENT OF PLANNING & ZONING

DIRECTOR: _____ DATE: _____
 DEPARTMENT OF TRANSPORTATION & ENVIRONMENTAL SERVICES
 SITE PLAN NO. DSP2011-0027

DIRECTOR: _____ DATE: _____

CHAIRMAN, PLANNING COMMISSION: _____ DATE: _____

DATE RECORDED: _____

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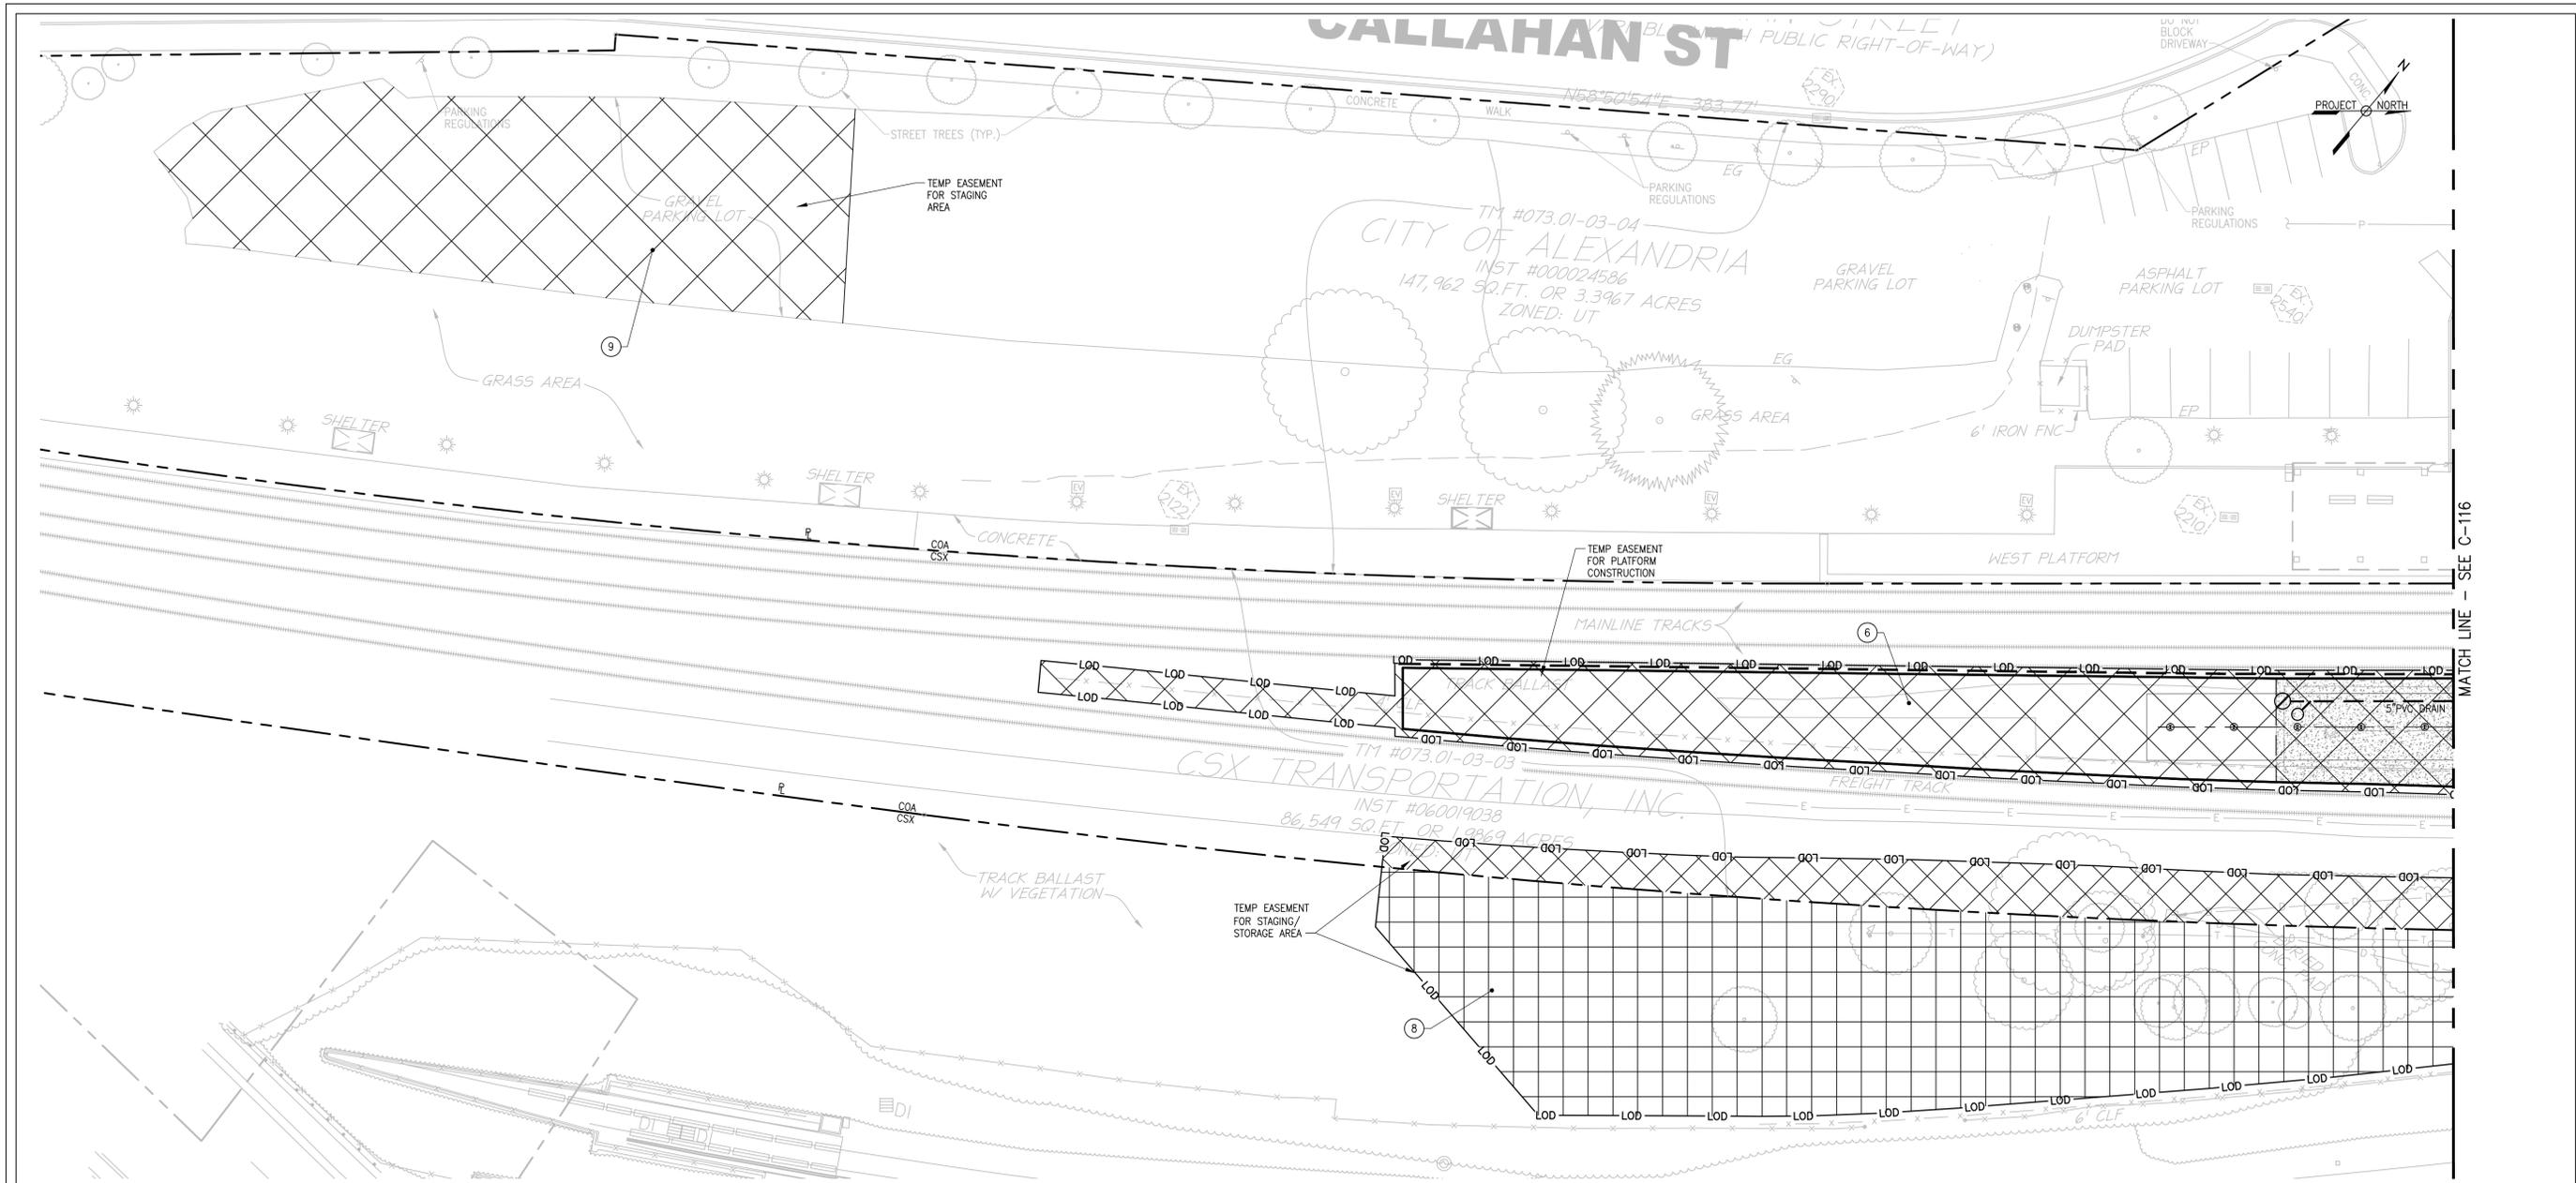


DATUM:
 (HZ) NAD 83
 (VT) NAVD 88

60% SUBMITTAL

CONTRACT NO:		REVISIONS					VIRGINIA RAILWAY EXPRESS	DISCIPLINE: CIVIL EASEMENT PLAN 1	DRAWING NO: C-116
PROJECT NO:	DATE:	BY	NO						
DESIGNED:		GF	001	6/20/16	DEV. CONCEPT PLAN (30%)			SCALE: 1"=20'	DATE ISSUED: 6/20/16
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NOTES
 1. SEE EASEMENT SUMMARY ON SHEET C-115.

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 DEPARTMENT OF TRANSPORTATION & ENVIRONMENTAL SERVICES
 SITE PLAN NO. DSP2011-0027

DIRECTOR: _____ DATE: _____

CHAIRMAN, PLANNING COMMISSION _____ DATE: _____

DATE RECORDED: _____

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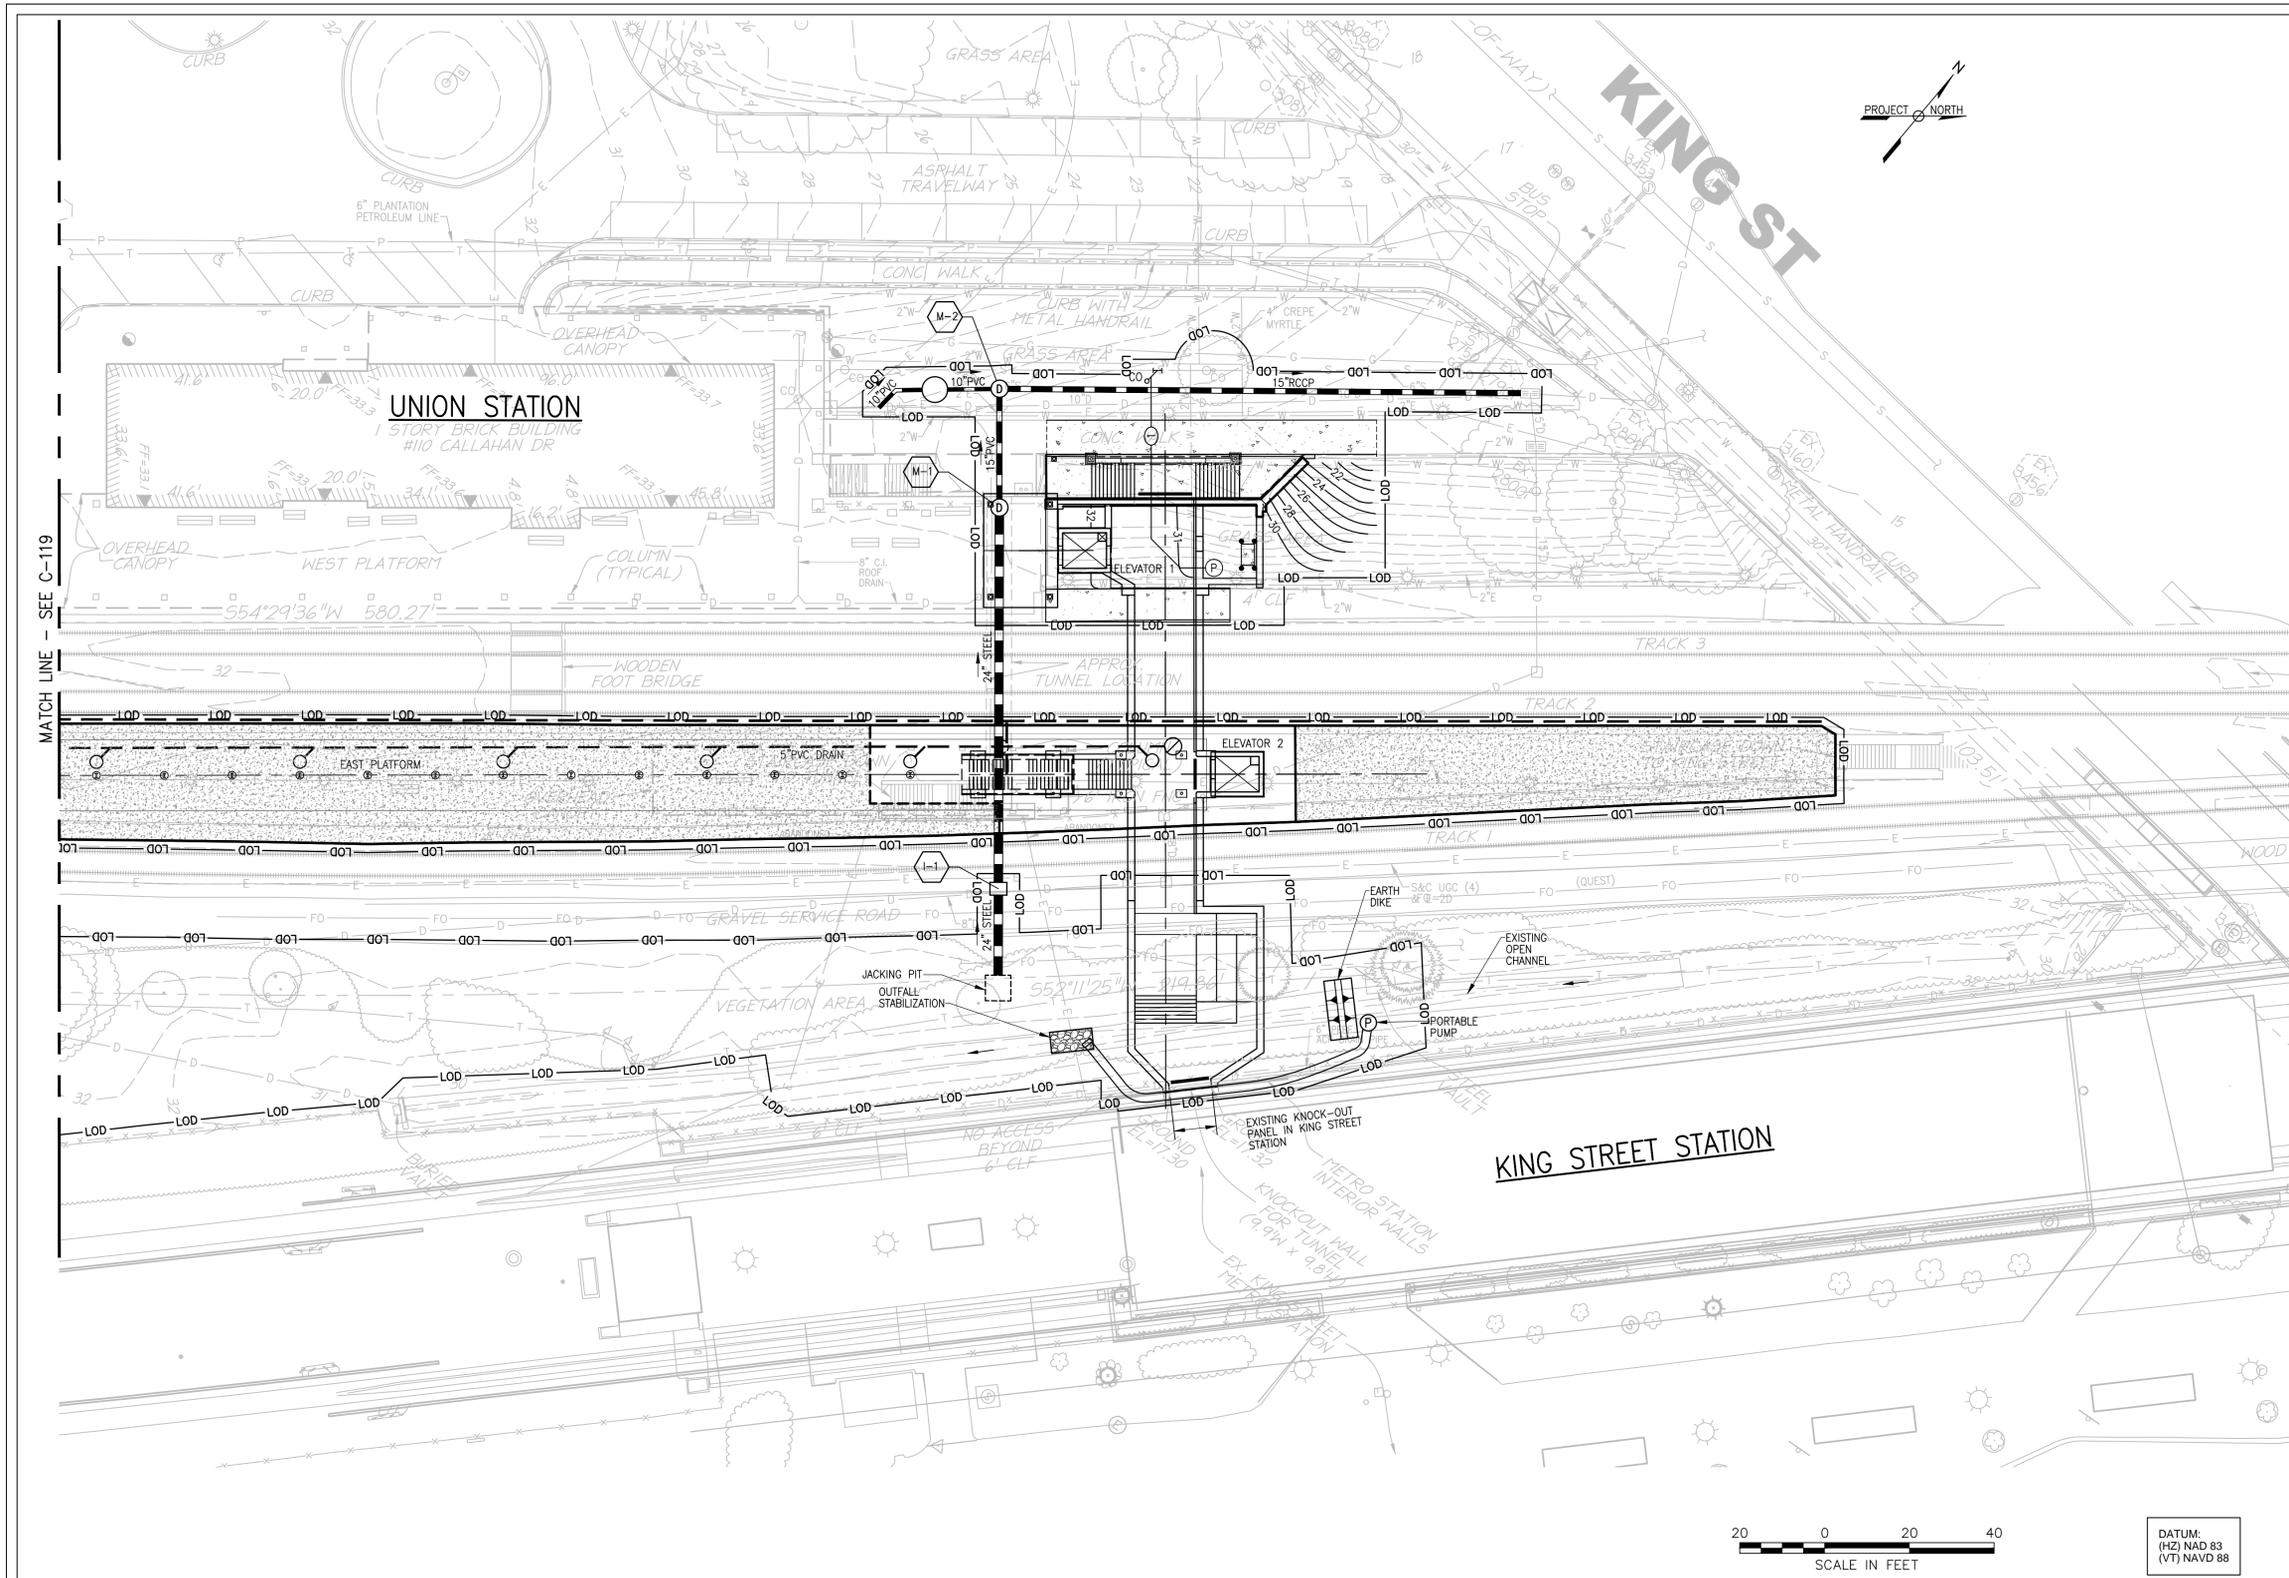
CONTRACT NO:	REVISIONS			
PROJECT NO:	BY	NO	DATE	DESCRIPTION
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DESIGNED:	GF	002	6/20/16	DEV. SITE PLAN
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APPROVED:				



VIRGINIA RAILWAY EXPRESS
 ALEXANDRIA
 PEDESTRIAN TUNNEL

DISCIPLINE:	DRAWING NO:
CIVIL EASEMENT PLAN 2	C-117
SCALE: 1"=20'	LIST NO:
DATE ISSUED: 6/20/16	

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- ### NOTES
- SEE SEQUENCE OF CONSTRUCTION ON SHEET.
 - THE LIMITS OF DISTURBANCE AS SHOWN ON THIS PLAN ARE THE ULTIMATE LIMITS FOR THE PROJECT. THE CONTRACTOR MUST APPLY SEPARATELY TO THE DEPARTMENT OF TRANSPORTATION AND ENVIRONMENTAL SERVICES (T&ES) FOR ANY WORK, INCLUDING THE PLACEMENT OF CONSTRUCTION FENCING, WITHIN THE PUBLIC RIGHT-OF-WAY. THE CITY WILL NOT ALLOW INCLUSION OF ANY PORTION OF THE PUBLIC RIGHT-OF-WAY, INCLUDING SIDEWALKS, INTO THE PROJECT AREA FOR THE PROJECT DURATION. WORK AND ASSOCIATED CLOSURES IN THE PUBLIC RIGHT-OF-WAY WILL BE PERMITTED SEPARATELY ON AN AS NEEDED BASIS BY T&ES.
 - A SEDIMENTATION AREA MUST BE PROVIDED AT EACH STABILIZED CONSTRUCTION ENTRANCE AS SHOWN ON THE PLANS. SEDIMENTATION AREA MUST BE ABLE TO HANDLE WASH RACK RUNOFF AND A MINIMUM OF 3' X 3' AND A MINIMUM DEPTH OF 6".
 - THE APPLICANT/DEVELOPER SHALL CALL ALEXANDRIA ARCHAEOLOGY IMMEDIATELY (703-746-4399) IF ANY BURIED STRUCTURAL REMAINS (WALL FOUNDATIONS, WELLS, PRIVES, CISTERNS, ETC.) OR CONCENTRATIONS OF ARTIFACTS ARE DISCOVERED DURING DEVELOPMENT. WORK MUST CEASE IN THE AREA OF THE DISCOVERY UNTIL A CITY ARCHAEOLOGIST COMES TO THE SITE AND RECORDS THE FINDS.
 - THE APPLICANT/DEVELOPER SHALL NOT ALLOW ANY METAL DETECTION AND/OR ARTIFACT COLLECTION TO BE CONDUCTED ON THE PROPERTY, UNLESS AUTHORIZED BY ALEXANDRIA ARCHAEOLOGY. FAILURE TO COMPLY SHALL RESULT IN PROJECT DELAYS.
 - CONTRACTOR IS TO PROVIDE ONSITE CONSTRUCTION ENTRANCE WASH DOWN AND DUST CONTROL SOURCE OF WATER. ALTERNATE WATER SOURCE MAY BE PROVIDED BY ADJACENT FIRE HYDRANT AS APPROVED BY THE INSPECTOR.
 - STOCKPILING PROCEDURES SHALL BE WITHIN LIMITS OF CONSTRUCTION. PROVIDED ADDITIONAL EROSION AND SEDIMENT CONTROLS AS DIRECTED.

- ### LEGEND
- GENERAL CIVIL / SITE
- 353--- EXISTING MINOR CONTOUR
 - 350--- EXISTING MAJOR CONTOUR
 - --- EXISTING EASEMENT
 - --- EXISTING TREELINE
 - --- EXISTING STREAM EDGE
 - --- EXISTING STORM DRAIN
 - --- EXISTING ROAD EDGE
 - --- EXISTING FENCE
 - --- EXISTING TREE
 - PT 105 TRAV ▲ TRAVERSE POINT
 - 340--- PROPOSED MAJOR CONTOUR
 - LOD--- LIMIT OF DISTURBANCE
 - SF--- SILT FENCE
 - TP--- TREE PROTECTION
 - SCE--- STABILIZED CONSTRUCTION ENTRANCE
 - CIP--- CURB INLET PROTECTION
 - P--- PUMPS
 - HOSE--- HOSE

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DIRECTOR: _____ DATE: _____
DEPARTMENT OF TRANSPORTATION & ENVIRONMENTAL SERVICES
SITE PLAN NO. DSP2011-0027

DIRECTOR: _____ DATE: _____

CHAIRMAN, PLANNING COMMISSION: _____ DATE: _____

DATE RECORDED: _____

INSTRUMENT NO. _____ DEED BOOK NO. _____ PAGE NO. _____



DATUM:
(HZ) NAD 83
(VT) NAVD 88

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CONTRACT NO:	REVISIONS			
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	GF	002	6/20/16	DEV. SITE PLAN
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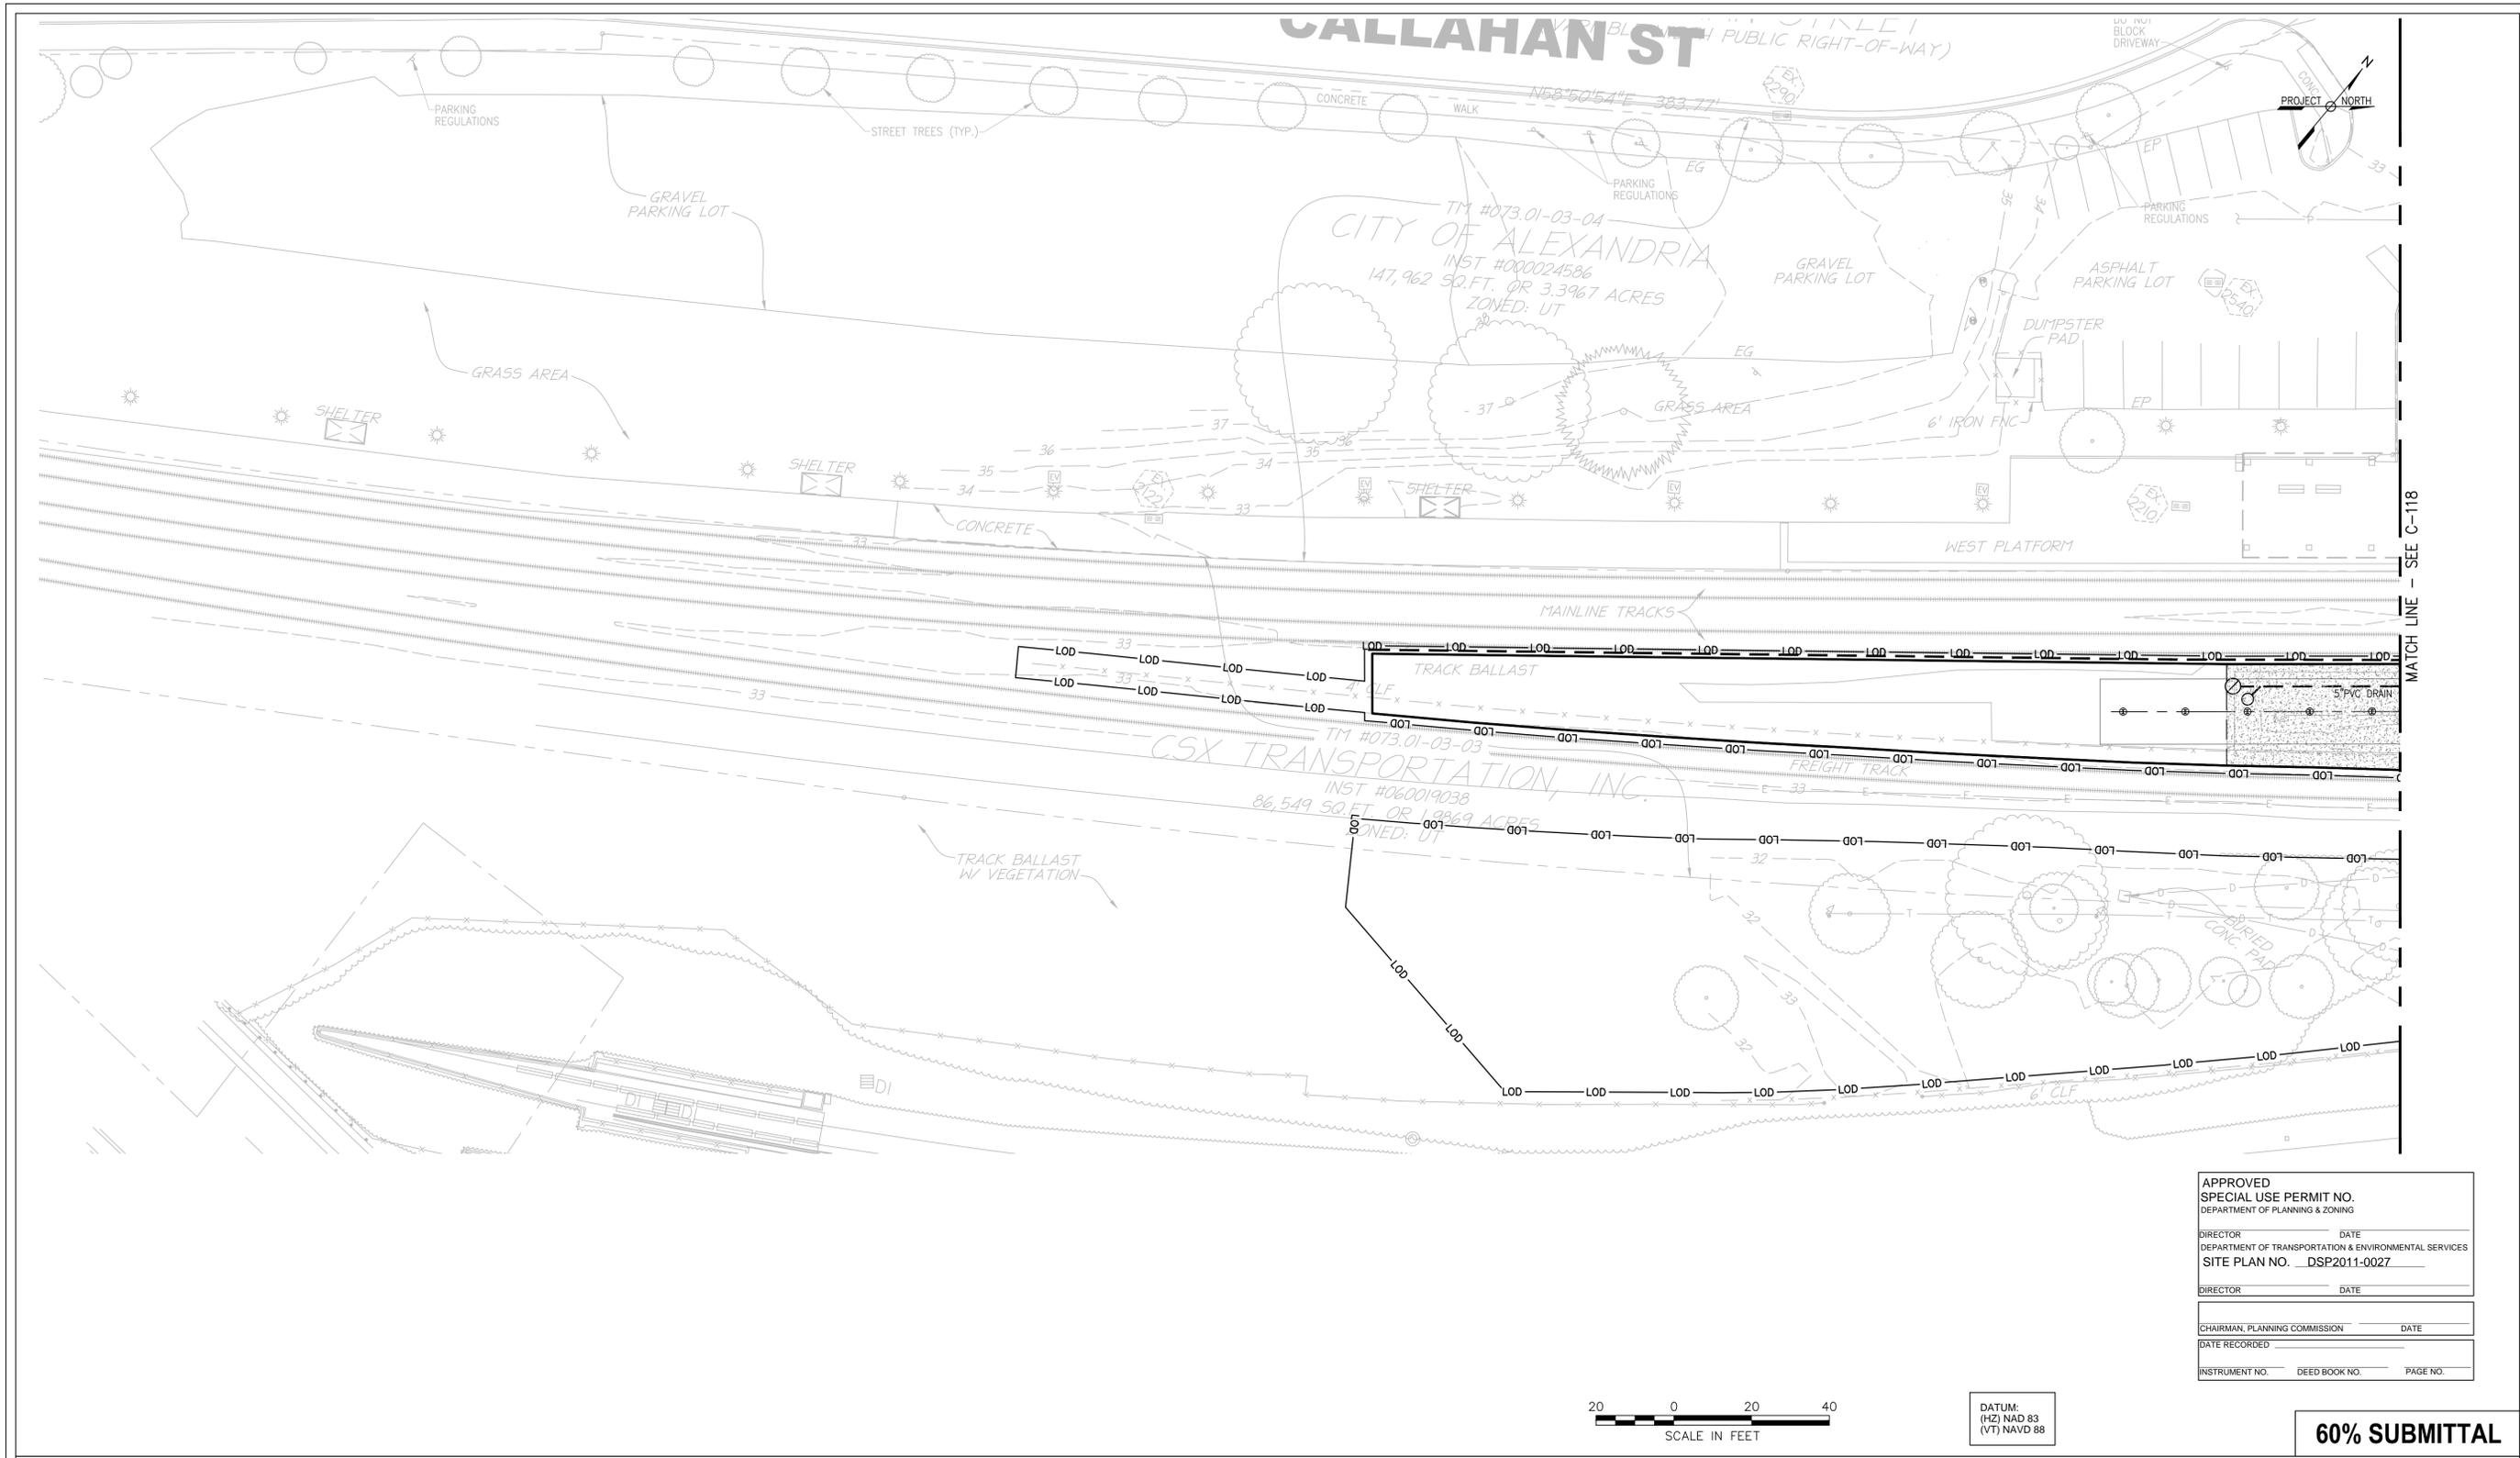


VIRGINIA RAILWAY EXPRESS
ALEXANDRIA
PEDESTRIAN TUNNEL

DISCIPLINE:
CIVIL
EROSION AND SEDIMENT
CONTROL PLAN 1
SCALE: 1"=20'
DATE ISSUED: 6/20/16

DRAWING NO:
C-118
LIST NO:

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DIRECTOR _____ DATE _____

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DATE RECORDED _____

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DATUM:
(HZ) NAD 83
(VT) NAVD 88

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CONTRACT NO:		REVISIONS	
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	GF	002	6/20/16
DESIGNED:	DESCRIPTION		
DRAFTED:	DEV. CONCEPT PLAN (30%)		
CHECKED:	DEV. SITE PLAN		
APPROVED:			



VIRGINIA RAILWAY EXPRESS
ALEXANDRIA
PEDESTRIAN TUNNEL

DISCIPLINE:
CIVIL
EROSION AND SEDIMENT
CONTROL PLAN 2

SCALE: 1"=20' DATE ISSUED: 6/20/16

DRAWING NO:
C-119
LIST NO:

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PROJECT NO:	
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APPROVED:	

REVISIONS			
BY	NO	DATE	DESCRIPTION
GF	001		DEV. CONCEPT PLAN (30%)
GF	002	6/20/16	DEV. SITE PLAN



VIRGINIA RAILWAY EXPRESS
ALEXANDRIA
PEDESTRIAN TUNNEL

DISCIPLINE:
CIVIL
VRRM WORKSHEETS AND
STORM SEWER COMPUTATION
SCALE: NONE DATE ISSUED: 6/20/16

DRAWING NO:
C-120
LIST NO:

DATUM:
(HZ) NAD 83
(VT) NAVD 88

60% SUBMITTAL

Virginia Runoff Reduction Method ReDevelopment Worksheet - v2.6 - June 2014
To be used w/ 2011 BMP Standards and Specifications
Site Data

Project Name: VRE ALEXANDRIA PEDESTRIAN TUNNEL
Date: 5/22/16

Post-ReDevelopment Project & Land Cover Information		Total Disturbed Acreage	1.21
Constants			
Annual Rainfall (inches)	21		
Target Rainfall Event (inches)	1.50		
Phosphorus EMC (mg/L)	0.28	Nitrogen EMC (mg/L)	1.88
Target Phosphorus Target Load (lb/acre-yr)	0.41		
% Impervious	0.90		
Pre-ReDevelopment Land Cover (acres)			
A Soils	0.0000	B Soils	0.0000
C Soils	0.0000	D Soils	0.0000
Totals	0.0000		0.0000
Post-ReDevelopment Land Cover (acres)			
A Soils	0.0000	B Soils	0.0000
C Soils	0.0000	D Soils	0.0000
Totals	0.0000		0.0000

Land Cover Summary		Pre-Development	Post-Development	Land Cover Summary	Post-Development
Forest/Open Space (acres)		0.0000	0.0000	Forest/Open Space (acres)	0.0000
Composite (acres)		0.00	0.00	Composite (acres)	0.00
Managed Turf (acres)		0.1433	0.0000	Managed Turf (acres)	0.0000
Impervious (acres)		0.1900	0.1900	Impervious (acres)	0.1900
Total Site Area (acres)		0.27	0.22	Total Site Area (acres)	0.22
Site Imp		0.59	0.89	Site Imp	0.89
Pre-Development Treatment Volume (acre-ft)		0.0130	0.0122	Pre-Development Treatment Volume (acre-ft)	0.0122
Pre-Development Treatment Volume (cubic feet)		575	530	Pre-Development Treatment Volume (cubic feet)	530
Pre-Development Load (TP) (Bbyr)		0.38	0.33	Pre-Development Load (TP) (Bbyr)	0.33
Post-Development Treatment Volume (acre-ft)				Post-Development Treatment Volume (acre-ft)	
Post-Development Treatment Volume (cubic feet)				Post-Development Treatment Volume (cubic feet)	
Post-Development Load (TP) (Bbyr)				Post-Development Load (TP) (Bbyr)	
Total Load Reduction Required (Bbyr)				Total Load Reduction Required (Bbyr)	
Post-Development Load (TN) (Bbyr)		2.29		Post-Development Load (TN) (Bbyr)	3.16

Site Results		D.A. A	D.A. B	D.A. C	D.A. D	D.A. E	AREA CHECK
IMPERVIOUS COVER		0.90	0.90	0.90	0.90	0.90	AREA EXCEEDED
IMPERVIOUS COVER TREATED		0.3600	0.0000	0.0000	0.0000	0.0000	AREA EXCEEDED
TURF AREA TREATED		0.0000	0.0000	0.0000	0.0000	0.0000	OK
AREA CHECK		OK	OK	OK	OK	OK	OK
TOTAL PHOSPHOROUS LOAD REDUCTION REQUIRED (LB/YEAR)		0.12					
PHOSPHOROUS LOAD REDUCTION ACHIEVED (LB/YEAR)		0					
ADJUSTED POST-DEVELOPMENT PHOSPHOROUS LOAD (TP) (Bbyr)		0.06					
REMAINING PHOSPHOROUS LOAD REDUCTION (LB/YEAR) NEEDED (CONGRATULATIONS! YOU EXCEEDED THE TARGET REDUCTION BY 6.5 LB/YEAR)							
Nitrogen (for information purposes)							
ADJUSTED POST-DEVELOPMENT NITROGEN LOAD (TP) (Bbyr)		0.40					

APPROVED
SPECIAL USE PERMIT NO.
DEPARTMENT OF PLANNING & ZONING
DIRECTOR DATE
DEPARTMENT OF TRANSPORTATION & ENVIRONMENTAL SERVICES
SITE PLAN NO. DSP2011-0027
DIRECTOR DATE
CHAIRMAN, PLANNING COMMISSION DATE
DATE RECORDED
INSTRUMENT NO. DEED BOOK NO. PAGE NO.

Drainage Area A	Drainage Area B	Drainage Area C	Drainage Area D	Drainage Area E	Drainage Area F	Drainage Area G	Drainage Area H	Drainage Area I	Drainage Area J	Drainage Area K	Drainage Area L	Drainage Area M	Drainage Area N	Drainage Area O	Drainage Area P	Drainage Area Q	Drainage Area R	Drainage Area S	Drainage Area T	Drainage Area U	Drainage Area V	Drainage Area W	Drainage Area X	Drainage Area Y	Drainage Area Z				
1. 10% Impervious	2. 20% Impervious	3. 30% Impervious	4. 40% Impervious	5. 50% Impervious	6. 60% Impervious	7. 70% Impervious	8. 80% Impervious	9. 90% Impervious	10. 100% Impervious	11. 10% Impervious	12. 20% Impervious	13. 30% Impervious	14. 40% Impervious	15. 50% Impervious	16. 60% Impervious	17. 70% Impervious	18. 80% Impervious	19. 90% Impervious	20. 100% Impervious	21. 10% Impervious	22. 20% Impervious	23. 30% Impervious	24. 40% Impervious	25. 50% Impervious	26. 60% Impervious	27. 70% Impervious	28. 80% Impervious	29. 90% Impervious	30. 100% Impervious

Drainage Area A	Drainage Area B	Drainage Area C	Drainage Area D	Drainage Area E	Drainage Area F	Drainage Area G	Drainage Area H	Drainage Area I	Drainage Area J	Drainage Area K	Drainage Area L	Drainage Area M	Drainage Area N	Drainage Area O	Drainage Area P	Drainage Area Q	Drainage Area R	Drainage Area S	Drainage Area T	Drainage Area U	Drainage Area V	Drainage Area W	Drainage Area X	Drainage Area Y	Drainage Area Z				
1. 10% Impervious	2. 20% Impervious	3. 30% Impervious	4. 40% Impervious	5. 50% Impervious	6. 60% Impervious	7. 70% Impervious	8. 80% Impervious	9. 90% Impervious	10. 100% Impervious	11. 10% Impervious	12. 20% Impervious	13. 30% Impervious	14. 40% Impervious	15. 50% Impervious	16. 60% Impervious	17. 70% Impervious	18. 80% Impervious	19. 90% Impervious	20. 100% Impervious	21. 10% Impervious	22. 20% Impervious	23. 30% Impervious	24. 40% Impervious	25. 50% Impervious	26. 60% Impervious	27. 70% Impervious	28. 80% Impervious	29. 90% Impervious	30. 100% Impervious

SEE WATER QUALITY COMPLIANCE FOR POSITIVE COMPLIANCE CALCULATION

SEE WATER QUALITY COMPLIANCE FOR POSITIVE COMPLIANCE CALCULATION

Site Data Summary

Total Rainfall = 43 inches

Site Land Cover Summary

	A Soils	B Soils	C Soils	D Soils	Total	% of Total
Forest (acres)	0.0000	0.0000	0.0000	0.0000	0.0000	0.00
Turf (acres)	0.0000	0.0000	0.0000	0.0900	0.0900	33.33
Impervious (acres)	0.0000	0.0000	0.0000	0.1800	0.1800	66.67
					0.2700	100.00

Sum of Drainage Areas is greater than Total Site Area

Site Rv	0.72
Post Development Treatment Volume (ft ³)	702
Post Development TP Load (lb/yr)	0.44
Post Development TN Load (lb/yr)	3.16
Total TP Load Reduction Required (lb/yr)	0.12

Total Runoff Volume Reduction (ft ³)	0
Total TP Load Reduction Achieved (lb/yr)	0.38
Total TN Load Reduction Achieved (lb/yr)	2.71
Adjusted Post Development TP Load (lb/yr)	0.06
Remaining Phosphorous Load Reduction (lb/yr) Required	0.00

Drainage Area Summary

	D.A. A	D.A. B	D.A. C	D.A. D	D.A. E	Total
Forest (acres)	0.0000	0.0000	0.0000	0.0000	0.0000	0.0000
Turf (acres)	0.0000	0.0000	0.0000	0.0000	0.0000	0.0000
Impervious (acres)	0.3500	0.0000	0.0000	0.0000	0.0000	0.3500
						0.3500

Drainage Area Compliance Summary

	D.A. A	D.A. B	D.A. C	D.A. D	D.A. E	Total
TP Load Red. (lb/yr)	0.38	0.00	0.00	0.00	0.00	0.38
TN Load Red. (lb/yr)	2.71	0.00	0.00	0.00	0.00	2.71

Channel and Flood Protection

	Weighted CN	1-year storm Adjusted CN	2-year storm Adjusted CN	10-year storm Adjusted CN
Target Rainfall Event (in)		2.50	3.30	5.01
D.A. A CN	98	98	98	98
D.A. B CN	0	44	#N/A	#N/A
D.A. C CN	0	44	#N/A	#N/A
D.A. D CN	0	44	#N/A	#N/A
D.A. E CN	0	44	#N/A	#N/A

Storm Sewer Computations

LD-229
INCIDENCE PROBABILITY

Description: **Post-Development Conditions**
Structure I-1 to Existing 2790

Project: **VRE - Alexandria pedestrian Tunnel**
Date: **6/20/16**
Designer: **SKG**

Checked:

From Point	To Point	Area Drain "A"	Run-off Coef	CA	Inlet Time	Rainfall	Runoff, Q	Invert Elevations	Length	Slope	Required Pipe Dia	Capacity	Velocity	Flow Time (Min)	Remarks			
(1)	(2)	(3)	(4)	(5)	(6)	(7)	(8)	(9)	(10)	(11)	(12)	(13)	(14)	(15)	(16)	(17)		
M-1	M-1	0.28	0.90	0.25	0.25	5.06	4.18	2.29	20.7	19.8	88	0.01047	7.57760	24	23.13	4.31	0.33	5.33
M-2	EX 2790	0.35	0.9	0.32	0.37	5.40	8.91	5.05	13.40	10.50	121.00	0.02397	8.69929	15	10.00	5.74	0.35	5.75

WATER QUALITY VOLUME BMP DATA BLOCKS

Project Description

Development or **Redevelopment**

Drainage Area	Impervious	Pervious	Total
Site Area	0.18 AC.	0.09 AC.	0.27 AC.
On-Site Treated	NONE	NONE	NONE
Off-Site Treated	0.35 AC.	NONE	0.35 AC.
Total Treated	0.35 AC.	NONE	0.35 AC.
Any On-Site Disconnected by a Vegetated Buffer (25 ft)	NONE		
Total On-Site Treated or Disconnected			NONE

Water Treatment on site

BMP Type	Area treated by BMP (acres)	Impervious area treated by BMP (acres)	BMP efficiency (%)
JELLY FISH FILTER	0.35 AC.	0.35 AC.	50%

Miscellaneous

Total WQV treated: yes no
Detention on site: yes no

Project is within which watershed? **POTOMAC RIVER WATERSHED**

Project discharges to which body of water? **OUTFALLS TO HOOFF'S RUN**

APPROVED
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DEPARTMENT OF PLANNING & ZONING

DIRECTOR: _____ DATE: _____
DEPARTMENT OF TRANSPORTATION & ENVIRONMENTAL SERVICES
SITE PLAN NO. **DSP2011-0027**

DIRECTOR: _____ DATE: _____

CHAIRMAN, PLANNING COMMISSION: _____ DATE: _____

DATE RECORDED: _____

INSTRUMENT NO. _____ DEED BOOK NO. _____ PAGE NO. _____

DATUM:
(HZ) NAD 83
(VT) NAVD 88

60% SUBMITTAL

CONTRACT NO:	REVISIONS			
PROJECT NO:	BY	NO	DATE	DESCRIPTION
	GF	001		DEV. CONCEPT PLAN (30%)
DESIGNED:	GF	002	6/20/16	DEV. SITE PLAN
DRAFTED:				
CHECKED:				
APPROVED:				




VIRGINIA RAILWAY EXPRESS
ALEXANDRIA
PEDESTRIAN TUNNEL

DISCIPLINE:
CIVIL
VRRM WORKSHEETS AND
STORM SEWER COMPUTATION


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C-121


LIST NO:

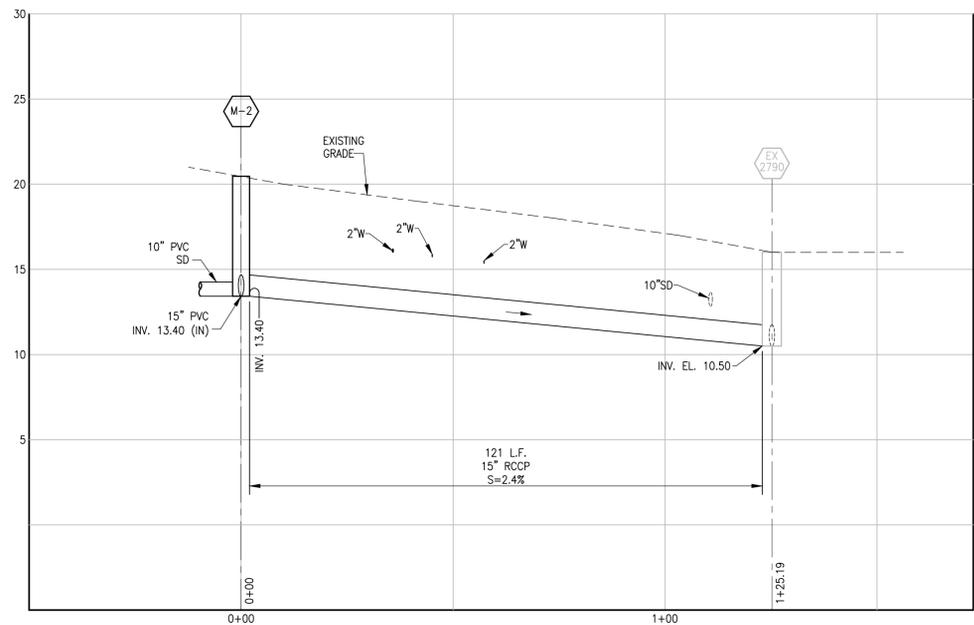

M-2 - EX. INLET 2790
 SCALE: HORIZ. 1"=20'
 VERT. 1"=5'

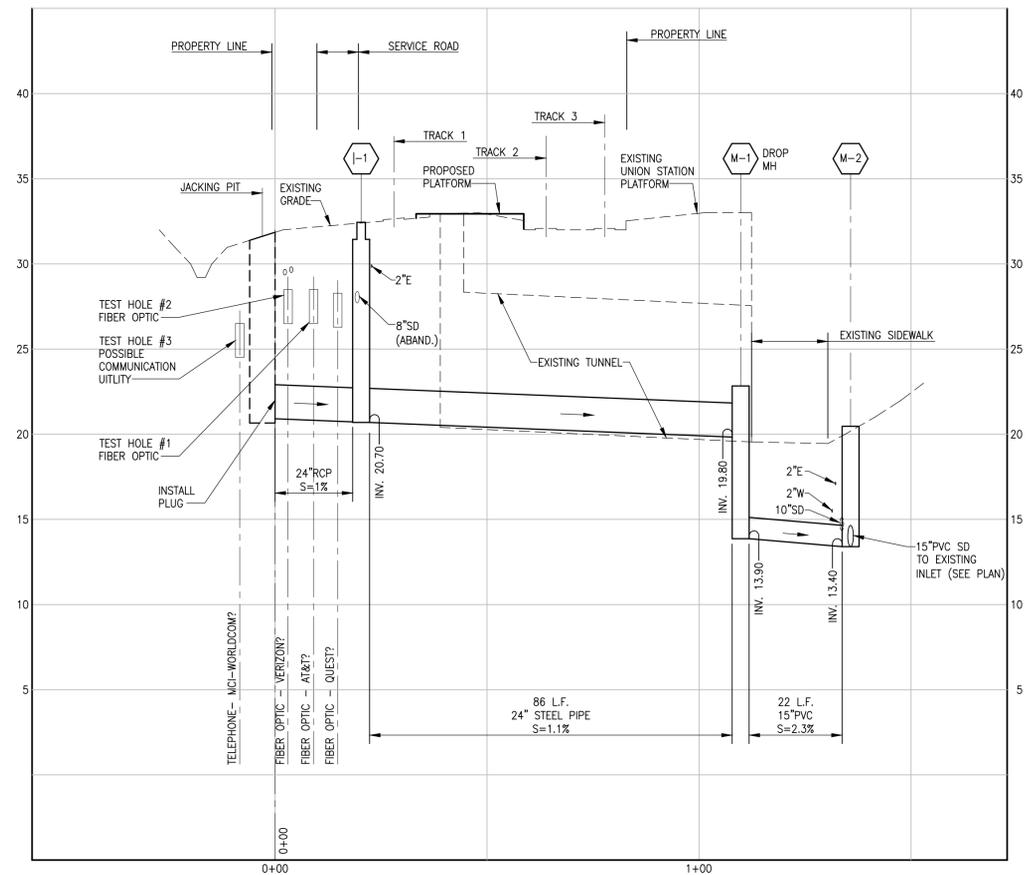

STORM DRAIN PROFILE
 SCALE: HORIZ. 1"=20'
 VERT. 1"=5'

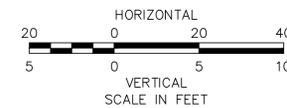

DATUM:
 (HZ) NAD 83
 (VT) NAVD 88

APPROVED
 SPECIAL USE PERMIT NO.
 DEPARTMENT OF PLANNING & ZONING

DIRECTOR _____ DATE _____
 DEPARTMENT OF TRANSPORTATION & ENVIRONMENTAL SERVICES
 SITE PLAN NO. DSP2011-0027

DIRECTOR _____ DATE _____

CHAIRMAN, PLANNING COMMISSION _____ DATE _____

DATE RECORDED _____

INSTRUMENT NO. _____ DEED BOOK NO. _____ PAGE NO. _____

60% SUBMITTAL








CONTRACT NO:	REVISIONS			
PROJECT NO:	BY	NO	DATE	DESCRIPTION
	GF	001		DEV. CONCEPT PLAN (30%)
DESIGNED:	GF	002	6/20/16	DEV. SITE PLAN
DRAFTED:				
CHECKED:				
APPROVED:				



VIRGINIA RAILWAY EXPRESS
 ALEXANDRIA
 PEDESTRIAN TUNNEL

DISCIPLINE:	DRAWING NO:
CIVIL	C-201
STORM DRAIN PROFILE	LIST NO:
SCALE: AS SHOWN	DATE ISSUED: 6/20/16

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- GENERAL NOTES:**
- STRUCTURE SHALL BE CONSTRUCTED USING CAST-IN-PLACE OR PRE-CAST CONCRETE.
 - CONCRETE SHALL MEET $f_c' = 4500$ PSI FOR PRE-CAST UNITS AND $f_c' = 3500$ PSI FOR STRUCTURES CAST-IN-PLACE.
 - SUBMIT SHOP DRAWINGS PER REQUIREMENTS OF SPECIFICATIONS.
 - ALL REINFORCING STEEL SHALL CONFORM TO ASTM A-615, GRADE 60, AND SHALL BE EPOXY COATED. CONCRETE COVER OVER ALL REINFORCING STEEL SHALL MEET THE REQUIREMENT OF LATEST VERSION OF ACI 318. ALL REBAR LAPS, BENDS AND EMBEDMENT DEPTHS SHALL MEET THE REQUIREMENT OF LATEST VERSION OF ACI 318.
 - PRECAST INLET JOINTS - THE MANUFACTURE SHALL FORM MALE AND FEMALE ENDS OF JOINTS USING THEIR OWN DESIGN. THE JOINTS SHALL BE SEALED BY THE CONTRACTOR AND MADE WATERTIGHT USING THE MANUFACTURER'S RECOMMENDED ASTM OR AASHTO APPROVED SEALANT.
 - SEE DETAILS ON DR-16 FOR ADDITIONAL REINFORCING AT WALL OPENING.

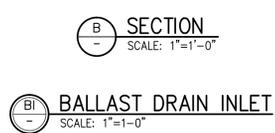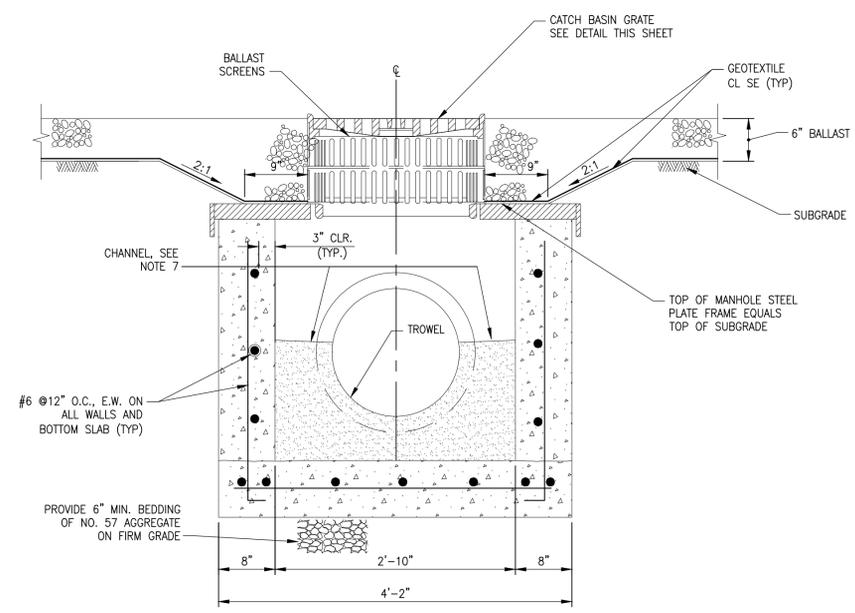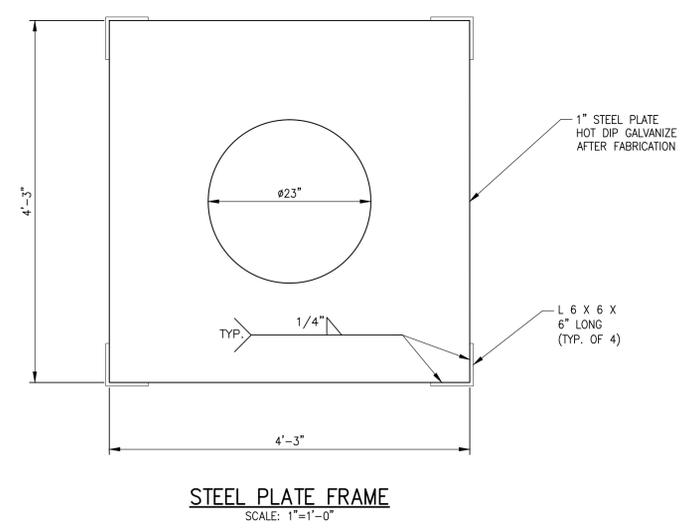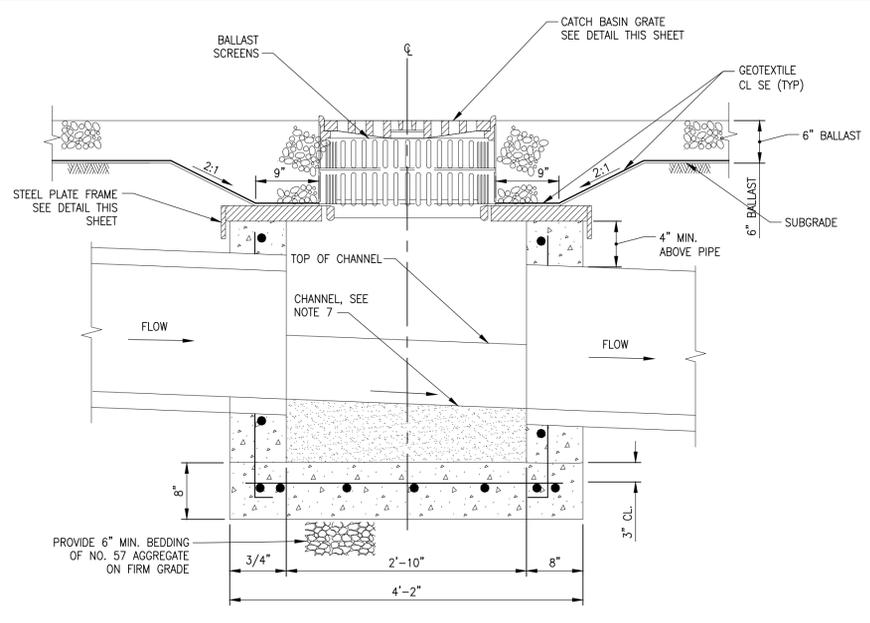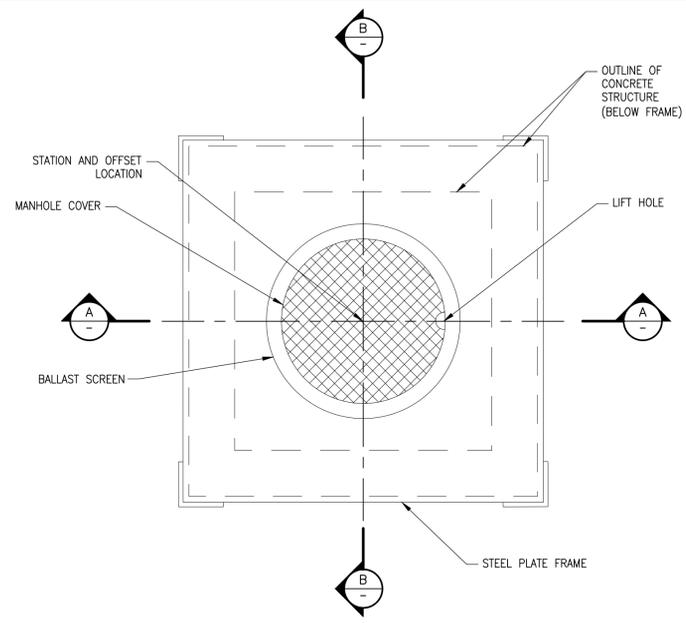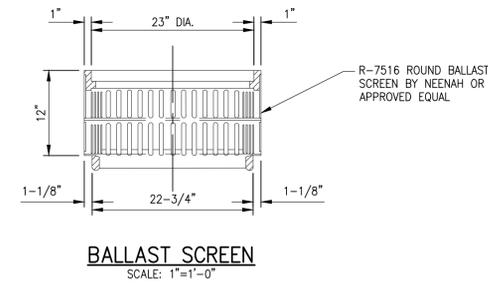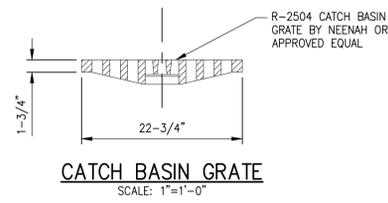60% SUBMITTAL

CONTRACT NO:	REVISIONS	
PROJECT NO:	BY	NO
DATE:	GF	001
DESIGNED:	GF	002
DRAFTED:		
CHECKED:		
APPROVED:		




VIRGINIA RAILWAY EXPRESS
ALEXANDRIA
PEDESTRIAN TUNNEL


DISCIPLINE:	CIVIL
STORM DRAIN DETAILS	
SCALE:	NONE
DATE ISSUED:	6/20/16

DRAWING NO:	C-501
LIST NO:	

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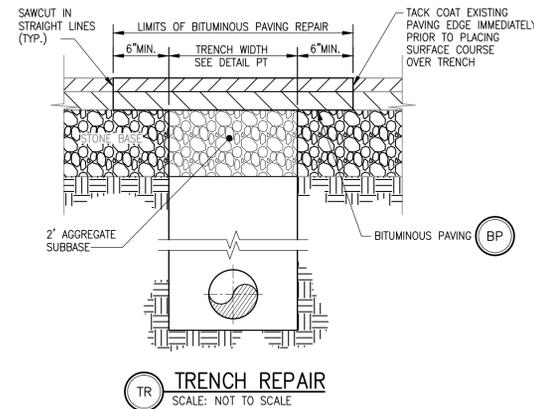


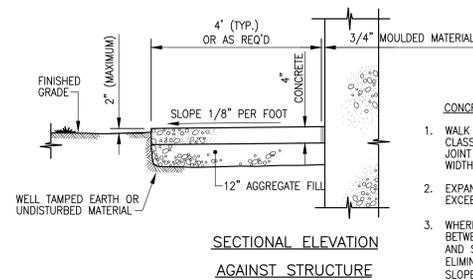- CONCRETE WALK NOTES**
1. WALK TO BE CONSTRUCTED WITH CLASS "A" CONCRETE WITH TOOLED JOINT SPACING EQUAL TO WALK WIDTH, BUT NOT TO EXCEED 6'-0".
 2. EXPANSION JOINT SPACING NOT TO EXCEED 30'-0".
 3. WHERE SIDEWALK IS INSTALLED BETWEEN SLUDGE THICKENING BLDG AND SLUDGE HOLDING TANK, ELIMINATE 1/8" PER FOOT CROSS SLOPE.

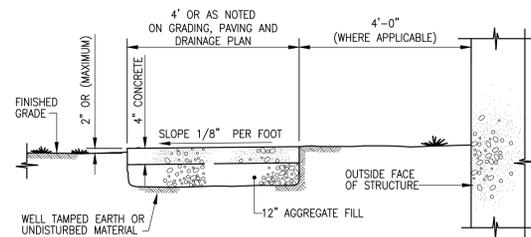


SECTIONAL ELEVATION ELSEWHERE


CW CONCRETE WALK
SCALE: NOT TO SCALE



TR TRENCH REPAIR
SCALE: NOT TO SCALE

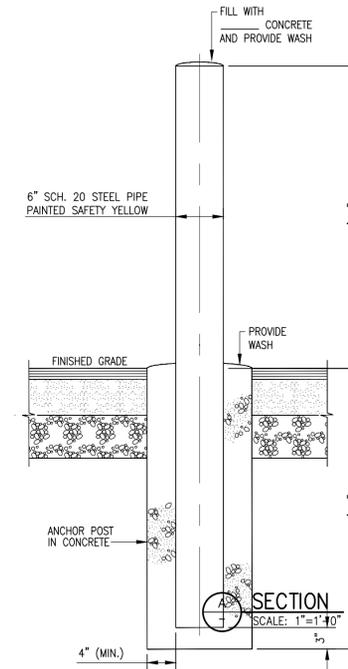


GP GUARD POST
SCALE: (NOT TO SCALE)

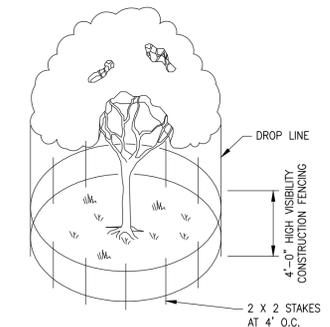

NOTE: DRIVE STAKES FIRMLY INTO GROUND AT LEAST 12"


TP TREE PROTECTION
SCALE: N.T.S.

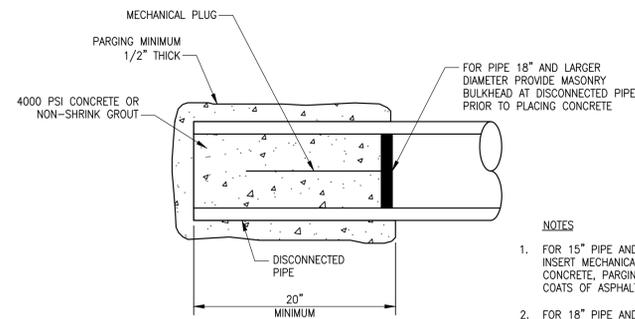

NOTES

1. FOR 15" PIPE AND SMALLER DIAMETER, INSERT MECHANICAL PLUGS, PLACE CONCRETE, PARGING AND COAT WITH TWO COATS OF ASPHALT-BASED COATING.
2. FOR 18" PIPE AND LARGER DIAMETER SAME AS 15" AND SMALLER EXCEPT MASONRY BULKHEAD MAY BE SUBSTITUTED FOR MECHANICAL PLUG.

PP PIPE PLUG/BULKHEAD
SCALE: NOT TO SCALE

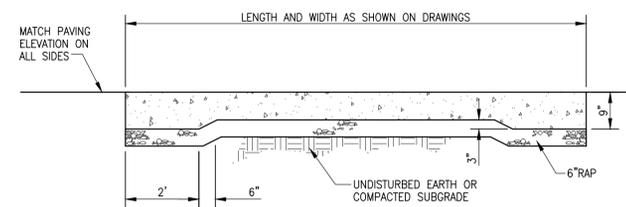

NOTE: EQUIPMENT PAD SHALL BE 9" THICK 4,000 PSI CONCRETE. REINFORCING SHALL CONSIST OF #5 @ 12" BOTH WAYS WITH 2" OF COVER. PADS SHALL BE CONSTRUCTED ON 6" OF RECYCLED ASPHALT PAVING.

EP EQUIPMENT PAD
SCALE: NOT TO SCALE



60% SUBMITTAL

CONTRACT NO:	REVISIONS		
PROJECT NO:	BY	NO	DATE
DESIGNED:	GF	001	
DRAFTED:	GF	002	6/20/16
CHECKED:			
APPROVED:			
			DESCRIPTION
			DEV. CONCEPT PLAN (30%)
			DEV. SITE PLAN




VIRGINIA RAILWAY EXPRESS
ALEXANDRIA
PEDESTRIAN TUNNEL

DISCIPLINE:	DRAWING NO:	
CIVIL DETAILS	C-502	
SCALE:	DATE ISSUED:	LIST NO:
NONE	6/20/16	

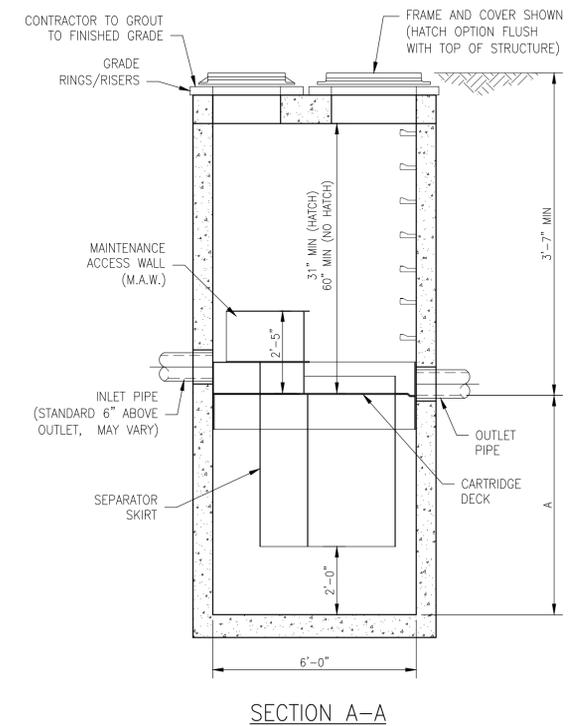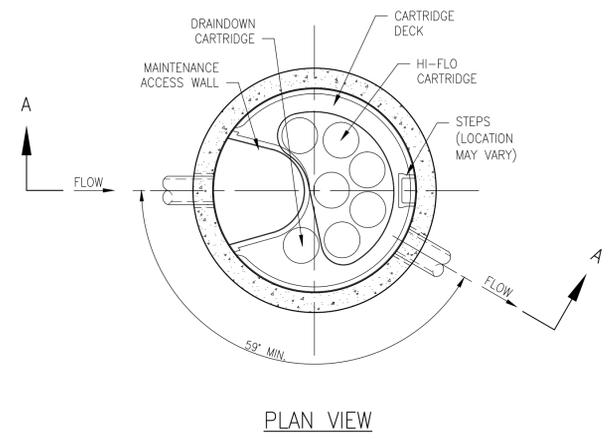

JF JELLYFISH FILTER
SCALE: NOT TO SCALE

JELLYFISH DESIGN NOTES				
JELLYFISH TREATMENT CAPACITY IS A FUNCTION OF THE CARTRIDGE SELECTION AND THE NUMBER OF CARTRIDGES. THE STANDARD MANHOLE STYLE IS SHOWN. #72" MANHOLE JELLYFISH PEAK TREATMENT CAPACITY IS 1.16 CFS. IF THE SITE CONDITIONS EXCEED 1.16 CFS AN UPSTREAM BYPASS STRUCTURE IS REQUIRED.				
CARTRIDGE SELECTION				
CARTRIDGE DEPTH	54"	40"	27"	15"
OUTLET INVERT TO STRUCTURE INVERT (A)	6'-5"	5'-3"	4'-2"	3'-2"
FLOW RATE HIGH-FLO / DRAINDOWN (cfs) (per cart)	0.18 / 0.09	0.13 / 0.065	0.09 / 0.045	0.05 / 0.025
MAX. CARTS HIGH-FLO / DRAINDOWN	6 / 1			

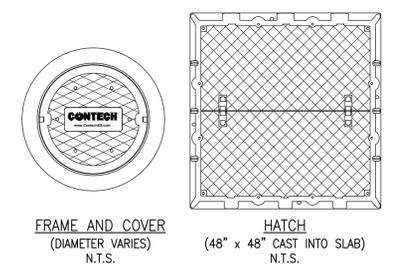

SITE SPECIFIC DATA REQUIREMENTS	
STRUCTURE ID	*
WATER QUALITY FLOW RATE (cfs)	*
PEAK FLOW RATE (cfs)	*
RETURN PERIOD OF PEAK FLOW (yrs)	*
# OF CARTRIDGES REQUIRED (HF / DD)	*/*
CARTRIDGE SIZE	*
PIPE DATA:	I.E. MATERIAL DIAMETER
INLET PIPE #1	* * *
INLET PIPE #2	* * *
OUTLET PIPE	* * *
RIM ELEVATION	*
ANTI-FLOTATION BALLAST	WIDTH HEIGHT
	* *
NOTES/SPECIAL REQUIREMENTS:	
* PER ENGINEER OF RECORD	

- GENERAL NOTES:**
- CONTECH TO PROVIDE ALL MATERIALS UNLESS NOTED OTHERWISE.
 - FOR SITE SPECIFIC DRAWINGS WITH DETAILED STRUCTURE DIMENSIONS AND WEIGHT, PLEASE CONTACT YOUR CONTECH ENGINEERED SOLUTIONS REPRESENTATIVE. www.ContechES.com
 - JELLYFISH WATER QUALITY STRUCTURE SHALL BE IN ACCORDANCE WITH ALL DESIGN DATA AND INFORMATION CONTAINED IN THIS DRAWING. CONTRACTOR TO CONFIRM STRUCTURE MEETS REQUIREMENTS OF PROJECT.
 - STRUCTURE SHALL MEET AASHTO HS-20 OR PER APPROVING JURISDICTION REQUIREMENTS, WHICHEVER IS MORE STRINGENT, ASSUMING EARTH COVER OF 0' - 3', AND GROUNDWATER ELEVATION AT, OR BELOW, THE OUTLET PIPE INVERT ELEVATION. ENGINEER OF RECORD TO CONFIRM ACTUAL GROUNDWATER ELEVATION. CASTINGS SHALL MEET AASHTO M306 LOAD RATINGS AND BE CAST WITH THE CONTECH LOGO.
 - STRUCTURE SHALL BE PRECAST CONCRETE CONFORMING TO ASTM C-478 AND AASHTO LOAD FACTOR DESIGN METHOD.
 - NO PRODUCT SUBSTITUTIONS SHALL BE ACCEPTED UNLESS SUBMITTED 10 DAYS PRIOR TO PROJECT BID DATE, OR AS DIRECTED BY THE ENGINEER OF RECORD.
- INSTALLATION NOTES**
- ANY SUB-BASE, BACKFILL DEPTH, AND/OR ANTI-FLOTATION PROVISIONS ARE SITE-SPECIFIC DESIGN CONSIDERATIONS AND SHALL BE SPECIFIED BY ENGINEER OF RECORD.
 - CONTRACTOR TO PROVIDE EQUIPMENT WITH SUFFICIENT LIFTING AND REACH CAPACITY TO LIFT AND SET THE STRUCTURE (LIFTING CLUTCHES PROVIDED)
 - CONTRACTOR WILL INSTALL AND LEVEL THE STRUCTURE, SEALING THE JOINTS, LINE ENTRY AND EXIT POINTS (NON-SHRINK GROUT WITH APPROVED WATERSTOP OR FLEXIBLE BOOT)
 - CONTRACTOR TO TAKE APPROPRIATE MEASURES TO PROTECT CARTRIDGES FROM CONSTRUCTION-RELATED EROSION RUNOFF.
 - CARTRIDGE INSTALLATION, BY CONTECH, SHALL OCCUR ONLY AFTER SITE HAS BEEN STABILIZED AND THE JELLYFISH UNIT IS CLEAN AND FREE OF DEBRIS. CONTACT CONTECH TO COORDINATE CARTRIDGE INSTALLATION WITH SITE STABILIZATION AT (866) 740-3318.

60% SUBMITTAL

CONTRACT NO:	
PROJECT NO:	
DESIGNED:	
DRAFTED:	
CHECKED:	
APPROVED:	

Gannett Fleming

COMMONWEALTH OF VIRGINIA
MARATHA JEAN AVERSO
Lic. No. 17470
PROFESSIONAL ENGINEER
6-20-16

VRE

VIRGINIA RAILWAY EXPRESS
ALEXANDRIA
PEDESTRIAN TUNNEL

DISCIPLINE:	CIVIL STORMWATER MANAGEMENT DETAILS
SCALE:	AS SHOWN
DATE ISSUED:	6/20/16

DRAWING NO:	C-503
LIST NO:	

EROSION AND SEDIMENT CONTROL NARRATIVE

SITE DESCRIPTION:

ALEXANDRIA UNION STATION IS OWNED BY THE CITY OF ALEXANDRIA AND CURRENTLY PROVIDES PASSENGER INTERVITY TRAVEL SERVICE FROM THE NATIONAL RAILROAD PASSENGER CORPORATION (AMTRAK) AS WELL AS REGIONAL COMMUTER SERVICE FROM VIRGINIA RAILWAY EXPRESS (VRE). THE SITE IS BOUND BY CSX TRANSPORTATION (CSXT) AND WASHINGTON METROPOLITAN AREA TRANSIT AUTHORITY'S (WMATA) KING STREET - OLD TOWN STATION TO THE SOUTH.

PROJECT IMPROVEMENTS:

THE MAIN PROJECT INVOLVES CONSTRUCTION OF A NEW PEDESTRIAN TUNNEL LINKING THE VRE UNION STATION (110 CALLAHAN DRIVE) WITH THE WMATA KING STREET STATION (1900 KING STREET) IN ALEXANDRIA, VA. A SEVERAL CAST IN PLACE MASONRY FACED RETAINING WALLS WILL BE INSTALLED FOR EARTH RETENTION ON THE EXISTING EMBANKMENT AND ALONG THE EXISTING SIDEWALK FOR CONSTRUCTION OF PROPOSED IMPROVEMENTS. THE EAST EDGE OF THE PLATFORM WILL BE WIDENED AND THE SOUTHERN END OF THE PLATFORM WILL BE EXTENDED. A MINOR GRADING OF BALLASTED AREAS ALONG THE PLATFORM EDGE WILL BE REQUIRED. A NEW UNDERDRAIN WILL BE CONSTRUCTED FOR THE DRAINAGE UNDER THE EAST PLATFORM WIDENING AREA. SOME SECTIONS OF CURRENT TUNNEL ENTRANCE SIDEWALK AND THE WEST PLATFORM PAVING WILL REQUIRE REMOVAL DURING THE CONSTRUCTION OF THE OPEN CUT EXCAVATION FOR TUNNEL AND RETAINING WALL CONSTRUCTION ON THE WEST SIDE OF THE TUNNEL (CITY OF ALEXANDRIA PROPERTY). AT THE COMPLETION OF TUNNEL CONSTRUCTION, THE SIDEWALK AND PLATFORM AREA WILL BE REPAIRED WITH REINFORCED CONCRETE HARDCAPE PAVING TO MATCH EXISTING. A NEW SANITARY SEWER PIPE AND SOME UTILITIES RE-CONSTRUCTION WILL BE CARRIED OUT AT THE TUNNEL ENTRANCE (UNION STATION). AN OPEN CUT EXCAVATION WILL BE DONE FOR AN EXISTING UNDERGROUND COMMUNICATION INFRASTRUCTURE AT KING STREET STATION.

SOILS: SEE SOILS MAP (THIS SHEET.)

CRITICAL AREAS: NO CRITICAL AREAS HAVE BEEN IDENTIFIED WITHIN THE LIMITS OF THIS PROJECT.

EROSION AND SEDIMENT CONTROL MEASURES: UNLESS OTHERWISE DIRECTED, ALL VEGETATIVE AND STRUCTURAL EROSION AND SEDIMENT CONTROL PRACTICES SHALL BE CONSTRUCTED AND MAINTAINED IN ACCORDANCE WITH THE MOST CURRENT MINIMUM STANDARDS AND SPECIFICATIONS OF THE VIRGINIA EROSION AND SEDIMENT CONTROL HANDBOOK. ALL NECESSARY EROSION AND SEDIMENT CONTROL MEASURES SHALL BE IN PLACE PRIOR TO BEGINNING CONSTRUCTION.

STRUCTURAL PRACTICES:

- SILT FENCE BARRIER (3.05) - SILT FENCE SEDIMENT BARRIERS SHALL BE INSTALLED TO FILTER SEDIMENT-LADEN RUNOFF AS SHOWN ON THE E&SC PLAN.
- STORM DRAIN INLET PROTECTION (3.07) - ALL STORM SEWER INLETS SHALL BE PROTECTED DURING CONSTRUCTION. SEDIMENT-LADEN WATER SHALL BE FILTERED BEFORE ENTERING THE STORM SEWER INLETS.
- PERMANENT SEEDING (3.32) - PERENNIAL VEGETATIVE COVER SHALL BE ESTABLISHED ON DISTURBED AREAS BY PLANTING SEED TO REDUCE EROSION, DECREASE SEDIMENT YIELD, AND TO PERMANENTLY STABILIZE DISTURBED AREAS. SELECTION OF THE SEED MIXTURE WILL DEPEND ON THE TIME OF YEAR IT IS APPLIED.

PERMANENT STABILIZATION: PERMANENT STABILIZATION SHALL BE DONE IN ACCORDANCE WITH THE VIRGINIA EROSION AND SEDIMENT CONTROL HANDBOOK (SEE THIS SHEET FOR SEED MIXTURES). IN ALL SEEDING OPERATIONS, SEED, FERTILIZER AND LIME WILL BE APPLIED PRIOR TO MULCHING. ALL AREAS DISTURBED BY CONSTRUCTION SHALL BE STABILIZED WITH PERMANENT SEEDING IMMEDIATELY FOLLOWING FINISH GRADING. EROSION AND SEDIMENT CONTROL MEASURES SHALL REMAIN IN PLACE UNTIL THE GRASS IS ESTABLISHED.

STORMWATER MANAGEMENT:

MAINTENANCE: IN GENERAL, ALL EROSION AND SEDIMENT CONTROL MEASURES SHALL BE CHECKED DAILY AND AFTER EACH SIGNIFICANT RAINFALL.

- TEMPORARY SEEDING OR OTHER STABILIZATION WILL FOLLOW IMMEDIATELY AFTER GRADING.
- THE JOB SUPERINTENDENT SHALL BE RESPONSIBLE FOR THE INSTALLATION, DAILY INSPECTION, AND MAINTENANCE OF ALL EROSION AND SEDIMENT CONTROL PRACTICES.

NOTES:

- AN EROSION & SEDIMENT CONTROL CONTRACTOR CERTIFICATION (ESCCC) IS REQUIRED FOR ALL LAND DISTURBING ACTIVITIES OCCURRING WITHIN THE STATE'S RIGHT OF WAY.
- THE COUNTY IS RESPONSIBLE FOR COMPLYING WITH APPLICABLE LOCAL, STATE, AND FEDERAL ENVIRONMENTAL LAWS AND REGULATIONS, INCLUDING ACQUIRING CLEARANCES/AUTHORIZATIONS FROM APPROPRIATE REGULATORY AGENCIES.
- ALL E&S CONTROLS SHALL BE REMOVED WITHIN 30 DAYS AFTER PROJECT IS STABILIZED.

SOIL ID NUMBERS	SOIL SERIES NAME	FOUNDATION SUPPORT	SOIL DRAINAGE	EROSION POTENTIAL
71C	KINGSTOWNE- SASSAFRAS MARUMSCO COMPLEX		MODERATELY WELL DRAINED	MODERATE
66	KINGSTOWNE- SANDY CLAY LOAM		WELL DRAINED	SEVERE
95	URBAN LAND		NONE SPECIFIED	NONE SPECIFIED
98	URBAN LAND- GRIST MILL		NONE SPECIFIED	NONE SPECIFIED

IS THE SITE LOCATED WITHIN NATURALLY OCCURRING ASBESTOS SOILS?

YES NO

AREAS THAT MAY CONTAIN NATURALLY OCCURRING ASBESTOS SOILS ARE LOCATED ON THE ORANGE SOILS TAX MAP GRIDS ON THE COUNTY WEBSITE. SPECIAL PRECAUTIONS REGARDING THESE SOILS OR FILL ORIGINATING FROM THESE SOILS ARE REQUIRED BY THE OCCUPATIONAL SAFETY AND HEALTH REGULATIONS ENFORCED BY THE VIRGINIA DEPARTMENT OF LABOR AND INDUSTRY AND SPECIAL GUIDANCE HAS BEEN ISSUED BY THE U.S. ENVIRONMENTAL PROTECTION AGENCY.

LIME APPLICATION RATE: 2 TONS PER ACRE

FERTILIZER APPLICATION RATE: 300 LBS/ACRE (15-30-15)

EROSION CONTROL MULCH RATE: 1,210 SY PER 100 FEET



SOIL MAP

SITE SPECIFIC SEEDING MIXTURES FOR PIEDMONT AREA	
MINIMUM CARE LAWN	TOTAL LBS PER ACRE
COMMERCIAL OR RESIDENTIAL	175-200 LBS
-KENTUCKY 31 OR TURF-TYPE TALL FESCUE	95-100%
-IMPROVED PERENNIAL RYEGRASS	0-5%
-KENTUCKY BLUEGRASS	0-5%
GENERAL SLOPE (3:1 OR LESS)	
-KENTUCKY 31 FESCUE	128 LBS
-RED TOP GRASS	2 LBS
-SEASONAL NURSE CROP*	20 LBS
	150 LBS
LOW MAINTENANCE SLOPE (STEEPER THAN 3:1)	
-KENTUCKY 31 FESCUE	108 LBS
-RED TOP GRASS	2 LBS
-SEASONAL NURSE CROP*	20 LBS
-CROWN VETCH**	20 LBS
	150 LBS
*USE SEASONAL NURSE CROP IN ACCORDANCE WITH SEEDING DATES AS STATED BELOW	
FEBRUARY 16TH THROUGH APRIL	ANNUAL RYE
MAY 1ST THROUGH AUGUST 15TH	FOXTAIL MILLET
AUGUST 16 THROUGH OCTOBER	ANNUAL RYE
NOVEMBER THROUGH FEBRUARY 15TH	WINTER RYE
**SUBSTITUTE SERICEA LESPEDEZA FOR CROWN VETCH EAST OF FARMVILLE, VA (MAY THROUGH SEPTEMBER USE HULLED SERICEA, ALL OTHER PERIODS, USE UNHULLED SERICEA). IF FLATPEA IS USED IN LIEU OF CORNVETCH, INCREASE RATE TO 30LBS/ACRE. ALL LEGUME SEED MUST BE PROPERLY INOCULATED. WEEPING LOVEGRASS MAY BE ADDED TO ANY SLOPE OR LOW-MAINTENANCE MIX DURING WARMER SEEDING PERIODS; ADD 10-20 LBS/ACRE IN MIXES.	



APPROVED
SPECIAL USE PERMIT NO.
DEPARTMENT OF PLANNING & ZONING

DIRECTOR _____ DATE _____
DEPARTMENT OF TRANSPORTATION & ENVIRONMENTAL SERVICES
SITE PLAN NO. DSP2011-0027

DIRECTOR _____ DATE _____

CHAIRMAN, PLANNING COMMISSION _____ DATE _____

DATE RECORDED _____

INSTRUMENT NO. _____ DEED BOOK NO. _____ PAGE NO. _____

DATUM:
(HZ) NAD 83
(VT) NAVD 88

60% SUBMITTAL

CONTRACT NO:	BY	NO	DATE	DESCRIPTION				VIRGINIA RAILWAY EXPRESS ALEXANDRIA PEDESTRIAN TUNNEL	DISCIPLINE:	DRAWING NO:
PROJECT NO:	GF	001		DEV. CONCEPT PLAN (30%)					CIVIL	C-504
DESIGNED:	GF	002	6/20/16	DEV. SITE PLAN				EROSION AND SEDIMENT CONTROL NOTES AND NARRATIVE	LIST NO:	
DRAFTED:								SCALE: NONE	DATE ISSUED: 6/20/16	
CHECKED:										
APPROVED:										

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4VAC50-30-40 EROSION AND SEDIMENT CONTROL MINIMUM STANDARDS

MS-1: PERMANENT OR TEMPORARY SOIL STABILIZATION SHALL BE APPLIED TO DENUDED AREAS WITHIN SEVEN DAYS AFTER FINAL GRADE IS REACHED ON ANY PORTION OF THE SITE. TEMPORARY SOIL STABILIZATION SHALL BE APPLIED WITHIN SEVEN DAYS TO DENUDED AREAS THAT MAY NOT BE AT FINAL GRADE BUT WILL REMAIN DORMANT FOR LONGER THAN 30 DAYS. PERMANENT STABILIZATION SHALL BE APPLIED TO AREAS THAT ARE TO BE LEFT DORMANT FOR MORE THAN ONE YEAR.

MS-2: DURING CONSTRUCTION OF THE PROJECT, SOIL STOCK PILES AND BORROW AREAS SHALL BE STABILIZED OR PROTECTED WITH SEDIMENT TRAPPING MEASURES. THE APPLICANT IS RESPONSIBLE FOR THE TEMPORARY PROTECTION AND PERMANENT STABILIZATION OF ALL SOIL STOCKPILES ON SITE AS WELL AS BORROW AREAS AND SOIL INTENTIONALLY TRANSPORTED FROM THE PROJECT SITE.

MS-3: A PERMANENT VEGETATIVE COVER SHALL BE ESTABLISHED ON DENUDED AREAS NOT OTHERWISE PERMANENTLY STABILIZED. PERMANENT VEGETATION SHALL NOT BE CONSIDERED ESTABLISHED UNTIL A GROUND COVER IS ACHIEVED THAT IS UNIFORM, MATURE ENOUGH TO SURVIVE AND WILL INHIBIT EROSION.

MS-4: SEDIMENT BASINS AND TRAPS, PERIMETER DIKES, SEDIMENT BARRIERS AND OTHER MEASURES INTENDED TO TRAP SEDIMENT SHALL BE CONSTRUCTED AS A FIRST STEP IN ANY LAND-DISTURBING ACTIVITY AND SHALL BE MADE FUNCTIONAL BEFORE UPSLOPE LAND DISTURBANCE TAKES PLACE.

MS-5: STABILIZATION MEASURES SHALL BE APPLIED TO EARTHEN STRUCTURES SUCH AS DAMS, DIKES AND DIVERSIONS IMMEDIATELY AFTER INSTALLATION.

MS-6: SEDIMENT TRAPS AND SEDIMENT BASINS SHALL BE DESIGNED AND CONSTRUCTED BASED UPON THE TOTAL DRAINAGE AREA TO BE SERVED BY THE TRAP OR BASIN.

A. THE MINIMUM STORAGE CAPACITY OF A SEDIMENT TRAP SHALL BE 134 CUBIC YARDS PER ACRE OF DRAINAGE AREA AND THE TRAP SHALL ONLY CONTROL DRAINAGE AREAS LESS THAN THREE ACRES.

B. SURFACE RUNOFF FROM DISTURBED AREAS THAT IS COMPRISED OF FLOW FROM DRAINAGE AREAS GREATER THAN OR EQUAL TO THREE ACRES SHALL BE CONTROLLED BY A SEDIMENT BASIN. THE MINIMUM STORAGE CAPACITY OF A SEDIMENT BASIN SHALL BE 134 CUBIC YARDS PER ACRE OF DRAINAGE AREA. THE OUTFALL SYSTEM SHALL, AT A MINIMUM, MAINTAIN THE STRUCTURAL INTEGRITY OF THE BASIN DURING A 25-YEAR STORM OF 24-HOUR DURATION. RUNOFF COEFFICIENTS USED IN RUNOFF CALCULATIONS SHALL CORRESPOND TO A BARE EARTH CONDITION OR THOSE CONDITIONS EXPECTED TO EXIST WHILE THE SEDIMENT BASIN IS UTILIZED.

MS-7: CUT AND FILL SLOPES SHALL BE DESIGNED AND CONSTRUCTED IN A MANNER THAT WILL MINIMIZE EROSION. SLOPES THAT ARE FOUND TO BE ERODING EXCESSIVELY WITHIN ONE YEAR OF PERMANENT STABILIZATION SHALL BE PROVIDED WITH ADDITIONAL SLOPE STABILIZING MEASURES UNTIL THE PROBLEM IS CORRECTED.

MS-8: CONCENTRATED RUNOFF SHALL NOT FLOW DOWN CUT OR FILL SLOPES UNLESS CONTAINED WITHIN AN ADEQUATE TEMPORARY OR PERMANENT CHANNEL, FLUME OR SLOPE DRAIN STRUCTURE.

MS-9: WHENEVER WATER SEEPS FROM A SLOPE FACE, ADEQUATE DRAINAGE OR OTHER PROTECTION SHALL BE PROVIDED.

MS-10: ALL STORM SEWER INLETS THAT ARE MADE OPERABLE DURING CONSTRUCTION SHALL BE PROTECTED SO THAT SEDIMENT-LOADED WATER CANNOT ENTER THE CONVEYANCE SYSTEM WITHOUT FIRST BEING FILTERED OR OTHERWISE TREATED TO REMOVE SEDIMENT.

MS-11: BEFORE NEWLY CONSTRUCTED STORMWATER CONVEYANCE CHANNELS OR PIPES ARE MADE OPERATIONAL, ADEQUATE OUTLET PROTECTION AND ANY REQUIRED TEMPORARY OR PERMANENT CHANNEL LINING SHALL BE INSTALLED IN BOTH THE CONVEYANCE CHANNEL AND RECEIVING CHANNEL.

MS-12: WHEN WORK IN A LIVE WATERCOURSE IS PERFORMED, PRECAUTIONS SHALL BE TAKEN TO MINIMIZE ENCROACHMENT, CONTROL SEDIMENT TRANSPORT AND STABILIZE THE WORK AREA TO THE GREATEST EXTENT POSSIBLE DURING CONSTRUCTION. NONERODIBLE MATERIAL SHALL BE USED FOR THE CONSTRUCTION OF CAUSEWAYS AND COFFERDAMS. EARTHEN FILL MAY BE USED FOR THESE STRUCTURES IF ARMORED BY NONERODIBLE COVER MATERIALS.

MS-13: WHEN A LIVE WATERCOURSE MUST BE CROSSED BY CONSTRUCTION VEHICLES MORE THAN TWICE IN ANY SIX-MONTH PERIOD, A TEMPORARY VEHICULAR STREAM CROSSING CONSTRUCTED OF NONERODIBLE MATERIAL SHALL BE PROVIDED.

MS-14: ALL APPLICABLE FEDERAL, STATE AND LOCAL CHAPTERS PERTAINING TO WORKING IN OR CROSSING LIVE WATERCOURSES SHALL BE MET.

MS-15: THE BED AND BANKS OF A WATERCOURSE SHALL BE STABILIZED IMMEDIATELY AFTER WORK IN THE WATERCOURSE IS COMPLETED.

MS-16: UNDERGROUND UTILITY LINES SHALL BE INSTALLED IN ACCORDANCE WITH THE FOLLOWING STANDARDS IN ADDITION TO OTHER APPLICABLE CRITERIA:

- A. NO MORE THAN 500 LINEAR FEET OF TRENCH MAY BE OPENED AT ONE TIME.
- B. EXCAVATED MATERIAL SHALL BE PLACED ON THE UPHILL SIDE OF TRENCHES.
- C. EFFLUENT FROM DEWATERING OPERATIONS SHALL BE FILTERED OR PASSED THROUGH AN APPROVED SEDIMENT TRAPPING DEVICE, OR BOTH, AND DISCHARGED IN A MANNER THAT DOES NOT ADVERSELY AFFECT FLOWING STREAMS OR OFF-SITE PROPERTY.
- D. MATERIAL USED FOR BACKFILLING TRENCHES SHALL BE PROPERLY COMPACTED IN ORDER TO MINIMIZE EROSION AND PROMOTE STABILIZATION.
- E. RESTABILIZATION SHALL BE ACCOMPLISHED IN ACCORDANCE WITH THIS CHAPTER.
- F. APPLICABLE SAFETY CHAPTERS SHALL BE COMPLIED WITH.

4VAC50-30-40 EROSION AND SEDIMENT CONTROL MINIMUM STANDARDS (CONT'S)

MS-17: WHERE CONSTRUCTION VEHICLE ACCESS ROUTES INTERSECT PAVED OR PUBLIC ROADS, PROVISIONS SHALL BE MADE TO MINIMIZE THE TRANSPORT OF SEDIMENT BY VEHICULAR TRACKING ONTO THE PAVED SURFACE. WHERE SEDIMENT IS TRANSPORTED ONTO A PAVED OR PUBLIC ROAD SURFACE, THE ROAD SURFACE SHALL BE CLEANED THOROUGHLY AT THE END OF EACH DAY. SEDIMENT SHALL BE REMOVED FROM THE ROADS BY SHOVELING OR SWEEPING AND TRANSPORTED TO A SEDIMENT CONTROL DISPOSAL AREA. STREET WASHING SHALL BE ALLOWED ONLY AFTER SEDIMENT IS REMOVED IN THIS MANNER. THIS PROVISION SHALL APPLY TO INDIVIDUAL DEVELOPMENT LOTS AS WELL AS TO LARGER LAND-DISTURBING ACTIVITIES.

MS-18: ALL TEMPORARY EROSION AND SEDIMENT CONTROL MEASURES SHALL BE REMOVED WITHIN 30 DAYS AFTER FINAL SITE STABILIZATION OR AFTER THE TEMPORARY MEASURES ARE NO LONGER NEEDED, UNLESS OTHERWISE AUTHORIZED BY THE LOCAL PROGRAM AUTHORITY. TRAPPED SEDIMENT AND THE DISTURBED SOIL AREAS RESULTING FROM THE DISPOSITION OF TEMPORARY MEASURES SHALL BE PERMANENTLY STABILIZED TO PREVENT FURTHER EROSION AND SEDIMENTATION.

MS-19: PROPERTIES AND WATERWAYS DOWNSTREAM FROM DEVELOPMENT SITES SHALL BE PROTECTED FROM SEDIMENT DEPOSITION, EROSION AND DAMAGE DUE TO INCREASES IN VOLUME, VELOCITY AND PEAK FLOW RATE OF STORMWATER RUNOFF FOR THE STATED FREQUENCY STORM OF 24-HOUR DURATION IN ACCORDANCE WITH THE FOLLOWING STANDARDS AND CRITERIA:

A. CONCENTRATED STORMWATER RUNOFF LEAVING A DEVELOPMENT SITE SHALL BE DISCHARGED DIRECTLY INTO AN ADEQUATE NATURAL OR MAN-MADE RECEIVING CHANNEL, PIPE OR STORM SEWER SYSTEM. FOR THOSE SITES WHERE RUNOFF IS DISCHARGED INTO A PIPE OR PIPE SYSTEM, DOWNSTREAM STABILITY ANALYSES AT THE OUTFALL OF THE PIPE OR PIPE SYSTEM SHALL BE PERFORMED.

B. ADEQUACY OF ALL CHANNELS AND PIPES SHALL BE VERIFIED IN THE FOLLOWING MANNER:

(1) THE APPLICANT SHALL DEMONSTRATE THAT THE TOTAL DRAINAGE AREA TO THE POINT OF ANALYSIS WITHIN THE CHANNEL IS ONE HUNDRED TIMES GREATER THAN THE CONTRIBUTING DRAINAGE AREA OF THE PROJECT IN QUESTION; OR

(2)(A) NATURAL CHANNELS SHALL BE ANALYZED BY THE USE OF A TWO-YEAR STORM TO VERIFY THAT STORMWATER WILL NOT OVERTOP CHANNEL BANKS NOR CAUSE EROSION OF CHANNEL BED OR BANKS.

(B) ALL PREVIOUSLY CONSTRUCTED MAN-MADE CHANNELS SHALL BE ANALYZED BY THE USE OF A TEN-YEAR STORM TO VERIFY THAT STORMWATER WILL NOT OVERTOP ITS BANKS AND BY THE USE OF A TWO-YEAR STORM TO DEMONSTRATE THAT STORMWATER WILL NOT CAUSE EROSION OF CHANNEL BED OR BANKS; AND

(C) PIPES AND STORM SEWER SYSTEMS SHALL BE ANALYZED BY THE USE OF A TEN-YEAR STORM TO VERIFY THAT STORMWATER WILL BE CONTAINED WITHIN THE PIPE OR SYSTEM.

C. IF EXISTING NATURAL RECEIVING CHANNELS OR PREVIOUSLY CONSTRUCTED MAN-MADE CHANNELS OR PIPES ARE NOT ADEQUATE, THE APPLICANT SHALL:

(1) IMPROVE THE CHANNELS TO A CONDITION WHERE A TEN-YEAR STORM WILL NOT OVERTOP THE BANKS AND A TWO-YEAR STORM WILL NOT CAUSE EROSION TO THE CHANNEL BED OR BANKS; OR

(2) IMPROVE THE PIPE OR PIPE SYSTEM TO A CONDITION WHERE THE TEN-YEAR STORM IS CONTAINED WITHIN THE APPURTENANCES;

(3) DEVELOP A SITE DESIGN THAT WILL NOT CAUSE THE PRE-DEVELOPMENT PEAK RUNOFF RATE FROM A TWO-YEAR STORM TO INCREASE WHEN RUNOFF OUTFALLS INTO A NATURAL CHANNEL OR WILL NOT CAUSE THE PRE-DEVELOPMENT PEAK RUNOFF RATE FROM A TEN-YEAR STORM TO INCREASE WHEN RUNOFF OUTFALLS INTO A MAN-MADE CHANNEL; OR

(4) PROVIDE A COMBINATION OF CHANNEL IMPROVEMENT, STORMWATER DETENTION OR OTHER MEASURES WHICH IS SATISFACTORY TO THE PLAN APPROVING AUTHORITY TO PREVENT DOWNSTREAM EROSION.

D. THE APPLICANT SHALL PROVIDE EVIDENCE OF PERMISSION TO MAKE THE IMPROVEMENTS.

E. ALL HYDROLOGIC ANALYSES SHALL BE BASED ON THE EXISTING WATERSHED CHARACTERISTICS AND THE ULTIMATE DEVELOPMENT CONDITION OF THE SUBJECT PROJECT.

F. IF THE APPLICANT CHOOSES AN OPTION THAT INCLUDES STORMWATER DETENTION, HE SHALL OBTAIN APPROVAL FROM THE LOCALITY OF A PLAN FOR MAINTENANCE OF THE DETENTION FACILITIES. THE PLAN SHALL SET FORTH THE MAINTENANCE REQUIREMENTS OF THE FACILITY AND THE PERSON RESPONSIBLE FOR PERFORMING THE MAINTENANCE.

G. OUTFALL FROM A DETENTION FACILITY SHALL BE DISCHARGED TO A RECEIVING CHANNEL, AND ENERGY DISSIPATORS SHALL BE PLACED AT THE OUTFALL OF ALL DETENTION FACILITIES AS NECESSARY TO PROVIDE A STABILIZED TRANSITION FROM THE FACILITY TO THE RECEIVING CHANNEL.

H. ALL ON-SITE CHANNELS MUST BE VERIFIED TO BE ADEQUATE.

I. INCREASED VOLUMES OF SHEET FLOWS THAT MAY CAUSE EROSION OR SEDIMENTATION ON ADJACENT PROPERTY SHALL BE DIVERTED TO A STABLE OUTLET, ADEQUATE CHANNEL, PIPE OR PIPE SYSTEM, OR TO A DETENTION FACILITY.

4VAC50-30-40 EROSION AND SEDIMENT CONTROL MINIMUM STANDARDS (CONT'S)

J. IN APPLYING THESE STORMWATER MANAGEMENT CRITERIA, INDIVIDUAL LOTS OR PARCELS IN A RESIDENTIAL, COMMERCIAL OR INDUSTRIAL DEVELOPMENT SHALL NOT BE CONSIDERED TO BE SEPARATE DEVELOPMENT PROJECTS. INSTEAD, THE DEVELOPMENT, AS A WHOLE, SHALL BE CONSIDERED TO BE A SINGLE DEVELOPMENT PROJECT. HYDROLOGIC PARAMETERS THAT REFLECT THE ULTIMATE DEVELOPMENT CONDITION SHALL BE USED IN ALL ENGINEERING CALCULATIONS.

K. ALL MEASURES USED TO PROTECT PROPERTIES AND WATERWAYS SHALL BE EMPLOYED IN A MANNER WHICH MINIMIZES IMPACTS ON THE PHYSICAL, CHEMICAL AND BIOLOGICAL INTEGRITY OF RIVERS, STREAMS AND OTHER WATERS OF THE STATE.








APPROVED SPECIAL USE PERMIT NO. DEPARTMENT OF PLANNING & ZONING		
DIRECTOR _____	DATE _____	
DEPARTMENT OF TRANSPORTATION & ENVIRONMENTAL SERVICES		
SITE PLAN NO. <u>DSP2011-0027</u>		
DIRECTOR _____	DATE _____	
CHAIRMAN, PLANNING COMMISSION _____ DATE _____		
DATE RECORDED _____		
INSTRUMENT NO. _____	DEED BOOK NO. _____	PAGE NO. _____

DATUM:
(HZ) NAD 83
(VT) NAVD 88

60% SUBMITTAL

CONTRACT NO:		REVISIONS					VIRGINIA RAILWAY EXPRESS	DISCIPLINE: CIVIL EROSION AND SEDIMENT CONTROL MINIMUM STANDARDS	DRAWING NO: C-505
PROJECT NO:	DATE:	BY	NO						
		GF	001		DEV. CONCEPT PLAN (30%)				
DESIGNED:		GF	002	6/20/16	DEV. SITE PLAN				
DRAFTED:									
CHECKED:									
APPROVED:									

SCALE:	NONE	DATE ISSUED:	6/20/16
LIST NO:			

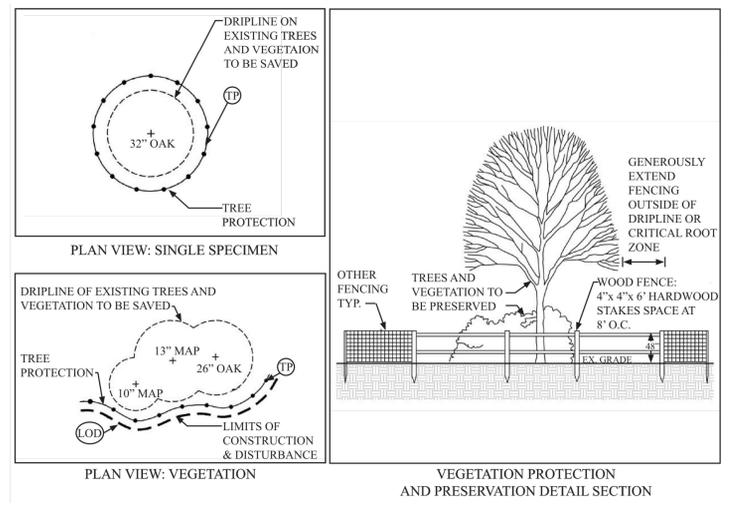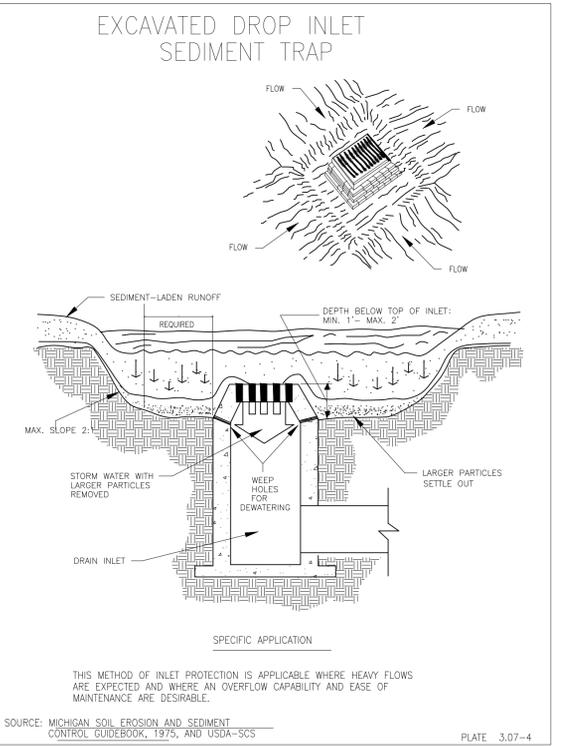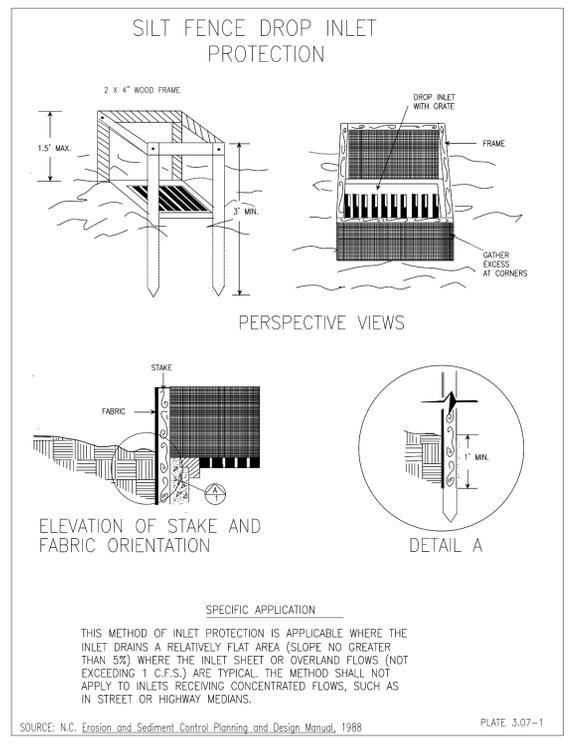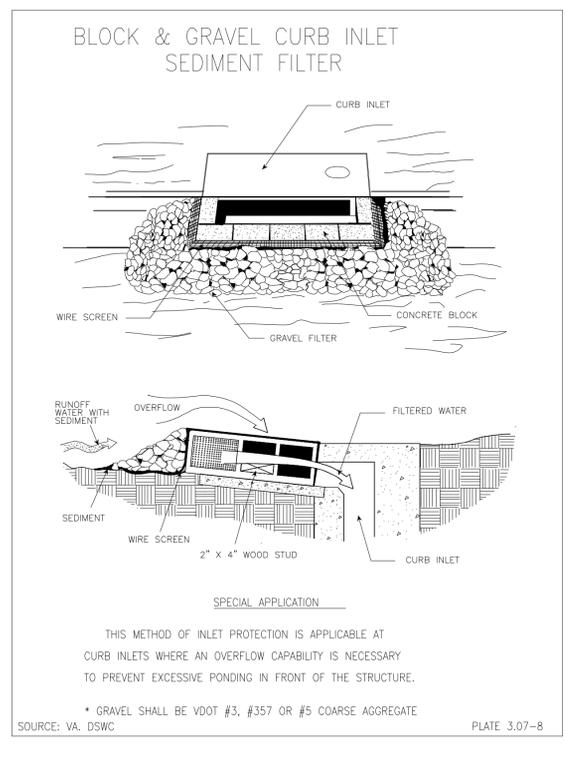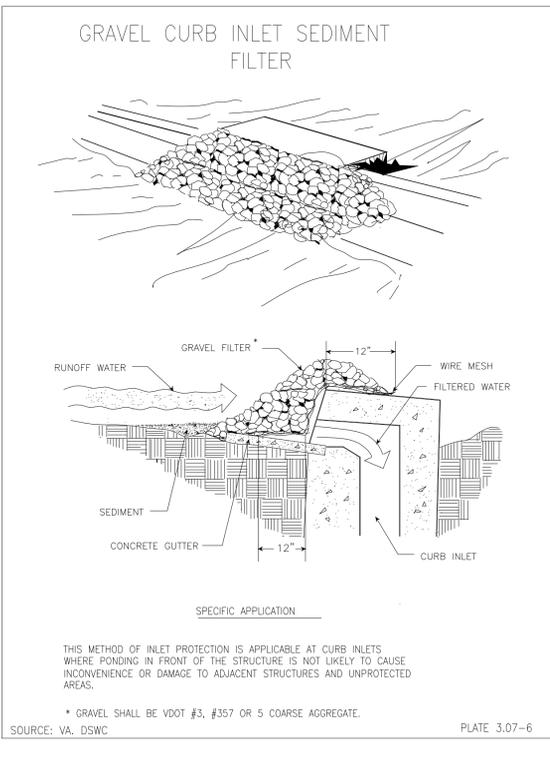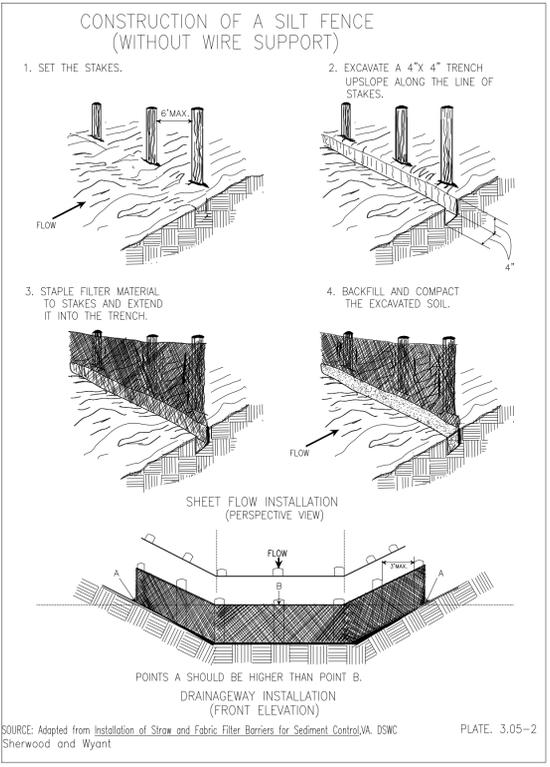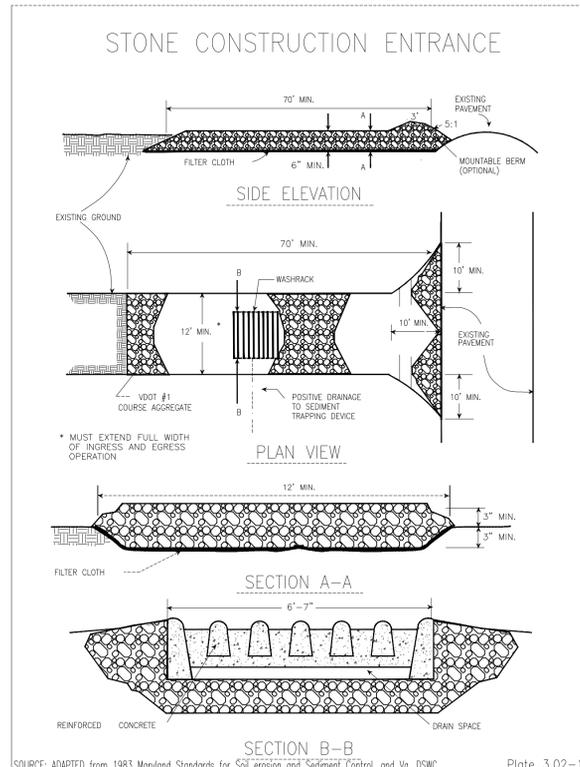

APPROVED SPECIAL USE PERMIT NO. _____
DEPARTMENT OF PLANNING & ZONING

DIRECTOR _____ DATE _____
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VIRGINIA RAILWAY EXPRESS
ALEXANDRIA
PEDESTRIAN TUNNEL


DISCIPLINE:
CIVIL
EROSION AND SEDIMENT CONTROL
DETAILS

SCALE: NONE DATE ISSUED: 6/20/16


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C-506
LIST NO:

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SAFETY FENCE

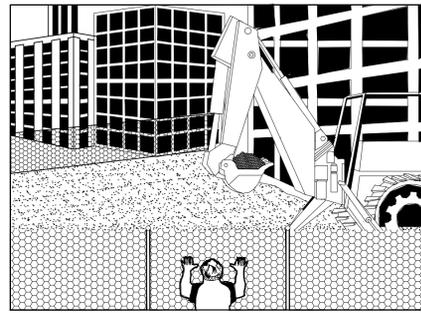

PERSPECTIVE VIEW

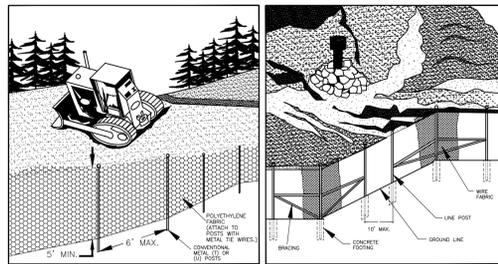


PERSPECTIVE VIEW
PLASTIC FENCE

PERSPECTIVE VIEW
METAL FENCE


SOURCE: CONWED PLASTICS
VDOT ROAD AND BRIDGE STANDARDS
VA. DSWC

PLATE: 3.1-1

PORTABLE SEDIMENT TANK

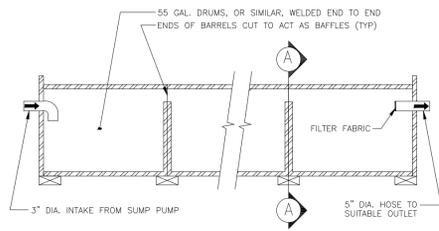

ELEVATION

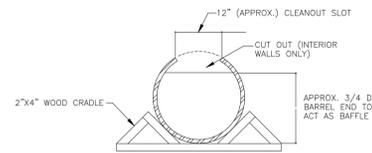


CROSS-SECTION A-A


SOURCE: USDA - SCS

PLATE: 3.26-1

FENCING AND ARMORING

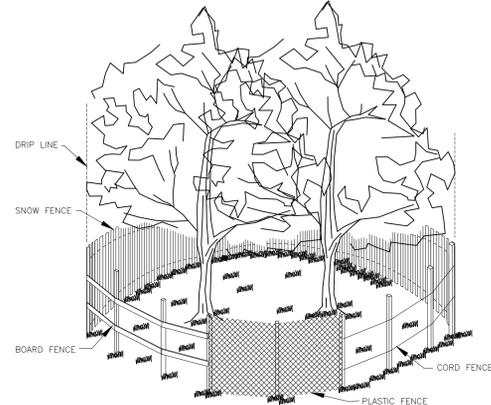

CORRECT METHODS OF TREE FENCING

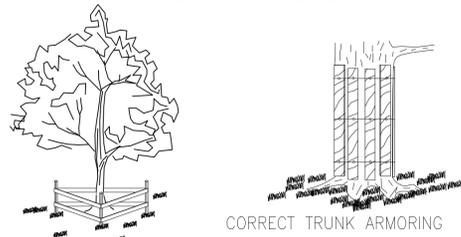

TRIANGULAR BOARD FENCE

CORRECT TRUNK ARMORING

Source: Va. DSWC

Plate 3.38-2

APPROVED
SPECIAL USE PERMIT NO.
DEPARTMENT OF PLANNING & ZONING

DIRECTOR _____ DATE _____
DEPARTMENT OF TRANSPORTATION & ENVIRONMENTAL SERVICES
SITE PLAN NO. DSP2011-0027

DIRECTOR _____ DATE _____

CHAIRMAN, PLANNING COMMISSION _____ DATE _____

DATE RECORDED _____

INSTRUMENT NO. _____ DEED BOOK NO. _____ PAGE NO. _____

DATUM:
(HZ) NAD 83
(VT) NAVD 88

60% SUBMITTAL


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PROJECT NO:	BY	NO	DATE
DESIGNED:	GF	001	
DRAFTED:	GF	002	6/20/16
CHECKED:			
APPROVED:			
DATE:			
			DESCRIPTION
			DEV. CONCEPT PLAN (30%)
			DEV. SITE PLAN



VIRGINIA RAILWAY EXPRESS
ALEXANDRIA
PEDESTRIAN TUNNEL

DISCIPLINE:	DRAWING NO:
CIVIL EROSION AND SEDIMENT CONTROL DETAILS	C-507
SCALE: NONE	LIST NO:
DATE ISSUED: 6/20/16	


C:\pwworking\gfpw01\smelio\d0593522\DSP-56349 C-507DET.dwg, 6/21/2016 9:28:57 AM, smelio

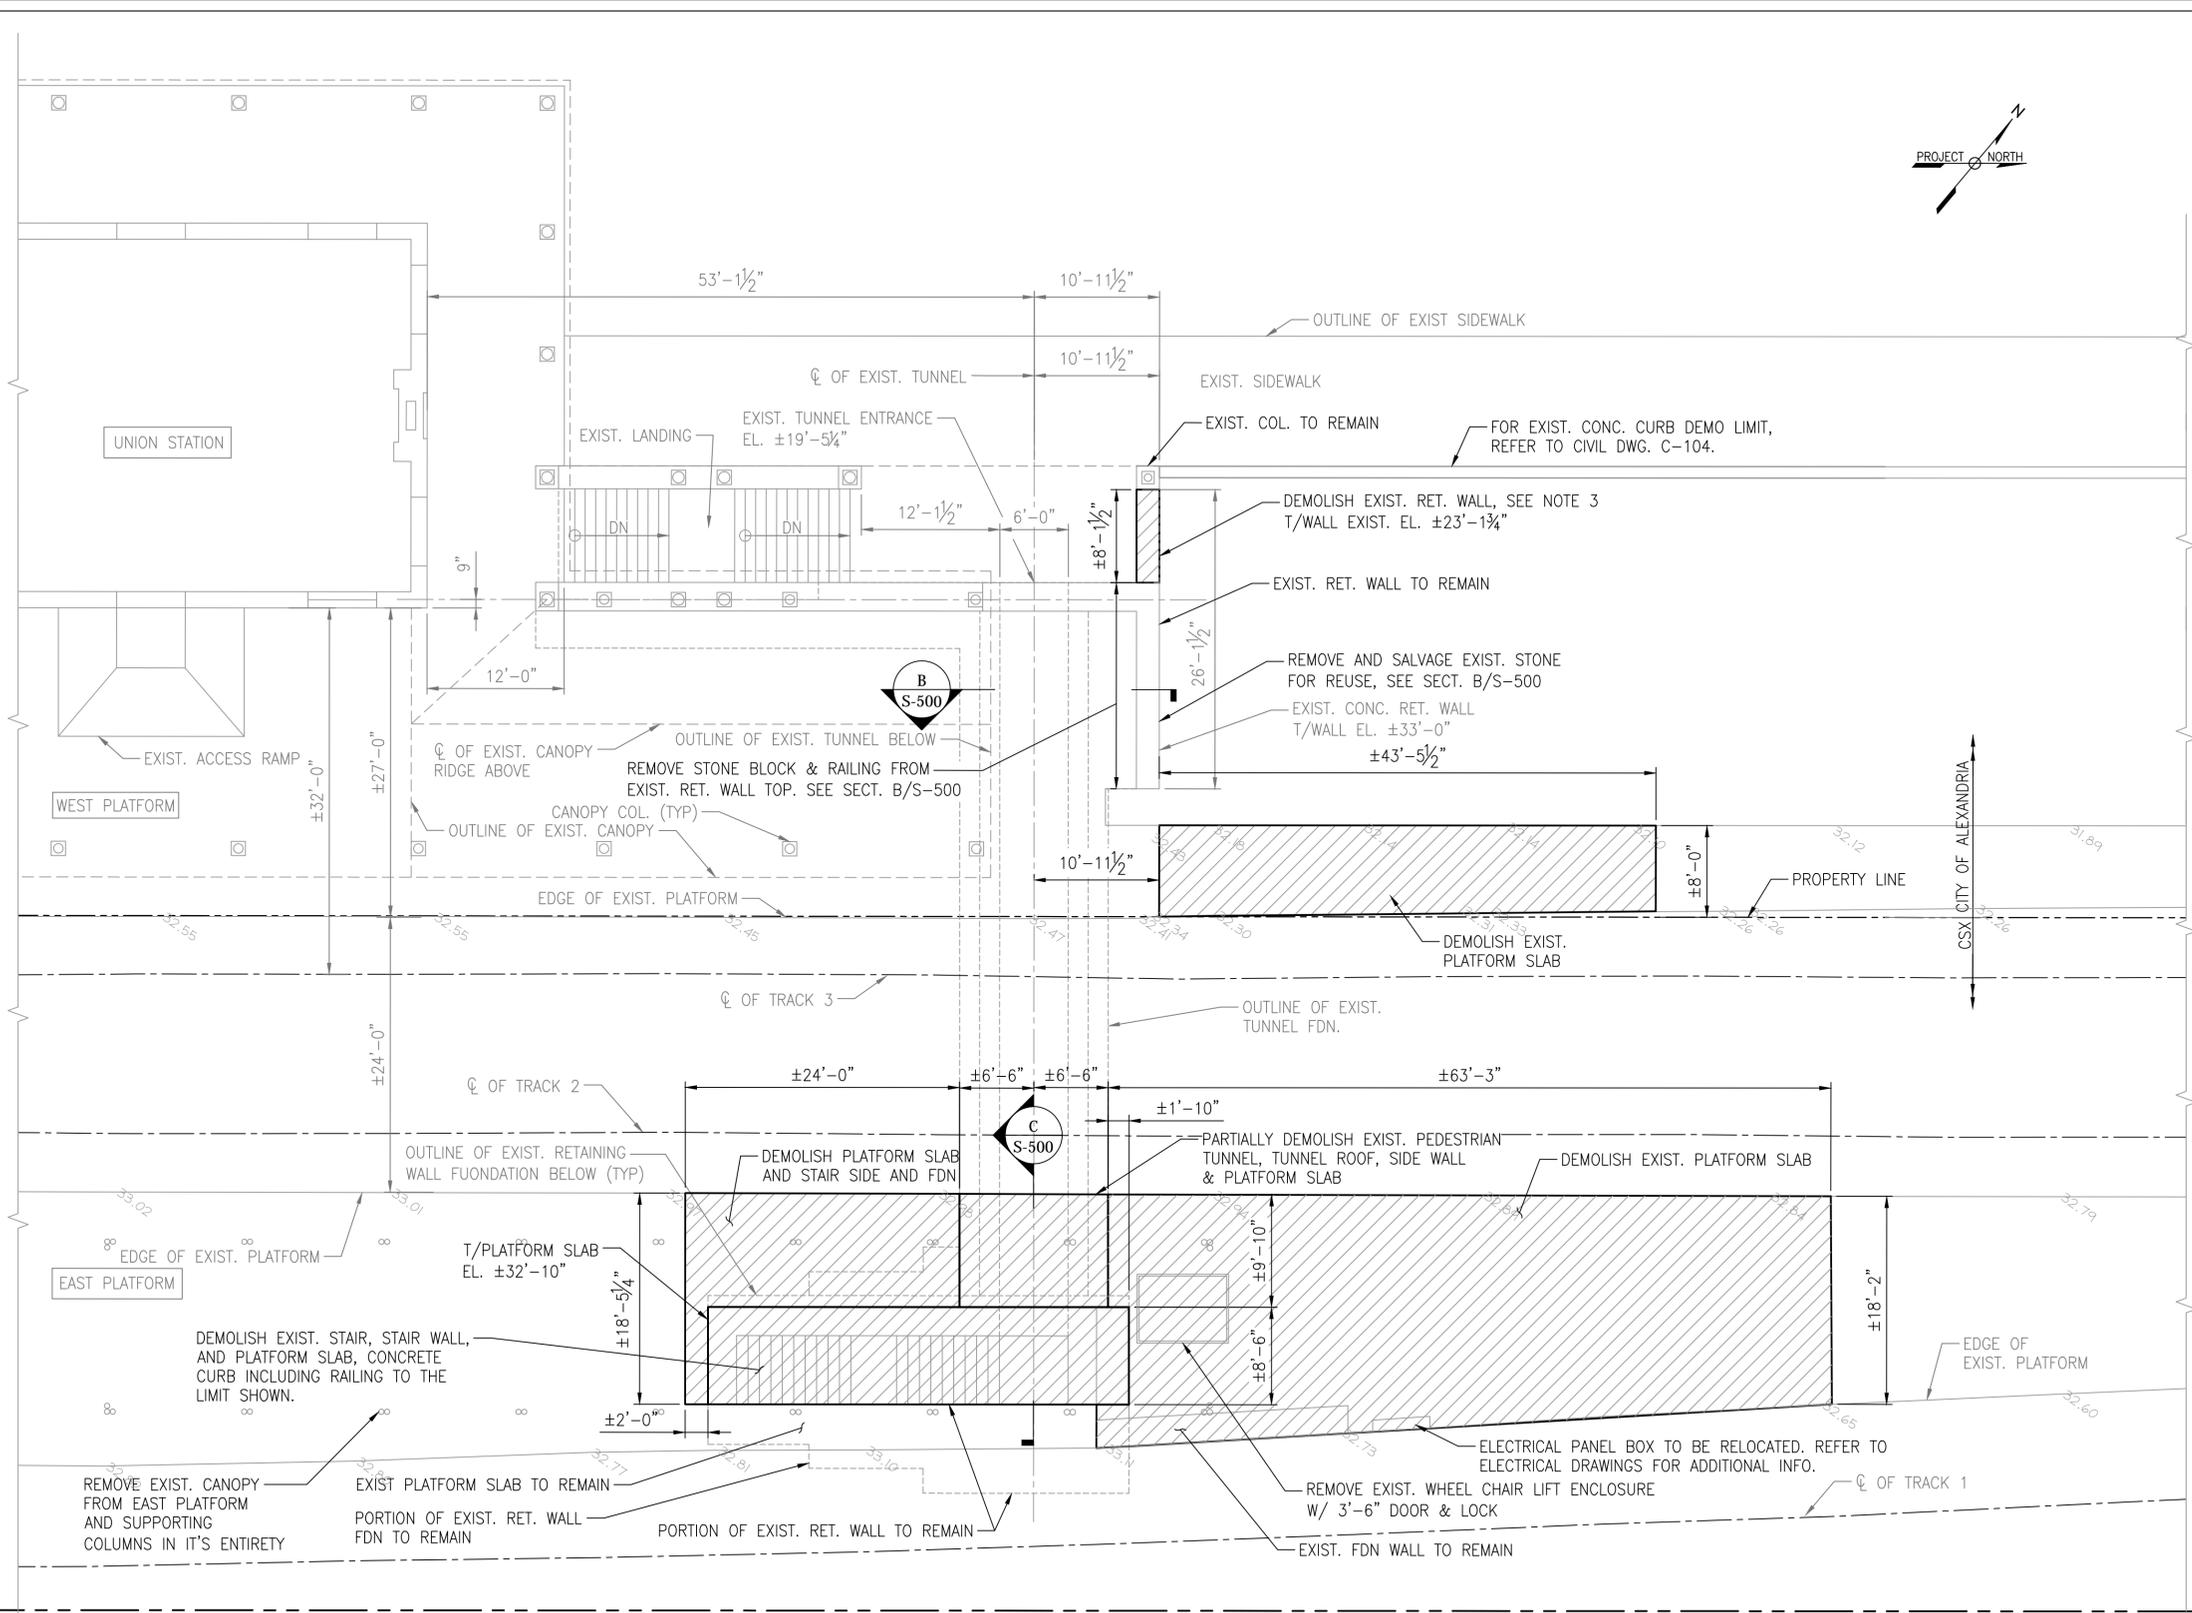

- NOTES:**
- FOR GENERAL NOTES, REFER TO DRAWINGS S-001 TO S-004.
 - THE (\pm) MARKS SHOWN WITH DIMENSION DO NOT INDICATE ANY DEGREE OF PRECISION. THESE DIMENSIONS WILL REQUIRE FIELD VERIFICATION BY THE CONTRACTOR.
 - CAREFULLY DEMOLISH EXISTING RETAINING WALL TO EL. $\pm 18'-9"$. SALVAGE STONE CLADDING, SEE ARCHITECTURAL DRAWING FOR ADDITIONAL INFORMATION.
 - FOR LIGHT POST REMOVAL AND REPLACEMENT, REFER TO ARCHITECTURAL AND ELECTRICAL DRAWINGS.
 - FOR ADDITIONAL INFORMATION RELATED TO DEMOLITION, REFER TO CIVIL AND ARCHITECTURAL DRAWING SERIES.

LEGEND:


DEMO LIMIT

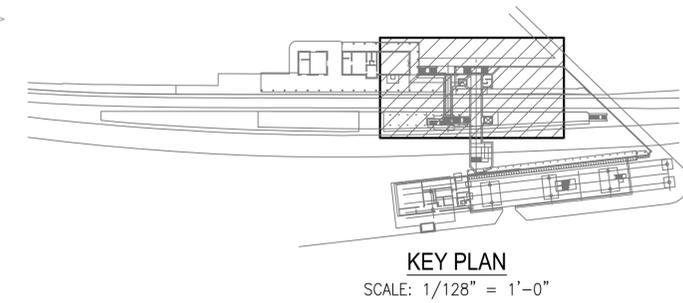

1 S-101 DEMOLITION PART PLAN 1 OF 2
SCALE: 1/8" = 1'-0"

60% SUBMITTAL


CONTRACT NO:	REVISIONS			
PROJECT NO:	BY	NO	DATE	DESCRIPTION
DESIGNED: IA				
DRAFTED: LTN				
CHECKED: MA/DB				
APPROVED:				

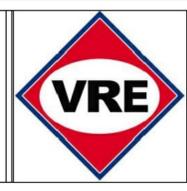

VIRGINIA RAILWAY EXPRESS
**ALEXANDRIA
PEDESTRIAN TUNNEL**

DISCIPLINE:	DRAWING NO:
STRUCTURAL DEMOLITION PART PLAN 1 OF 2	S-101
SCALE: 1/8" = 1'-0"	LIST NO:
DATE ISSUED: 5/25/16	

MATCH LINE - REFER TO S-101

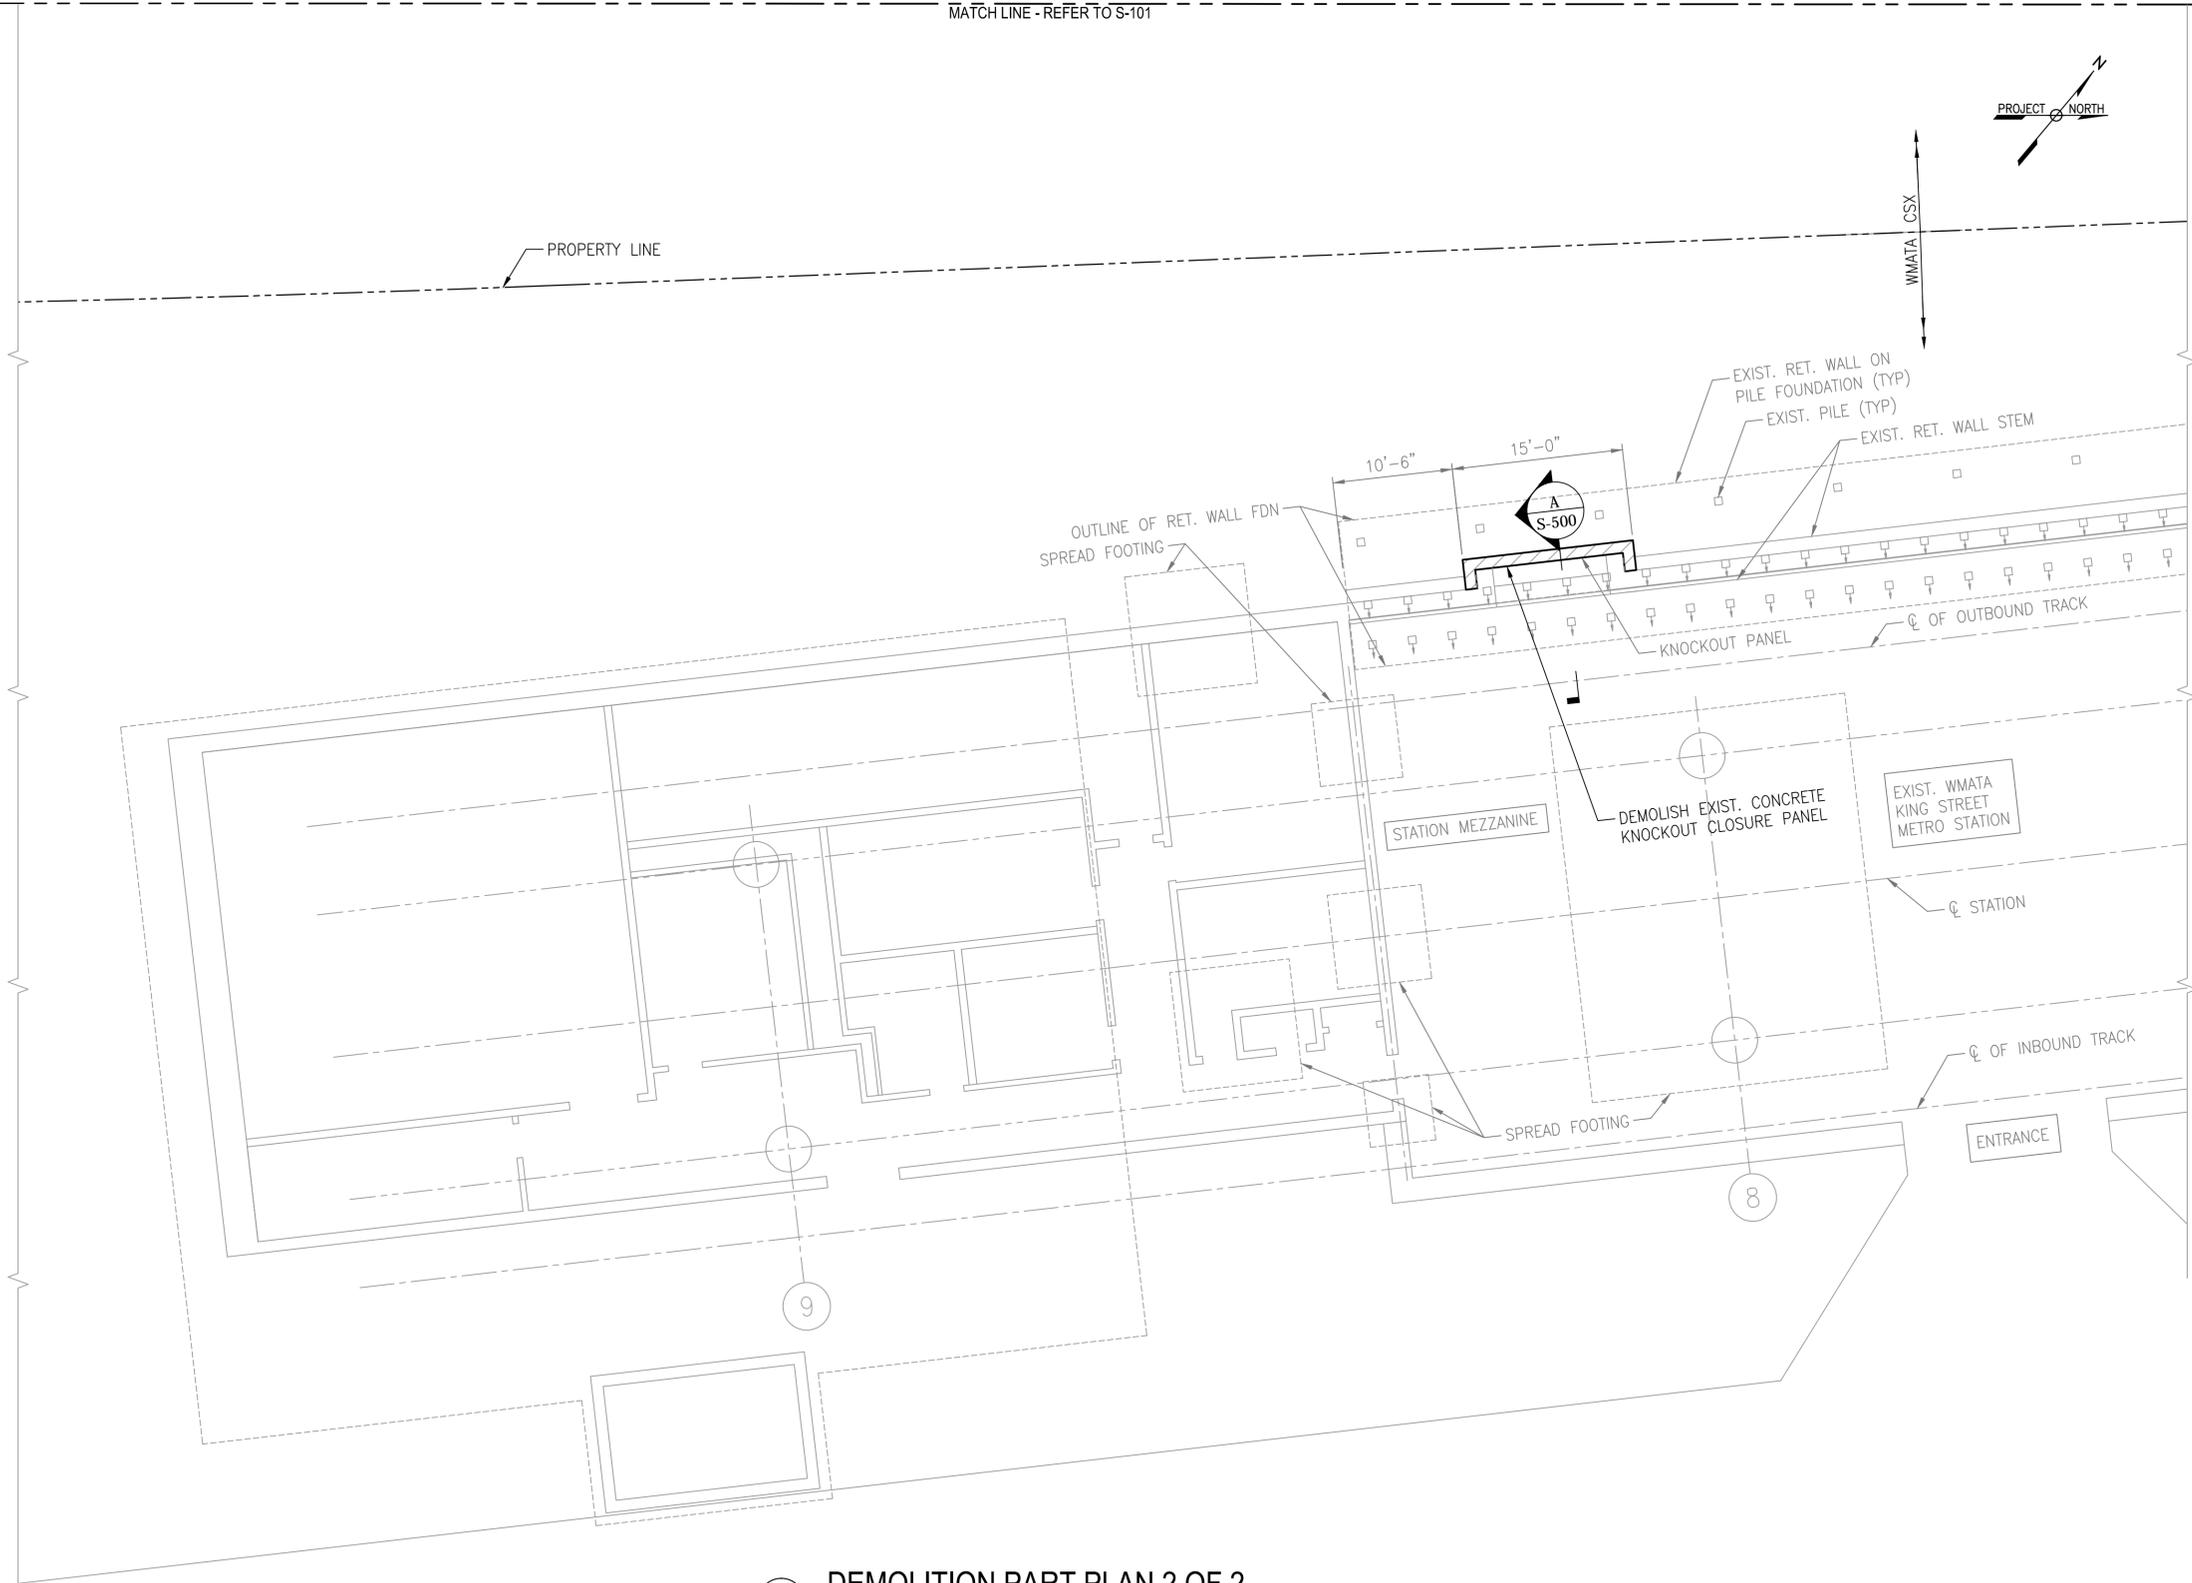


NOTES:

1. FOR GENERAL NOTES, REFER TO DRAWINGS S-001 TO S-004.
2. FOR ADDITIONAL NOTES, SEE DRAWING S-101.

LEGEND:

 DEMO LIMIT

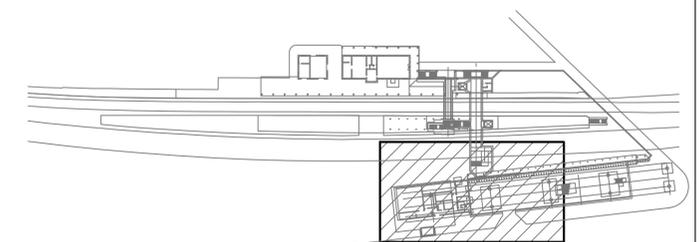

KEY PLAN
SCALE: 1/128" = 1'-0"

1
S-102 **DEMOLITION PART PLAN 2 OF 2**
SCALE: 1/8" = 1'-0"



60% SUBMITTAL

CONTRACT NO:		REVISIONS			
PROJECT NO:		BY	NO	DATE	DESCRIPTION
DESIGNED:	IA				
DRAFTED:	LTN				
CHECKED:	MA/DB				
APPROVED:					



VIRGINIA RAILWAY EXPRESS
ALEXANDRIA
PEDESTRIAN TUNNEL

DISCIPLINE:		DRAWING NO:	
STRUCTURAL		S-102	
DEMOLITION PART PLAN 2 OF 2		LIST NO:	
SCALE:	DATE ISSUED:		
1/8" = 1'-0"	5/25/16		

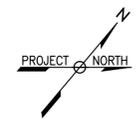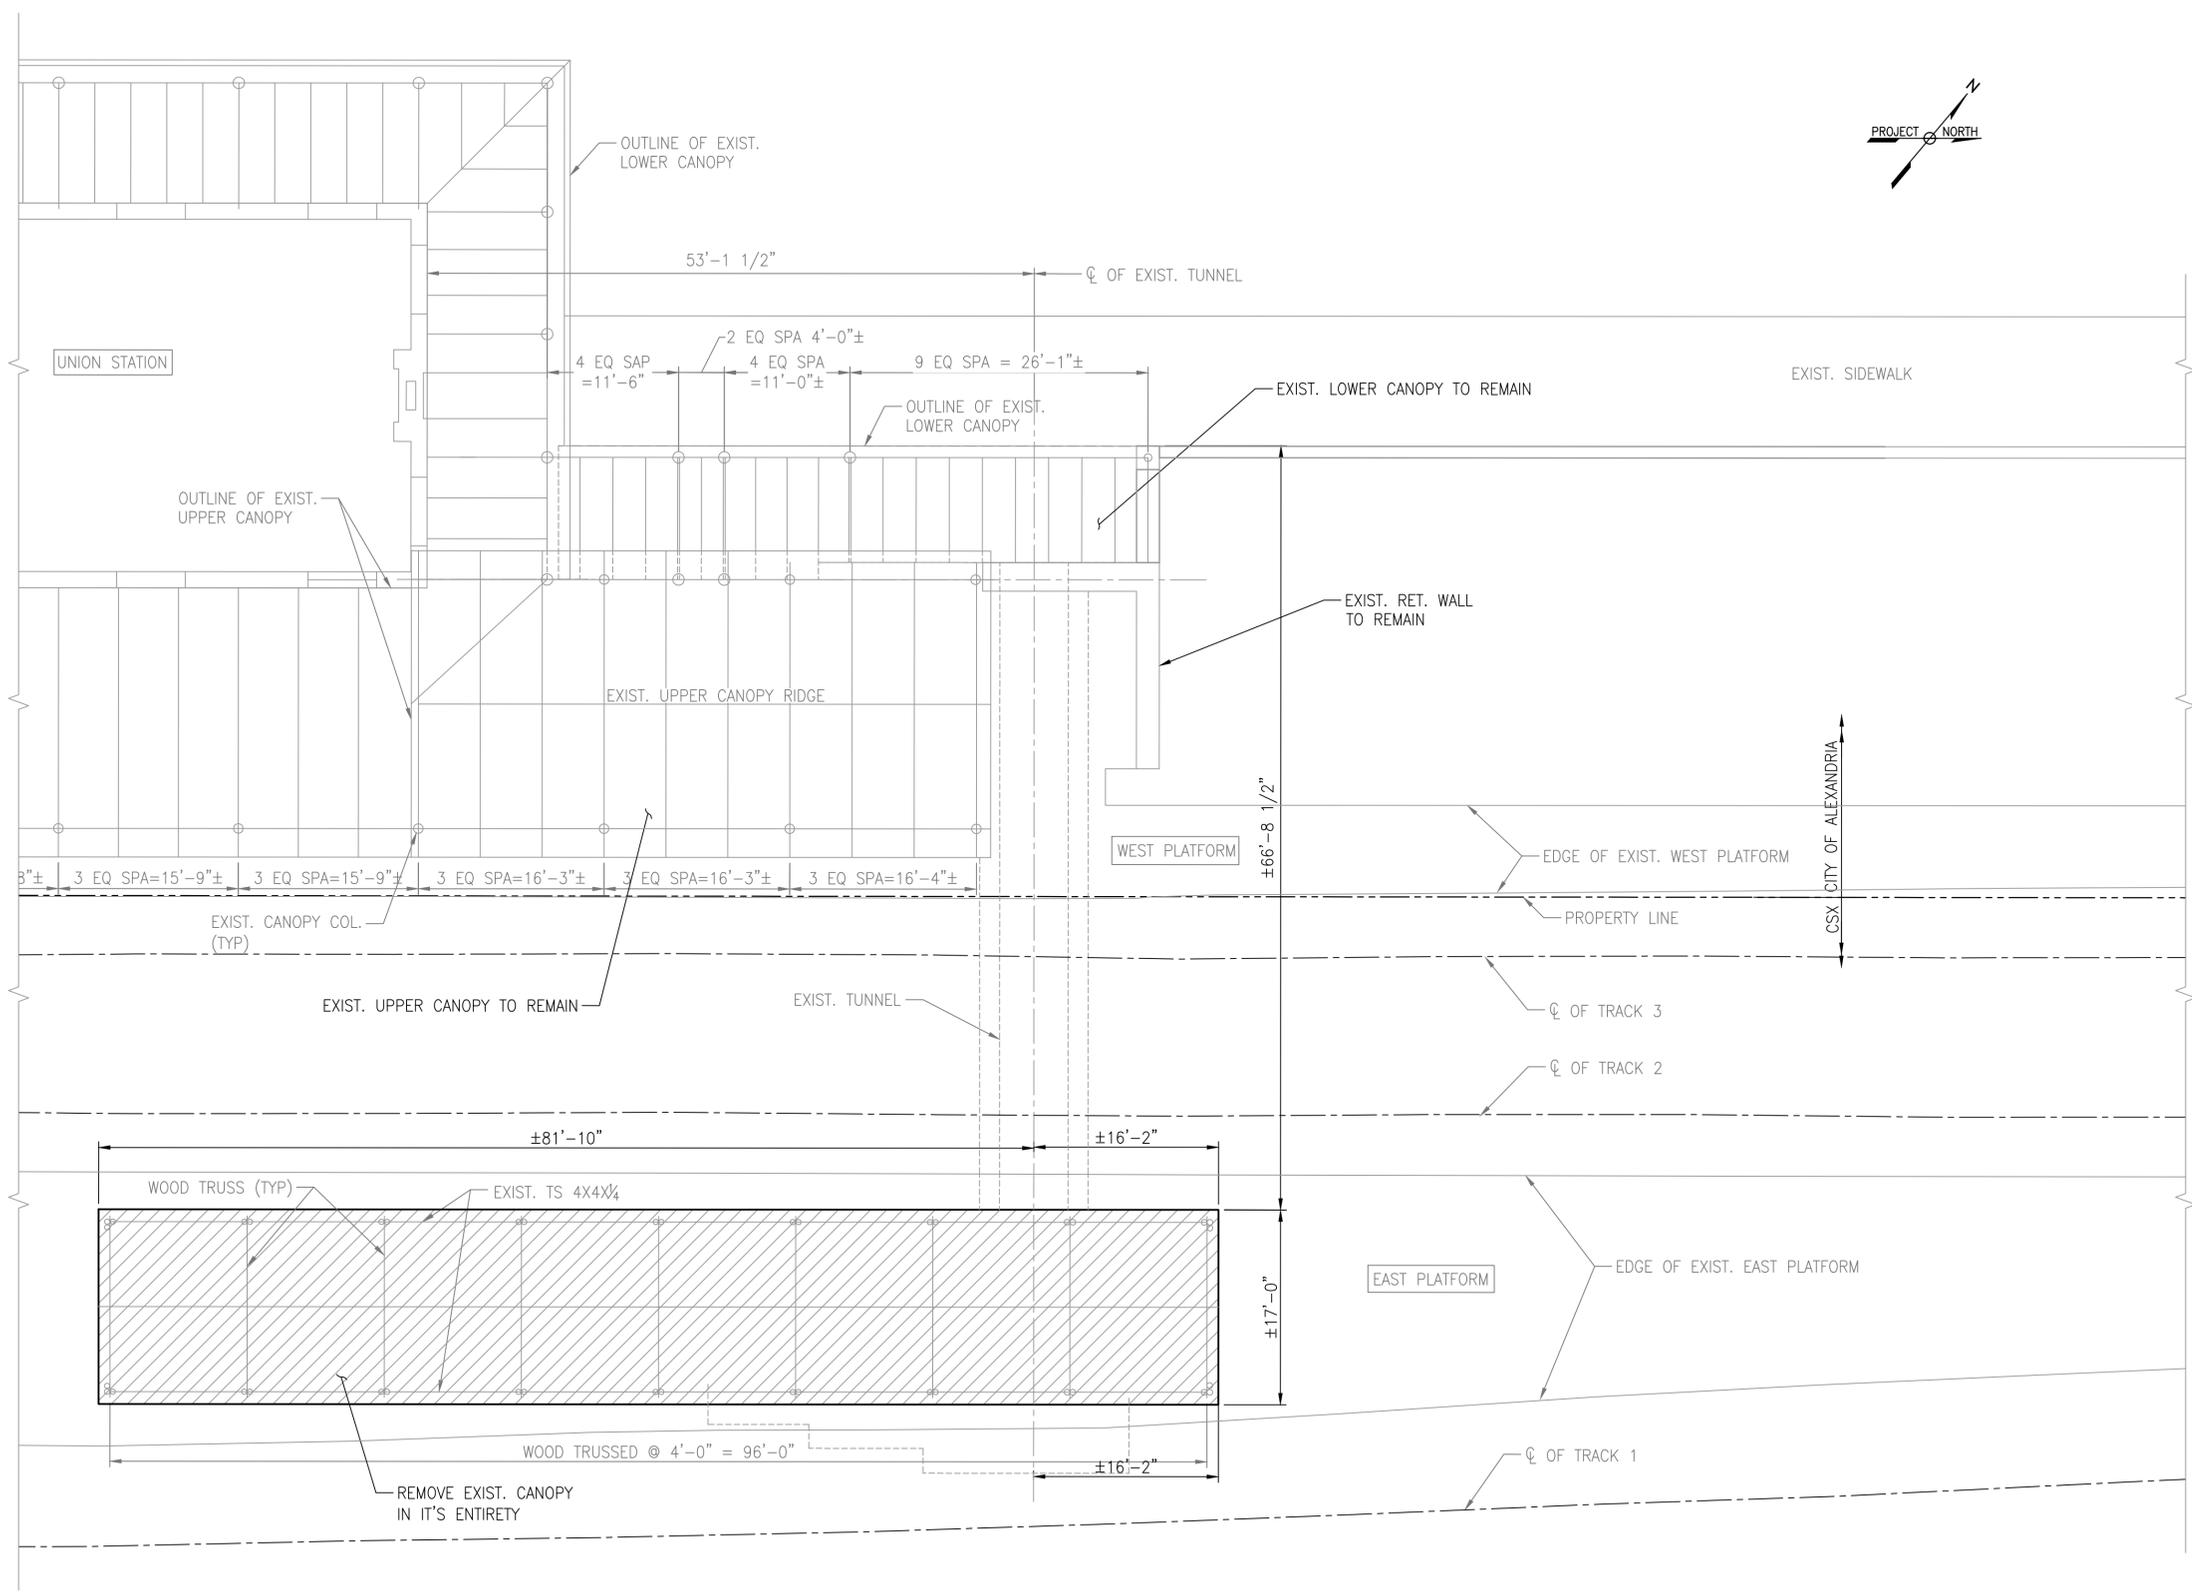


NOTES:

1. FOR GENERAL NOTES, REFER TO DRAWINGS S-001 TO S-004.
2. FOR ADDITIONAL NOTES, SEE DRAWING S-101.

LEGEND:

DEMO LIMIT

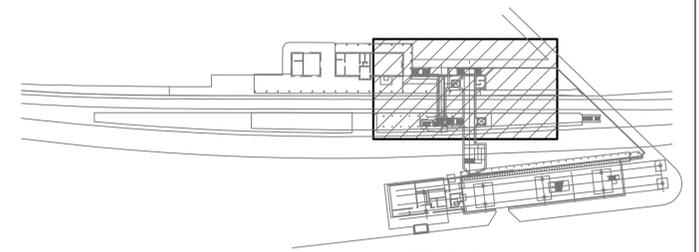

KEY PLAN
SCALE: 1/128" = 1'-0"

1
S-103 CANOPY DEMOLITION PLAN
SCALE: 1/8" = 1'-0"


60% SUBMITTAL

CONTRACT NO:		REVISIONS			
PROJECT NO:		BY	NO	DATE	DESCRIPTION
DESIGNED:	IA				
DRAFTED:	LTN				
CHECKED:	MA/DB				
APPROVED:					



VIRGINIA RAILWAY EXPRESS
**ALEXANDRIA
PEDESTRIAN TUNNEL**

DISCIPLINE:		DRAWING NO:
STRUCTURAL CANOPY DEMOLITION PLAN		S-103
SCALE:	DATE ISSUED:	LIST NO:
1/8" = 1'-0"	5/25/16	

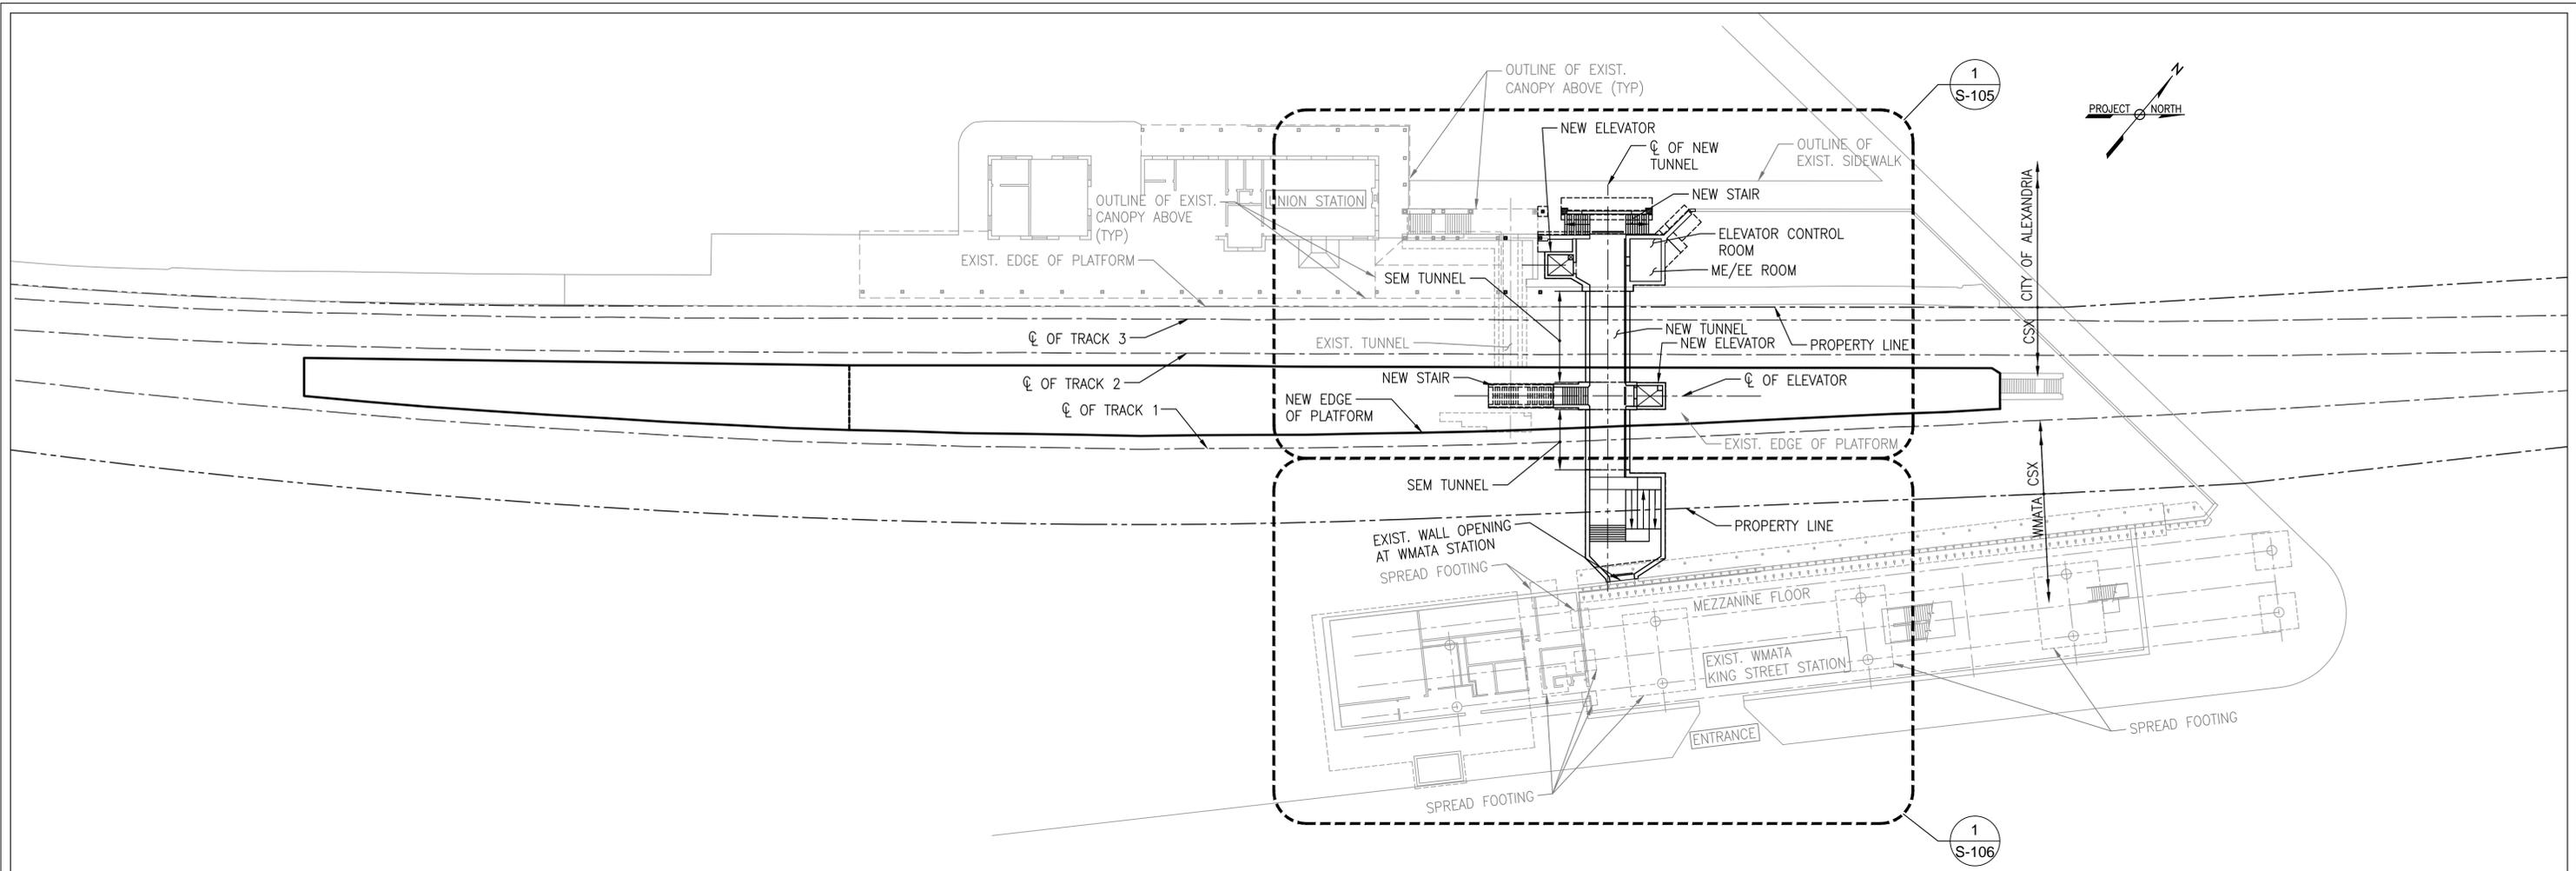

1
S-104

OVERALL STATION PLAN

SCALE: 1/32" = 1'-0"

NOTES:

1. FOR GENERAL NOTES, REFER TO DRAWINGS S-001 TO S-004.
2. FOR ADDITIONAL NOTES, SEE DRAWING S-105.

60% SUBMITTAL


CONTRACT NO:	REVISIONS			
PROJECT NO:	BY	NO	DATE	DESCRIPTION
DESIGNED: IA				
DRAFTED: LTN				
CHECKED: MA/DB				
APPROVED:				



VIRGINIA RAILWAY EXPRESS


ALEXANDRIA
PEDESTRIAN TUNNEL

DISCIPLINE:	DRAWING NO:
STRUCTURAL OVERALL TUNNEL PLAN	S-104
SCALE: 1/32" = 1'-=0"	LIST NO:
DATE ISSUED: 5/25/16	

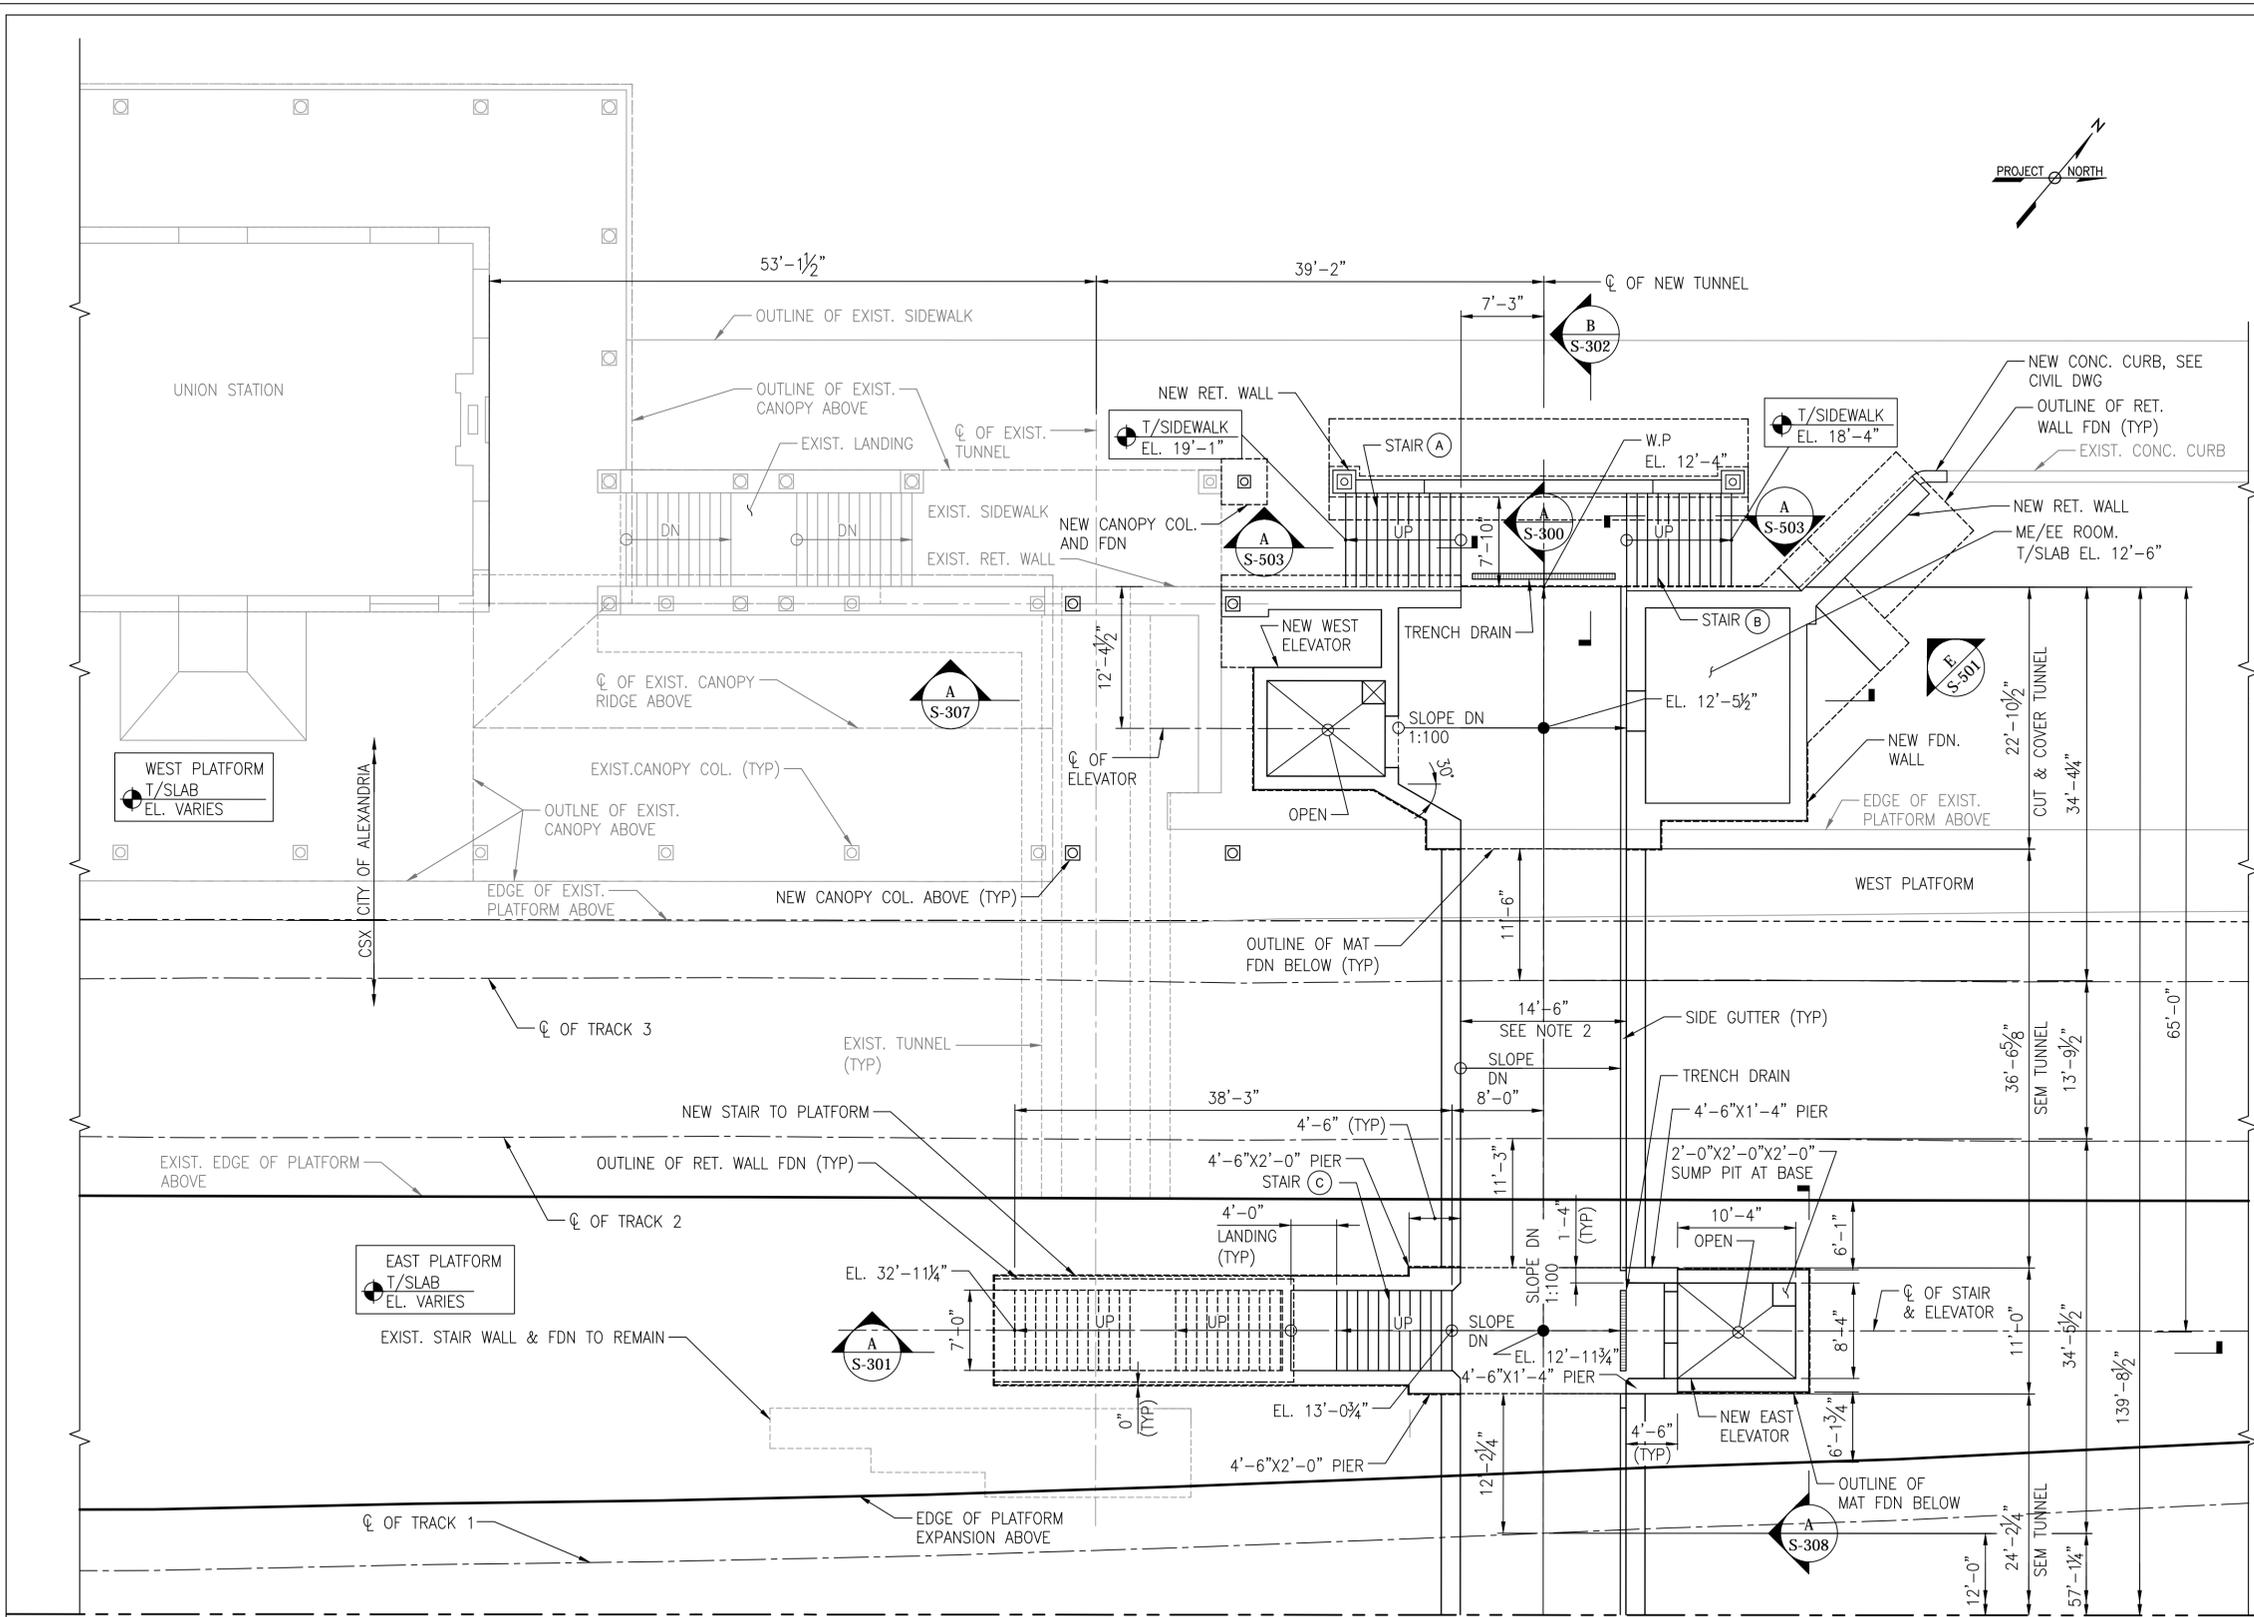

NOTES:

- FOR GENERAL NOTES, REFER TO DRAWINGS S-001 TO S-004.
- PLAN VIEW SHOWN IN THIS SHEET IS AT THE ELEVATION OF SEM TUNNEL SPRING LINE. TUNNEL SPRING LINE IS 3'-1/4" ABOVE TUNNEL INVERT SLAB ALONG THE TUNNEL CENTERLINE FOR SECTION THROUGH SEM TUNNEL AND ELEVATION OF TUNNEL SPRING LINE, REFER TO STRUCTURAL-TUNNEL DRAWING SERIES.
- FOR INFORMATION RELATED TO SEM TUNNEL, REFER TO STRUCTURAL-TUNNEL DRAWING SERIES.
- FOR ENLARGED WEST CUT AND COVER FOUNDATION PLAN, SEE DRAWING S-400.
- STATION POINT ALONG NEW TUNNEL CENTER LINE STA. 113+32.33.
- FOR TUNNEL WATERPROOFING PLANS AND DETAILS, REFER TO DRAWINGS S-780 TO S-786 AND S-300.

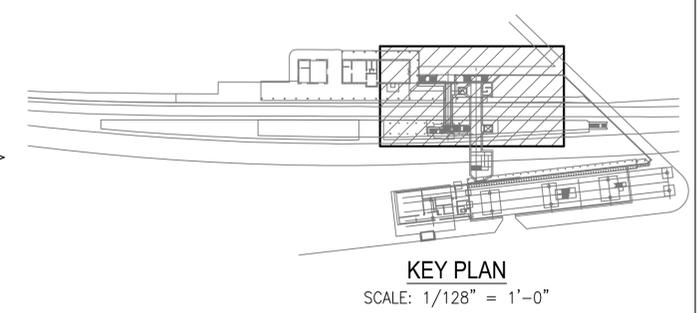

1
S-105 **TUNNEL PART PLAN 1 OF 2**
SCALE: 1/8" = 1'-0"

60% SUBMITTAL



CONTRACT NO:	REVISIONS			
PROJECT NO:	BY	NO	DATE	DESCRIPTION
DESIGNED: IA				
DRAFTED: LTN				
CHECKED: MA/DB				
APPROVED:				



VIRGINIA RAILWAY EXPRESS
**ALEXANDRIA
PEDESTRIAN TUNNEL**


DISCIPLINE:	DRAWING NO:
STRUCTURAL	S-105
TUNNEL PART PLAN 1 OF 2	LIST NO:
SCALE: 1/8" = 1'-0"	DATE ISSUED: 5/25/16

MATCH LINE - REFER TO S-105

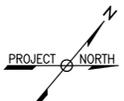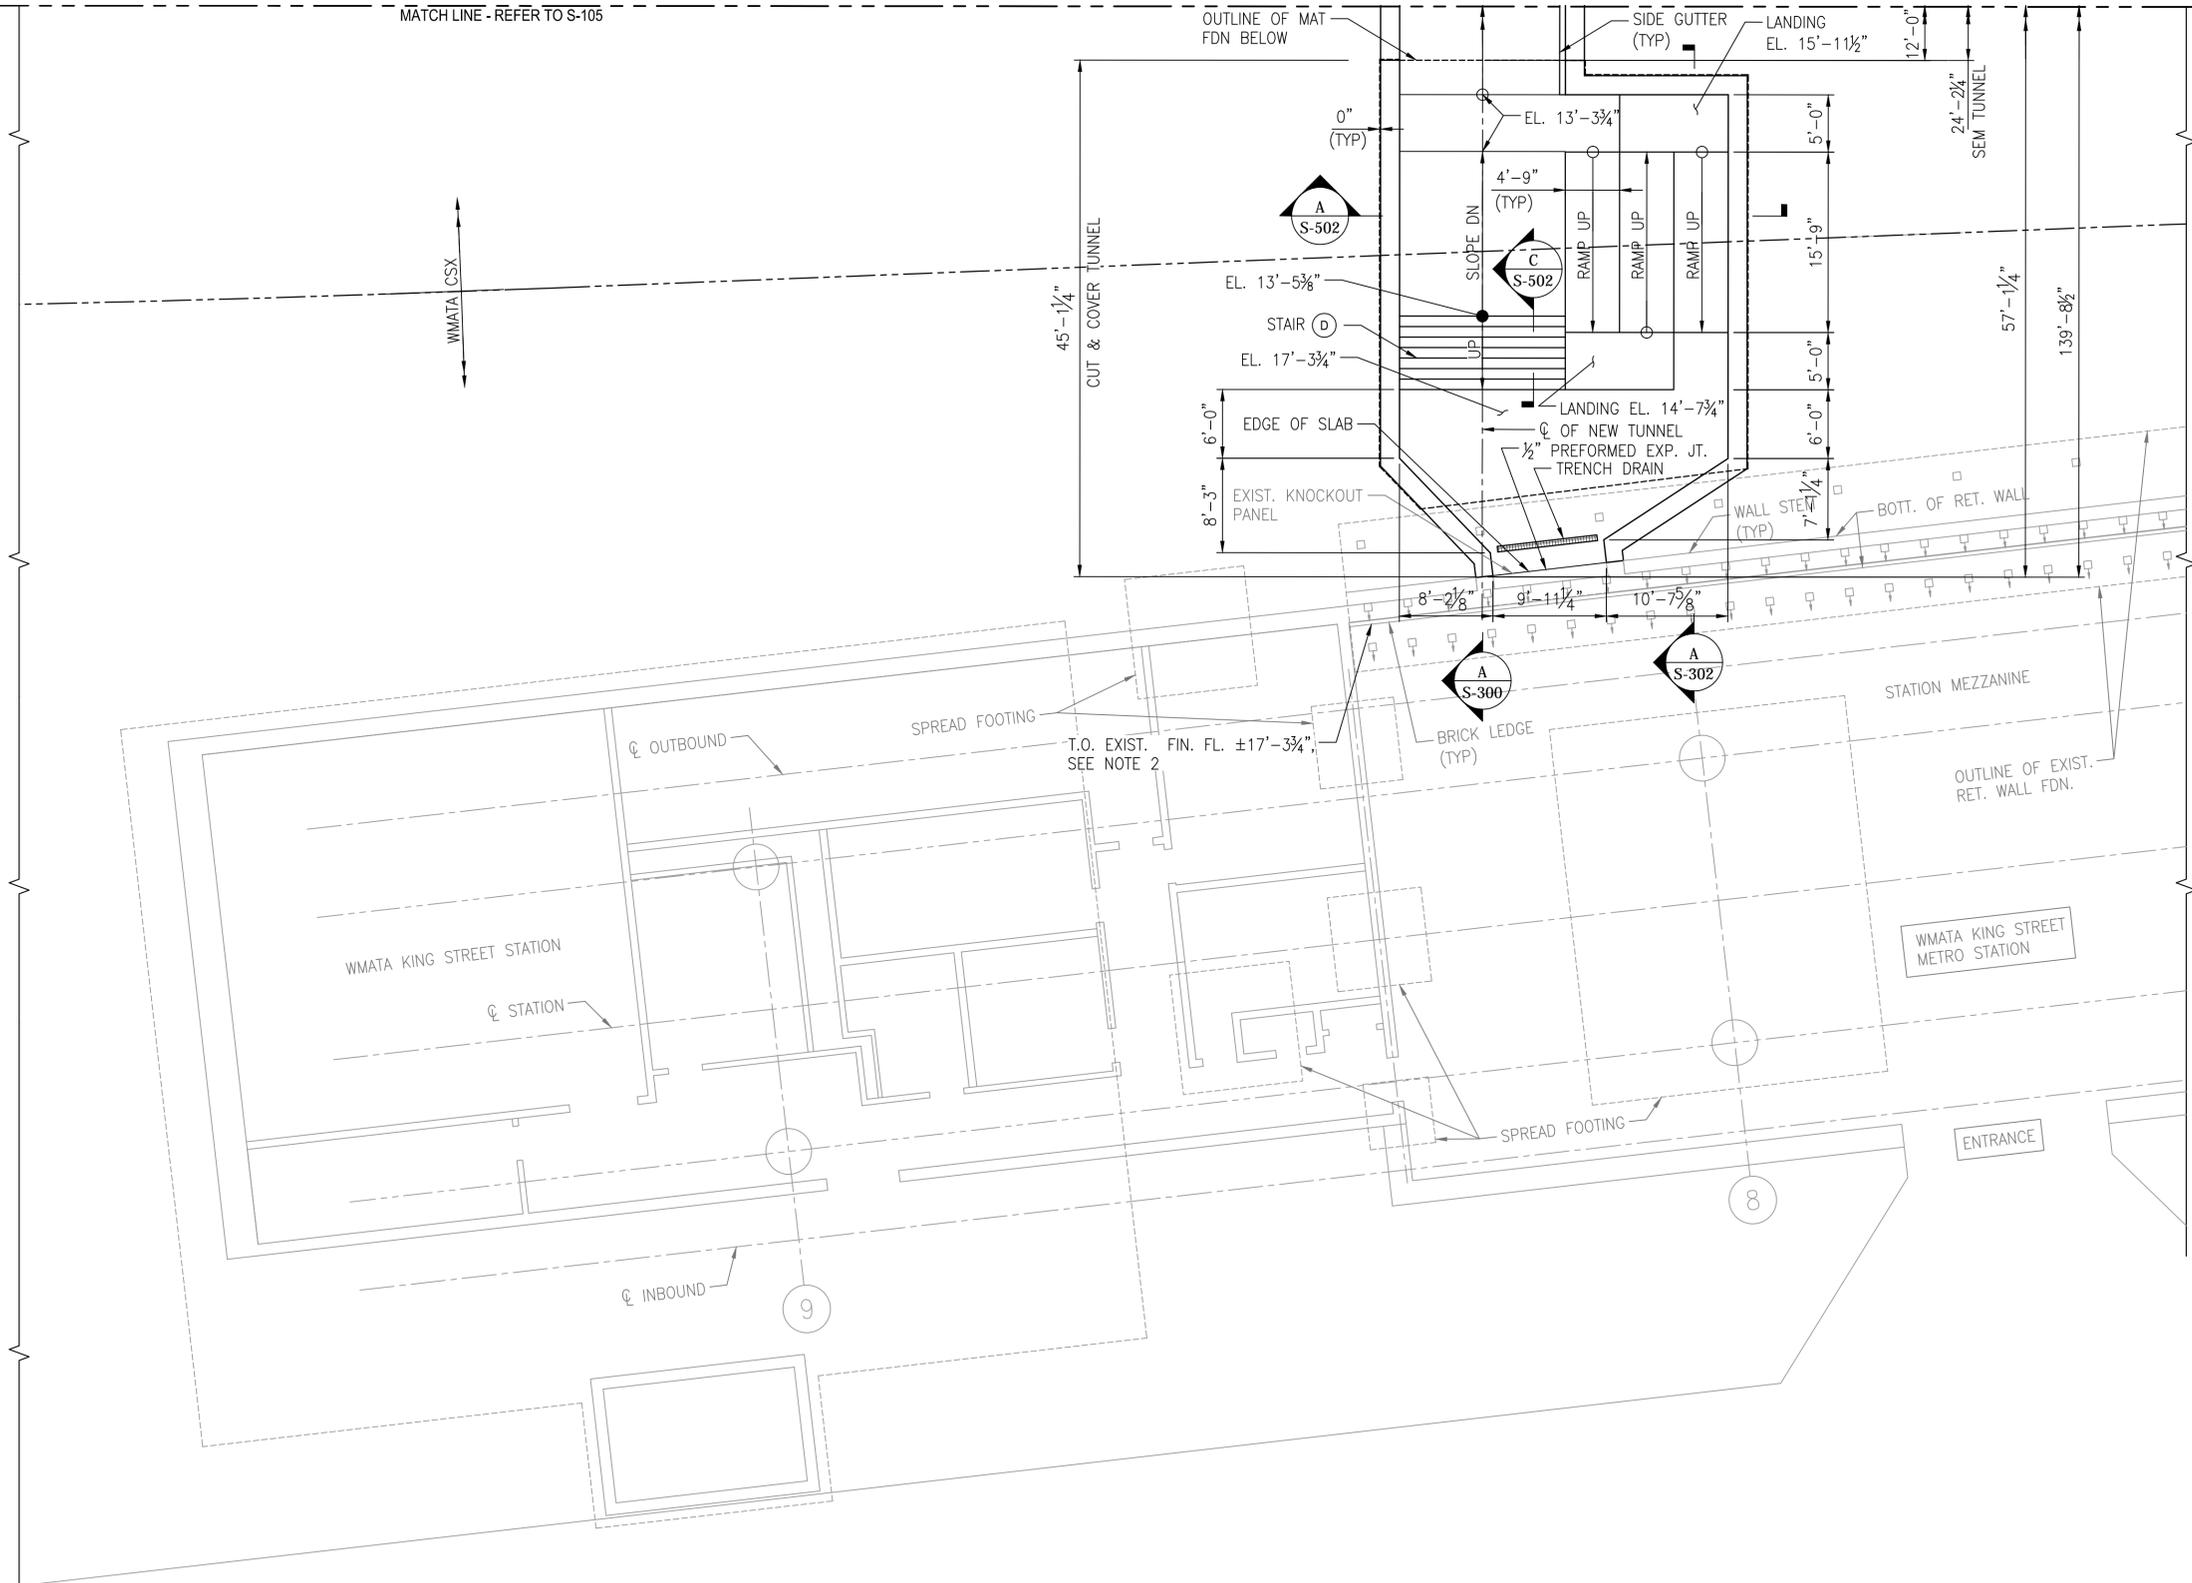

NOTES:

1. FOR GENERAL NOTES, REFER TO DRAWINGS S-001 TO S-004.
2. WMATA MEZZANINE FINISH FLOOR ELEVATION SHOWN IS BASED SURVEY CONDUCTED BY CHRISTOPHER CONSULTANTS. THE VERTICAL REFERENCE DATUM IN SURVEY IS TAKEN AS THE NORTH AMERICAN VERTICAL DATUM OF 1988 (NAVD88).
3. FOR ADDITIONAL NOES, SEE DRAWING S-105.

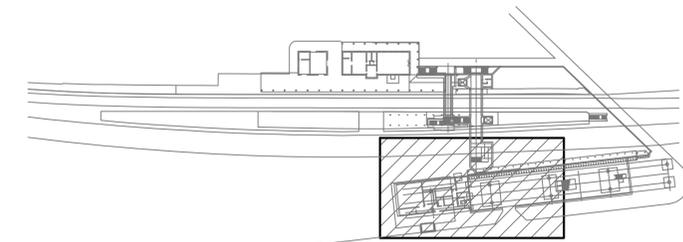

KEY PLAN
SCALE: 1/128" = 1'-0"

1
S-106
TUNNEL PART PLAN 2 OF 2
SCALE: 1/8" = 1'-0"


60% SUBMITTAL

CONTRACT NO:		REVISIONS			
PROJECT NO:		BY	NO	DATE	DESCRIPTION
DESIGNED:	IA				
DRAFTED:	LTN				
CHECKED:	MA/DB				
APPROVED:					



VIRGINIA RAILWAY EXPRESS
**ALEXANDRIA
PEDESTRIAN TUNNEL**

DISCIPLINE:		DRAWING NO:
STRUCTURAL TUNNEL PART PLAN 2 OF 2		S-106
SCALE:	DATE ISSUED:	LIST NO:
1/8" = 1'-0"	5/25/16	

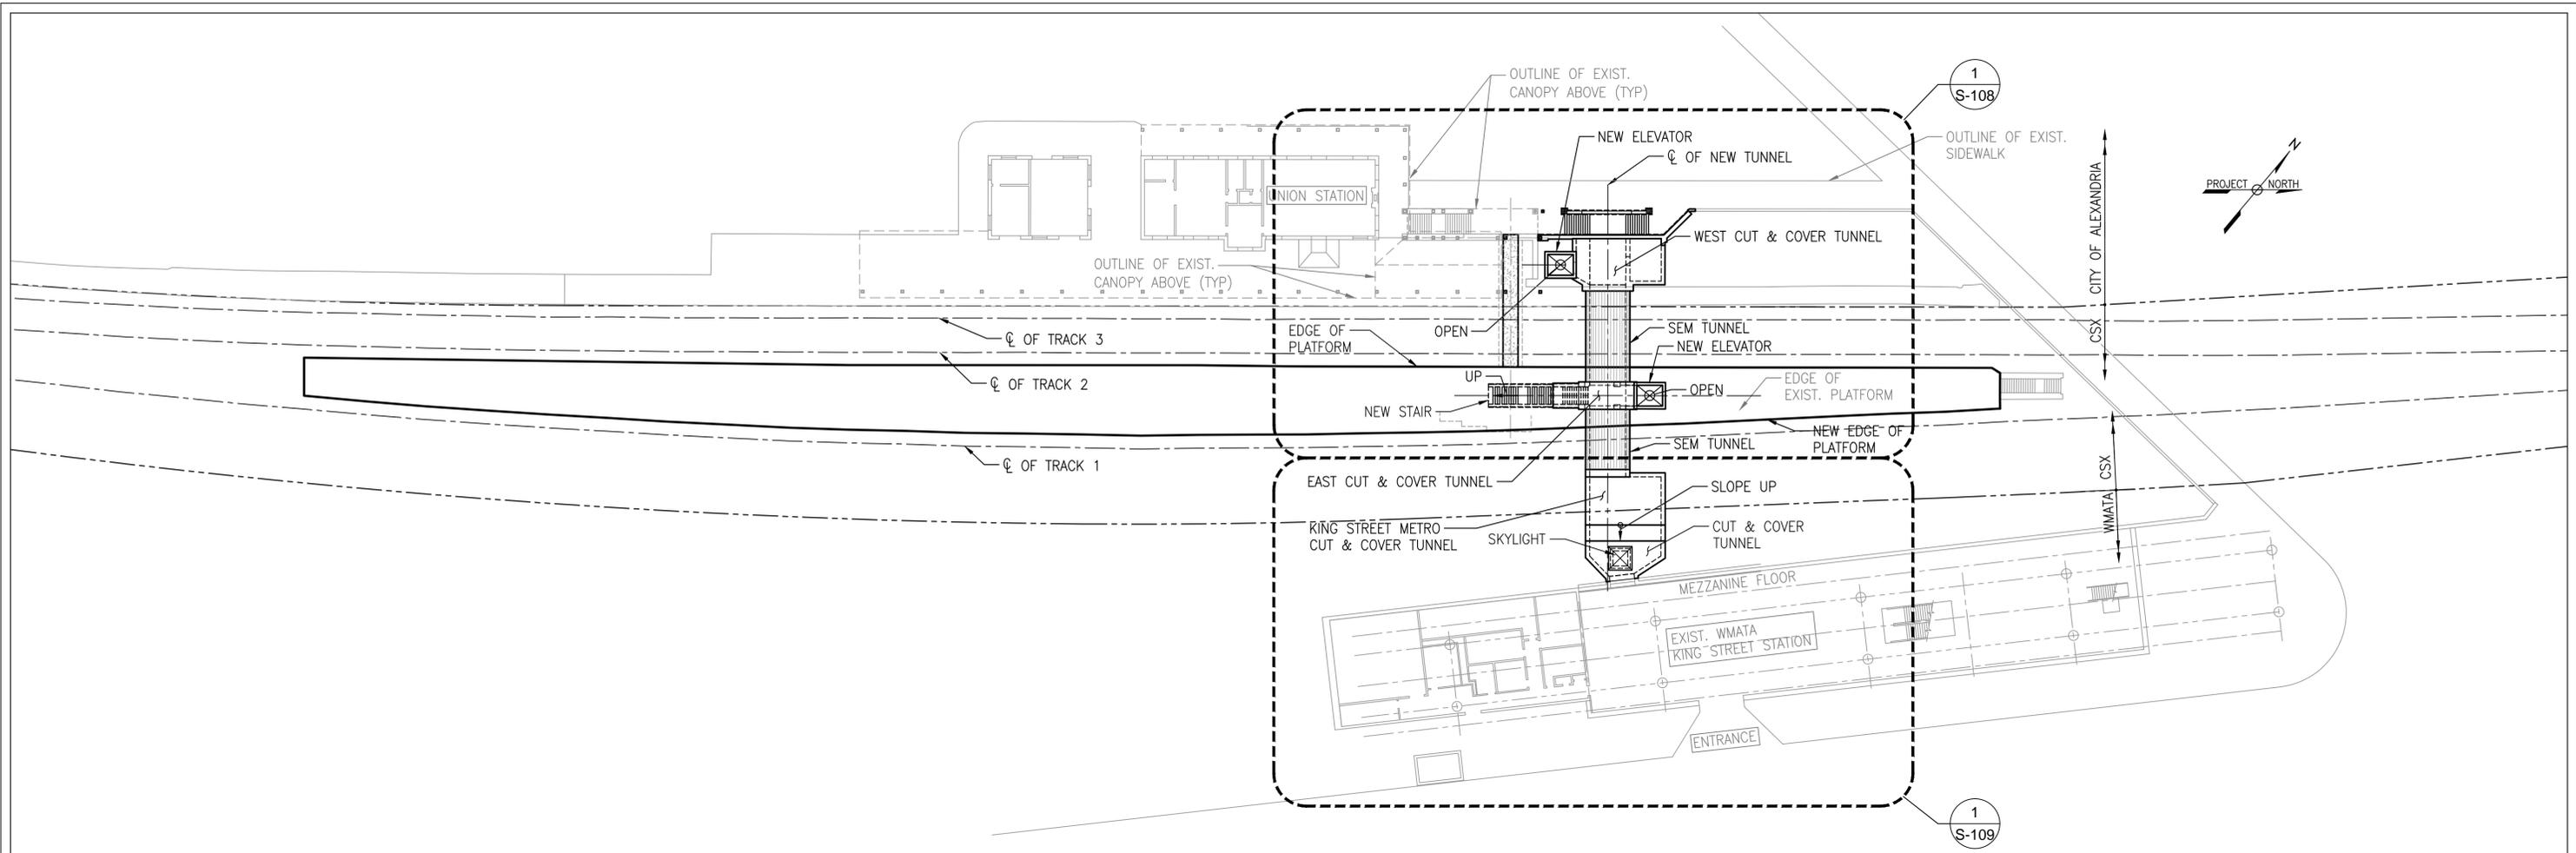

1 OVERALL TUNNEL ROOF PLAN
 S-107 SCALE: 1/32" = 1'-0"

- NOTES:
- FOR GENERAL NOTES, REFER TO DRAWINGS S-001 TO S-004.
 - FOR ADDITIONAL NOTES, SEE DRAWING S-108.


60% SUBMITTAL

CONTRACT NO:		REVISIONS			
PROJECT NO:		BY	NO	DATE	DESCRIPTION
DESIGNED:	IA				
DRAFTED:	LTN				
CHECKED:	MA/DB				
APPROVED:					




VIRGINIA RAILWAY EXPRESS
 ALEXANDRIA
 PEDESTRIAN TUNNEL

DISCIPLINE:		DRAWING NO:
STRUCTURAL OVERALL TUNNEL ROOF PLAN		S-107
SCALE:	DATE ISSUED:	LIST NO:
1/32" = 1'-0"	5/25/16	

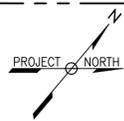


MATCHLINE - REFER TO S-108

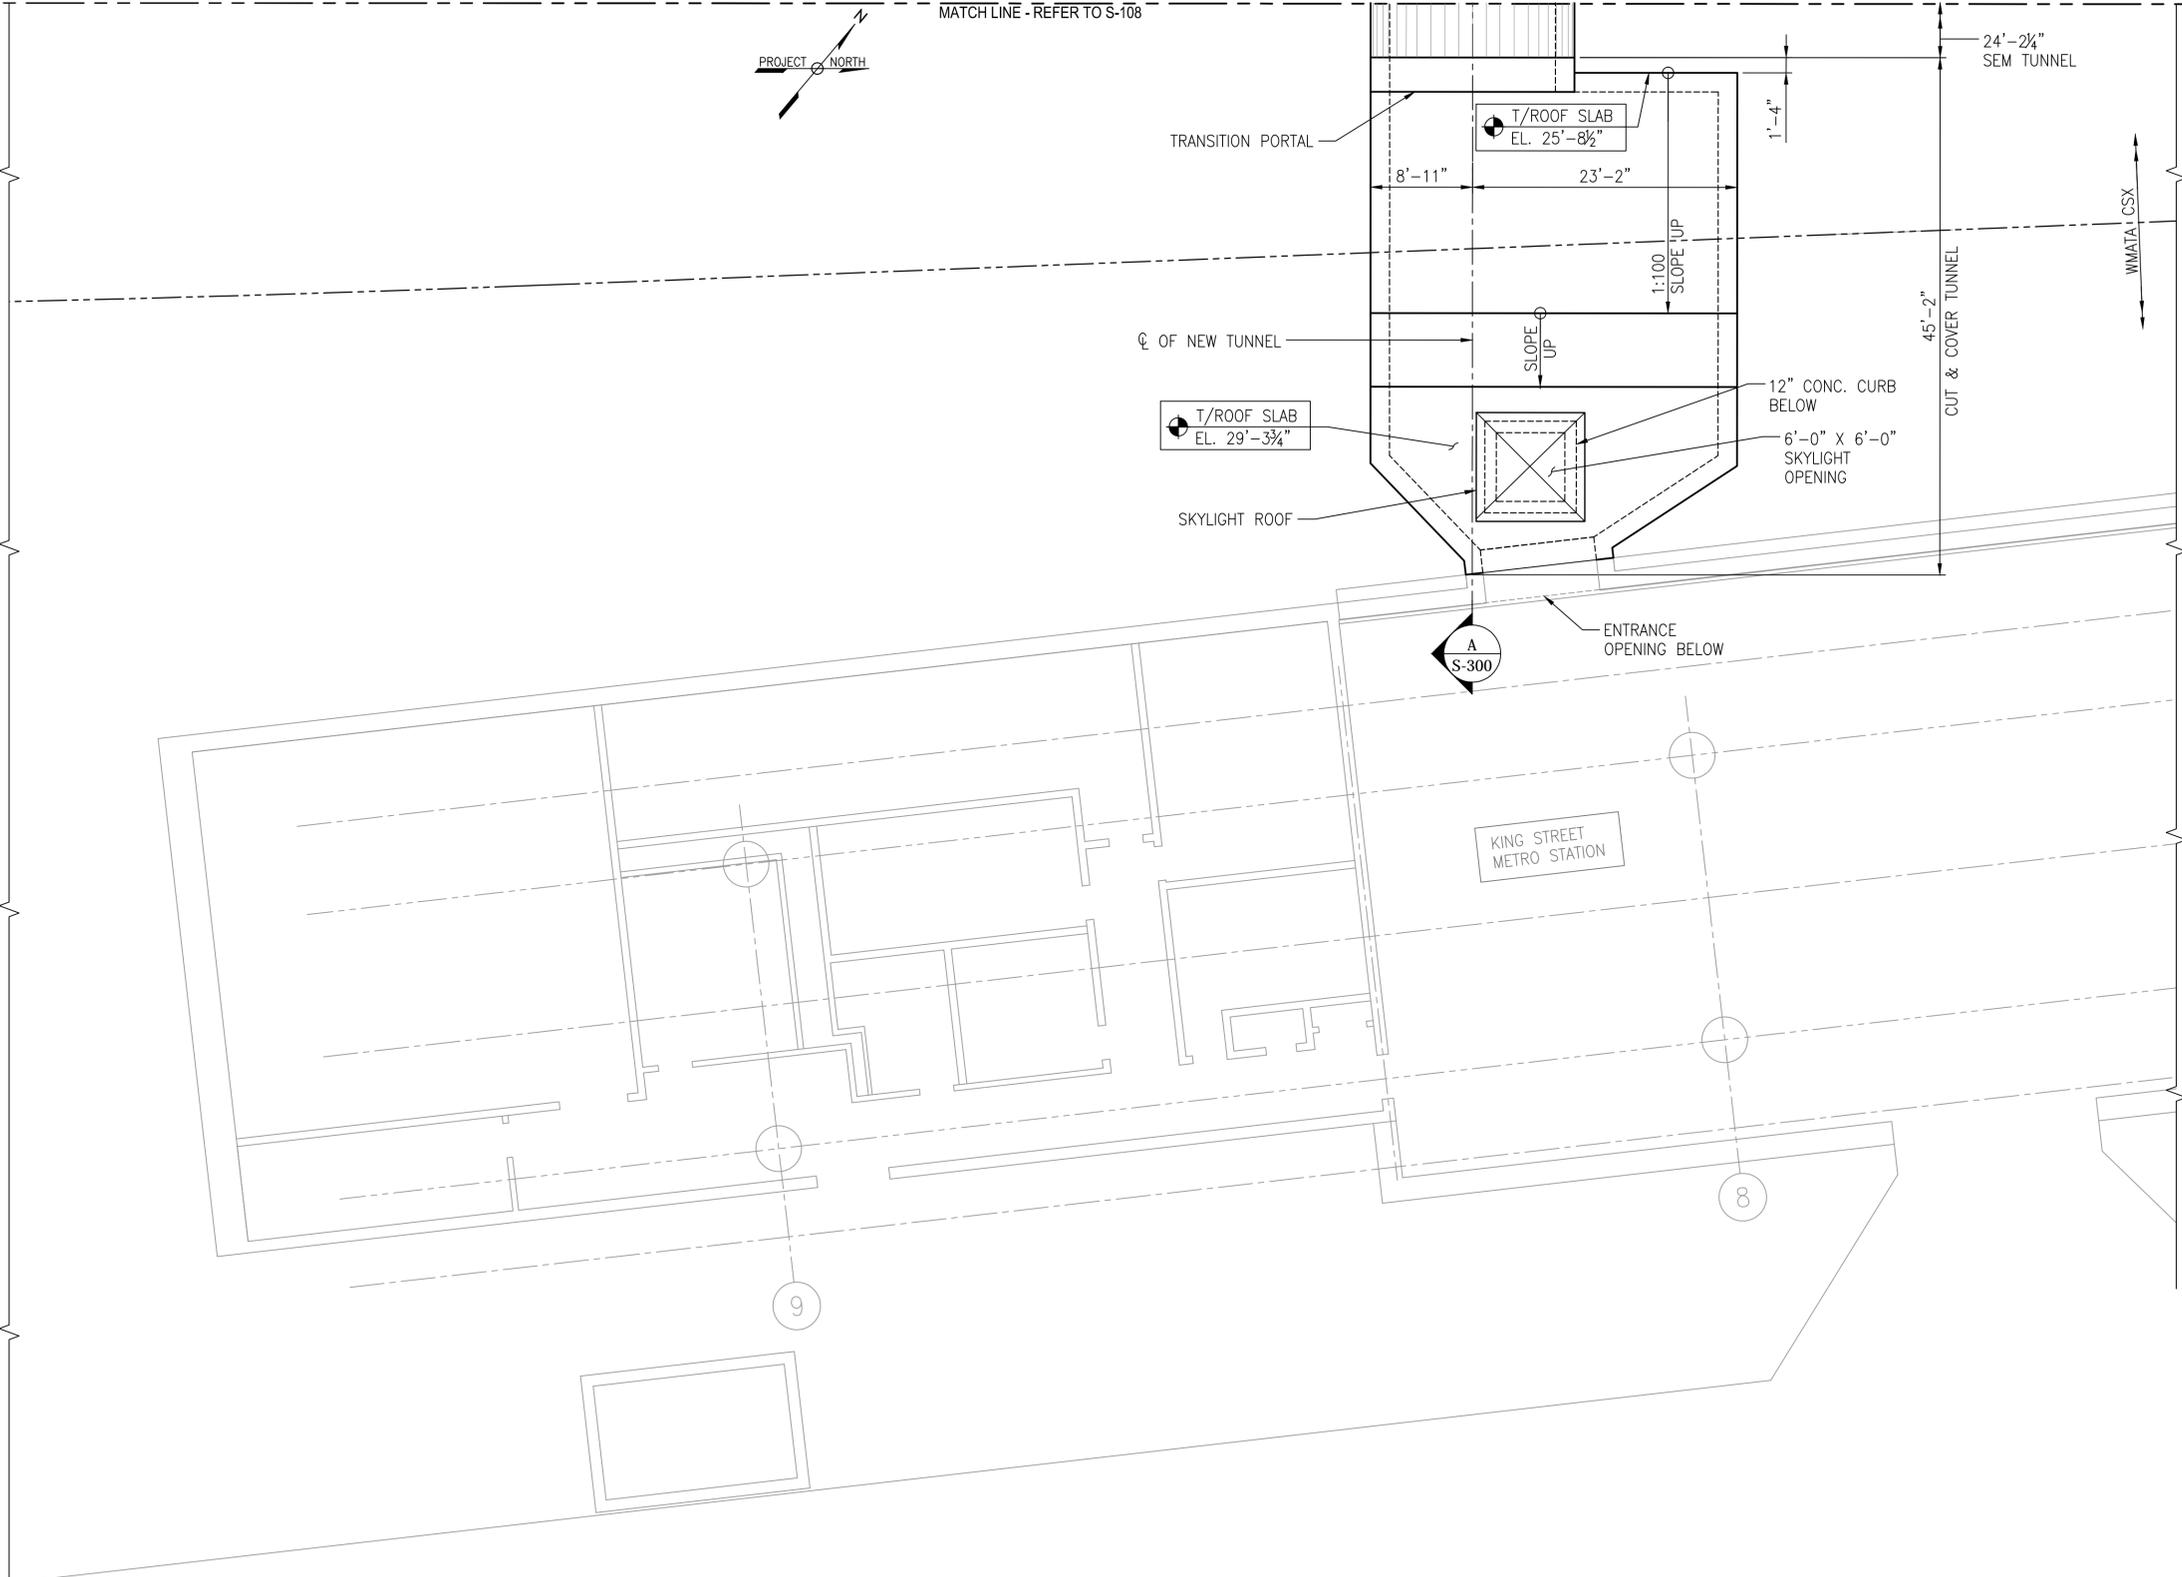

NOTES:

1. FOR GENERAL NOTES, REFER TO DRAWINGS S-001 TO S-004.
2. FOR ADDITIONAL NOTES, SEE DRAWING S-108.

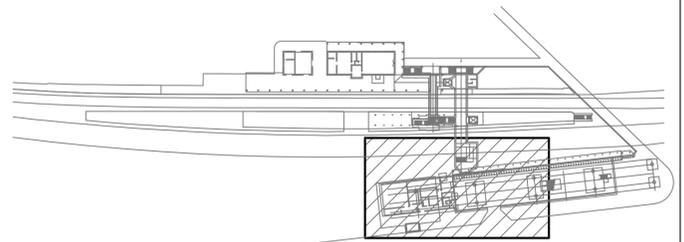

KEY PLAN
SCALE: 1/128" = 1'-0"

1 TUNNEL ROOF PART PLAN 2 OF 2
SCALE: 1/8" = 1'-0"


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CONTRACT NO:		REVISIONS			
PROJECT NO:		BY	NO	DATE	DESCRIPTION
DESIGNED:	IA				
DRAFTED:	LTN				
CHECKED:	MA/DB				
APPROVED:					



VIRGINIA RAILWAY EXPRESS
**ALEXANDRIA
PEDESTRIAN TUNNEL**

DISCIPLINE:		DRAWING NO:
STRUCTURAL		S-109
TUNNEL ROOF PART PLAN 2 OF 2		LIST NO:
SCALE:	DATE ISSUED:	
1/8" = 1'-0"	5/25/16	

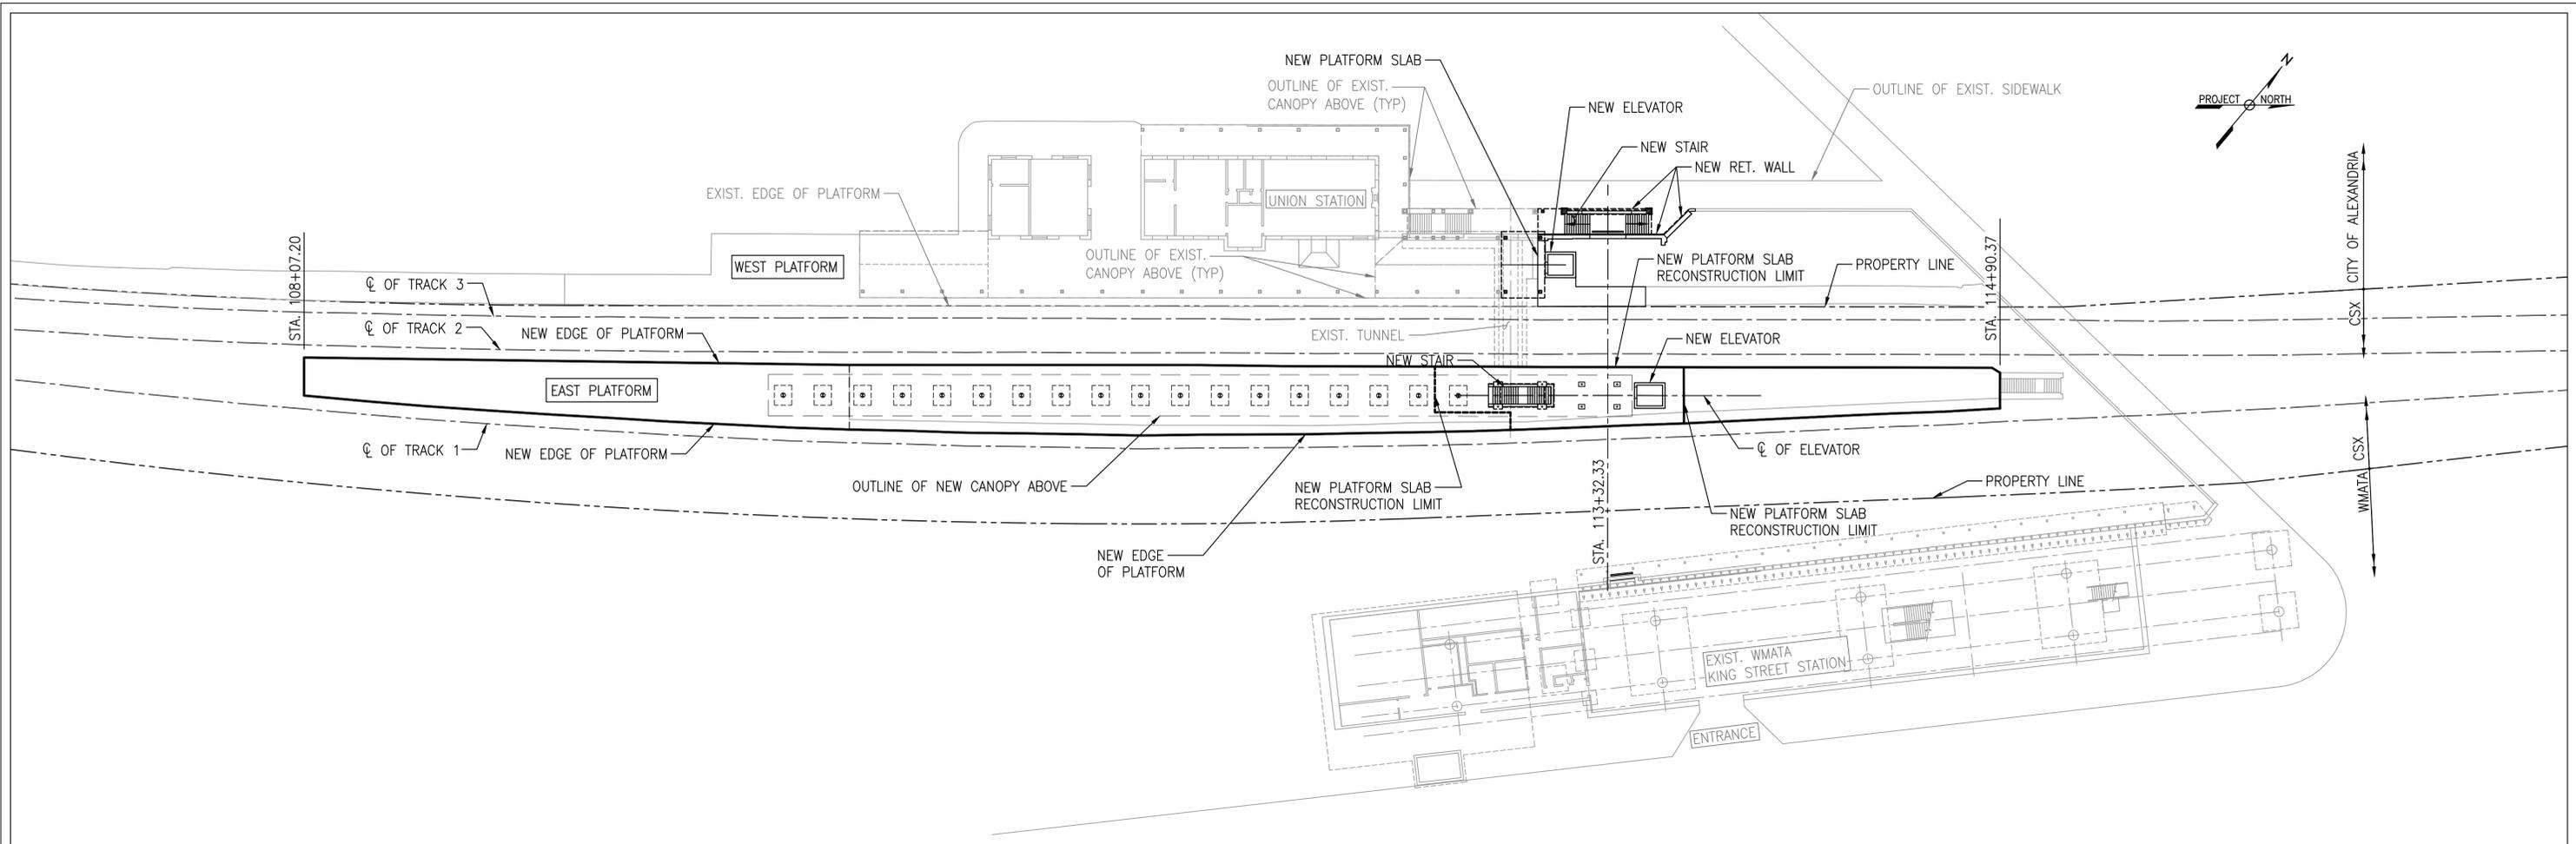

1 OVERALL PLATFORM PLAN
SCALE: 1/32" = 1'-0"

NOTES:

- FOR GENERAL NOTES, REFER TO DRAWINGS S-001 TO S-004.




60% SUBMITTAL

CONTRACT NO:		REVISIONS			
PROJECT NO:		BY	NO	DATE	DESCRIPTION
DESIGNED:	IA				
DRAFTED:	LTN				
CHECKED:	MA/DB				
APPROVED:					



VIRGINIA RAILWAY EXPRESS
ALEXANDRIA
PEDESTRIAN TUNNEL

DISCIPLINE:		DRAWING NO:
STRUCTURAL OVERALL PLATFORM PLAN		S-110
SCALE:	DATE ISSUED:	LIST NO:
1/32" = 1'-0"	5/25/16	

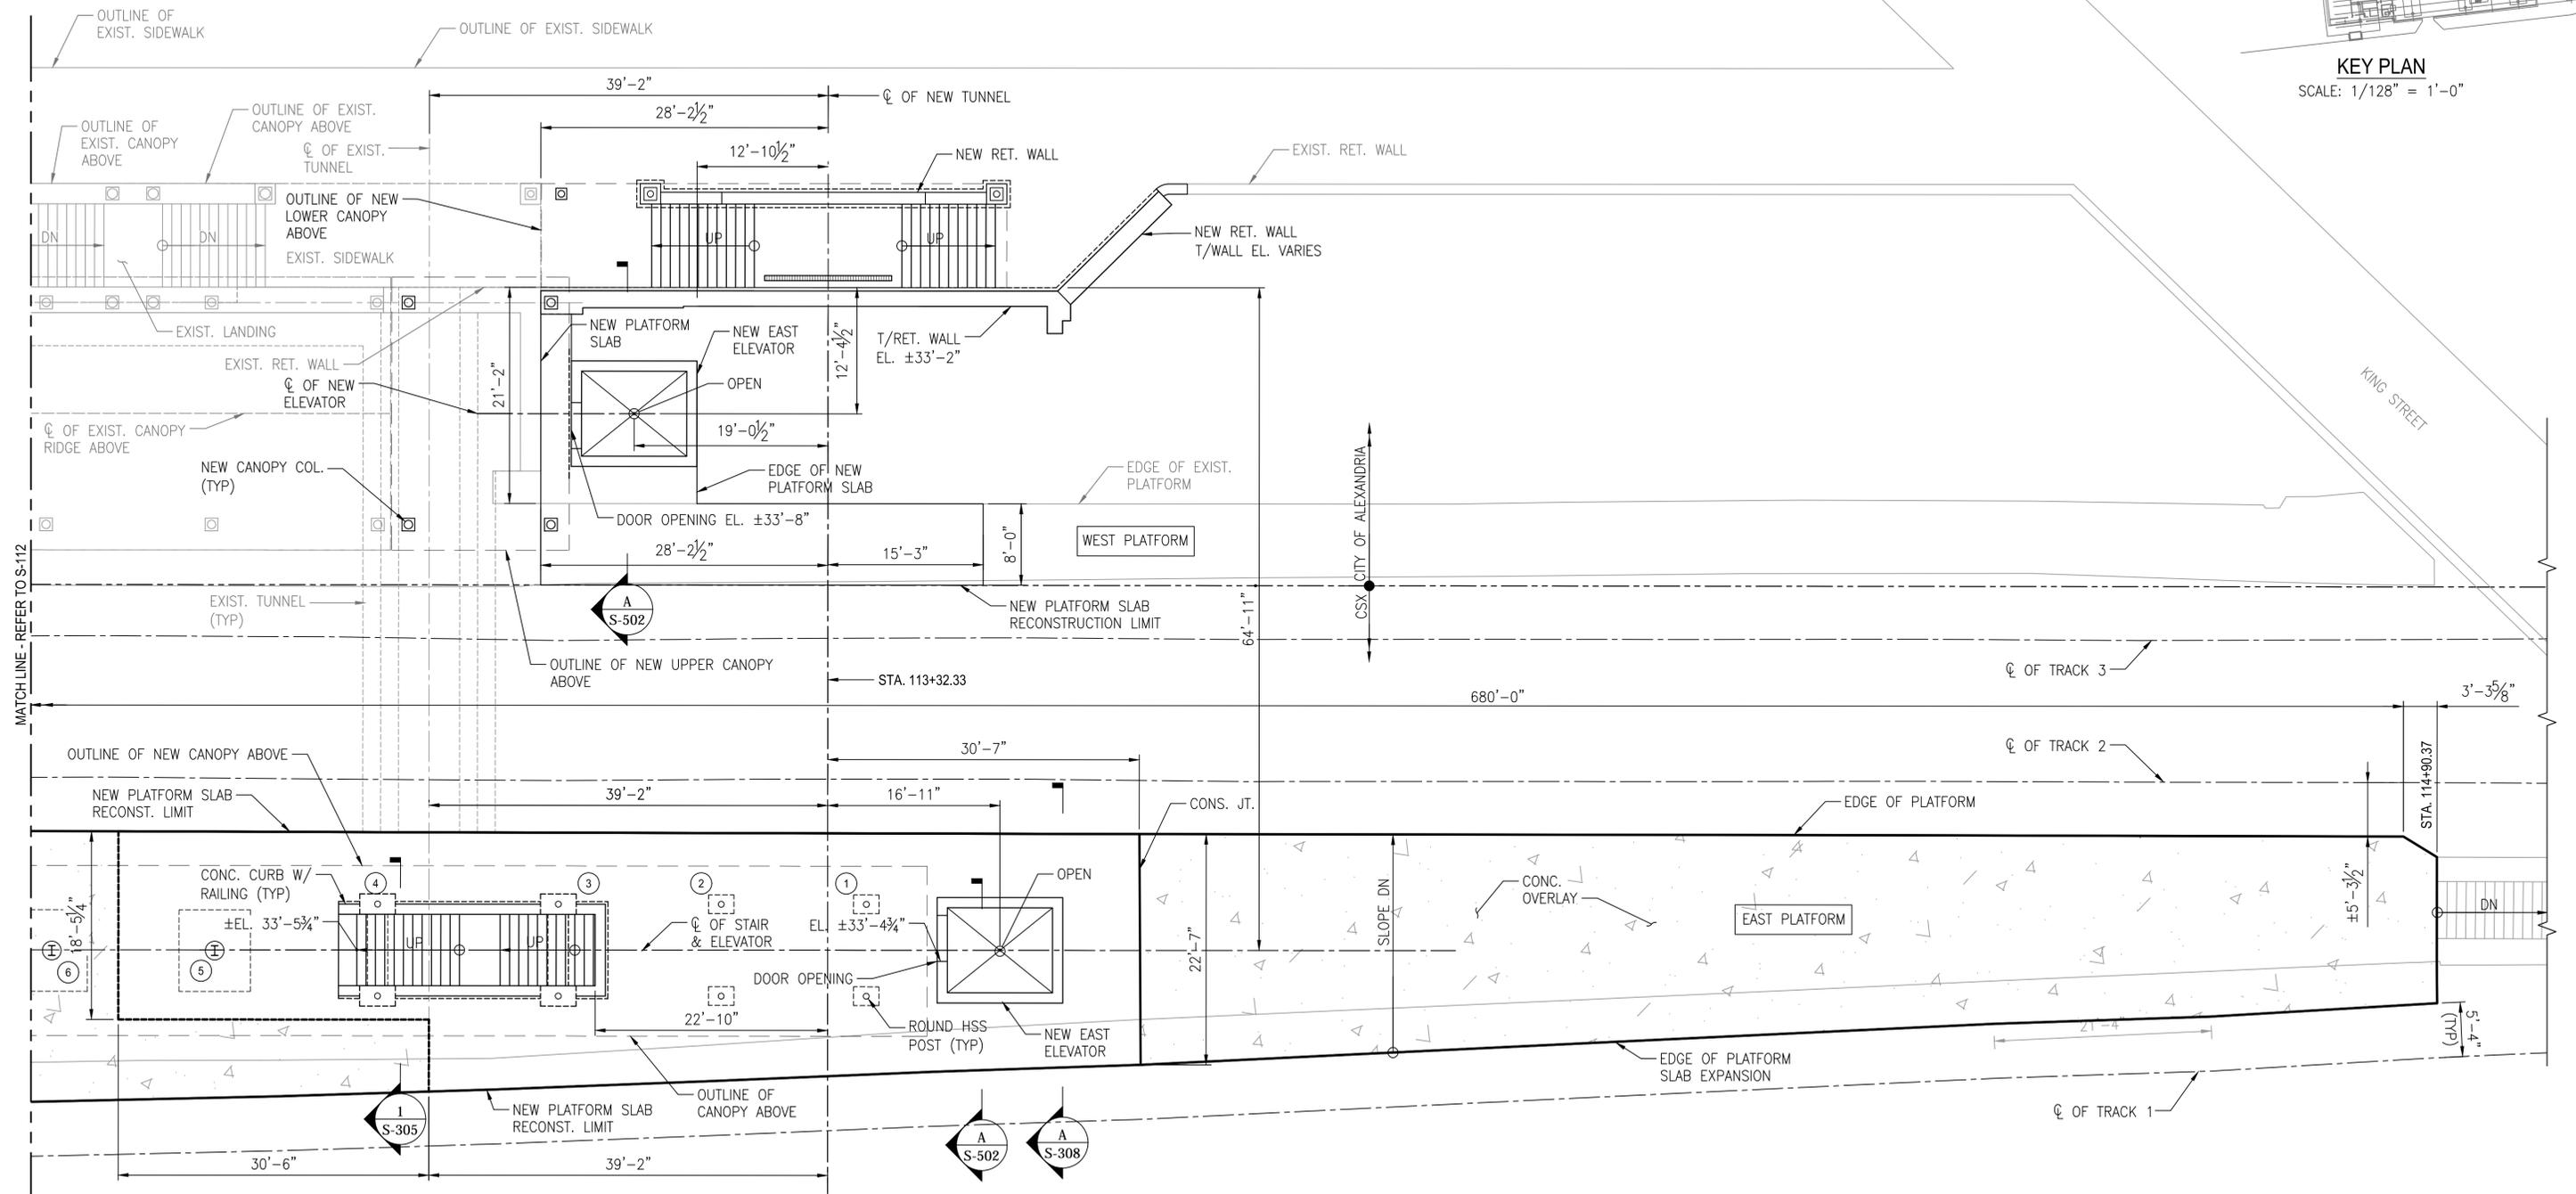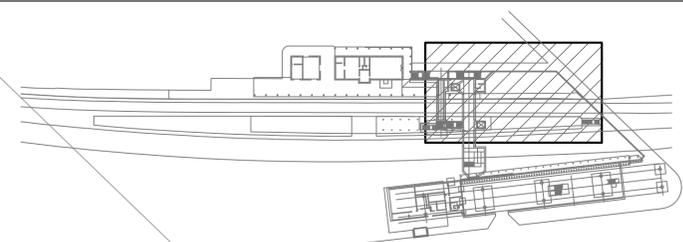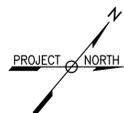

- LEGEND:**
- CONCRETE OVERLAY
 - COLUMN LINE

1 PLATFORM PART PLAN 1 OF 3
SCALE: 1/8" = 1'-0"

- NOTES:**
1. FOR GENERAL NOTES, REFER TO DRAWINGS S-001 TO S-004.
 2. FOR ADDITIONAL INFORMATION ON PLATFORM SLAB, REFER TO DRAWINGS S-303 TO S-305.


60% SUBMITTAL

CONTRACT NO:		REVISIONS			
PROJECT NO:		BY	NO	DATE	DESCRIPTION
DESIGNED:	IA				
DRAFTED:	LTN				
CHECKED:	MA/DB				
APPROVED:					



VIRGINIA RAILWAY EXPRESS
ALEXANDRIA
PEDESTRIAN TUNNEL

DISCIPLINE:		DRAWING NO:
STRUCTURAL		S-111
PLATFORM PART PLAN 1 OF 3		LIST NO:
SCALE:	DATE ISSUED:	
1/8" = 1'-0"	5/25/16	

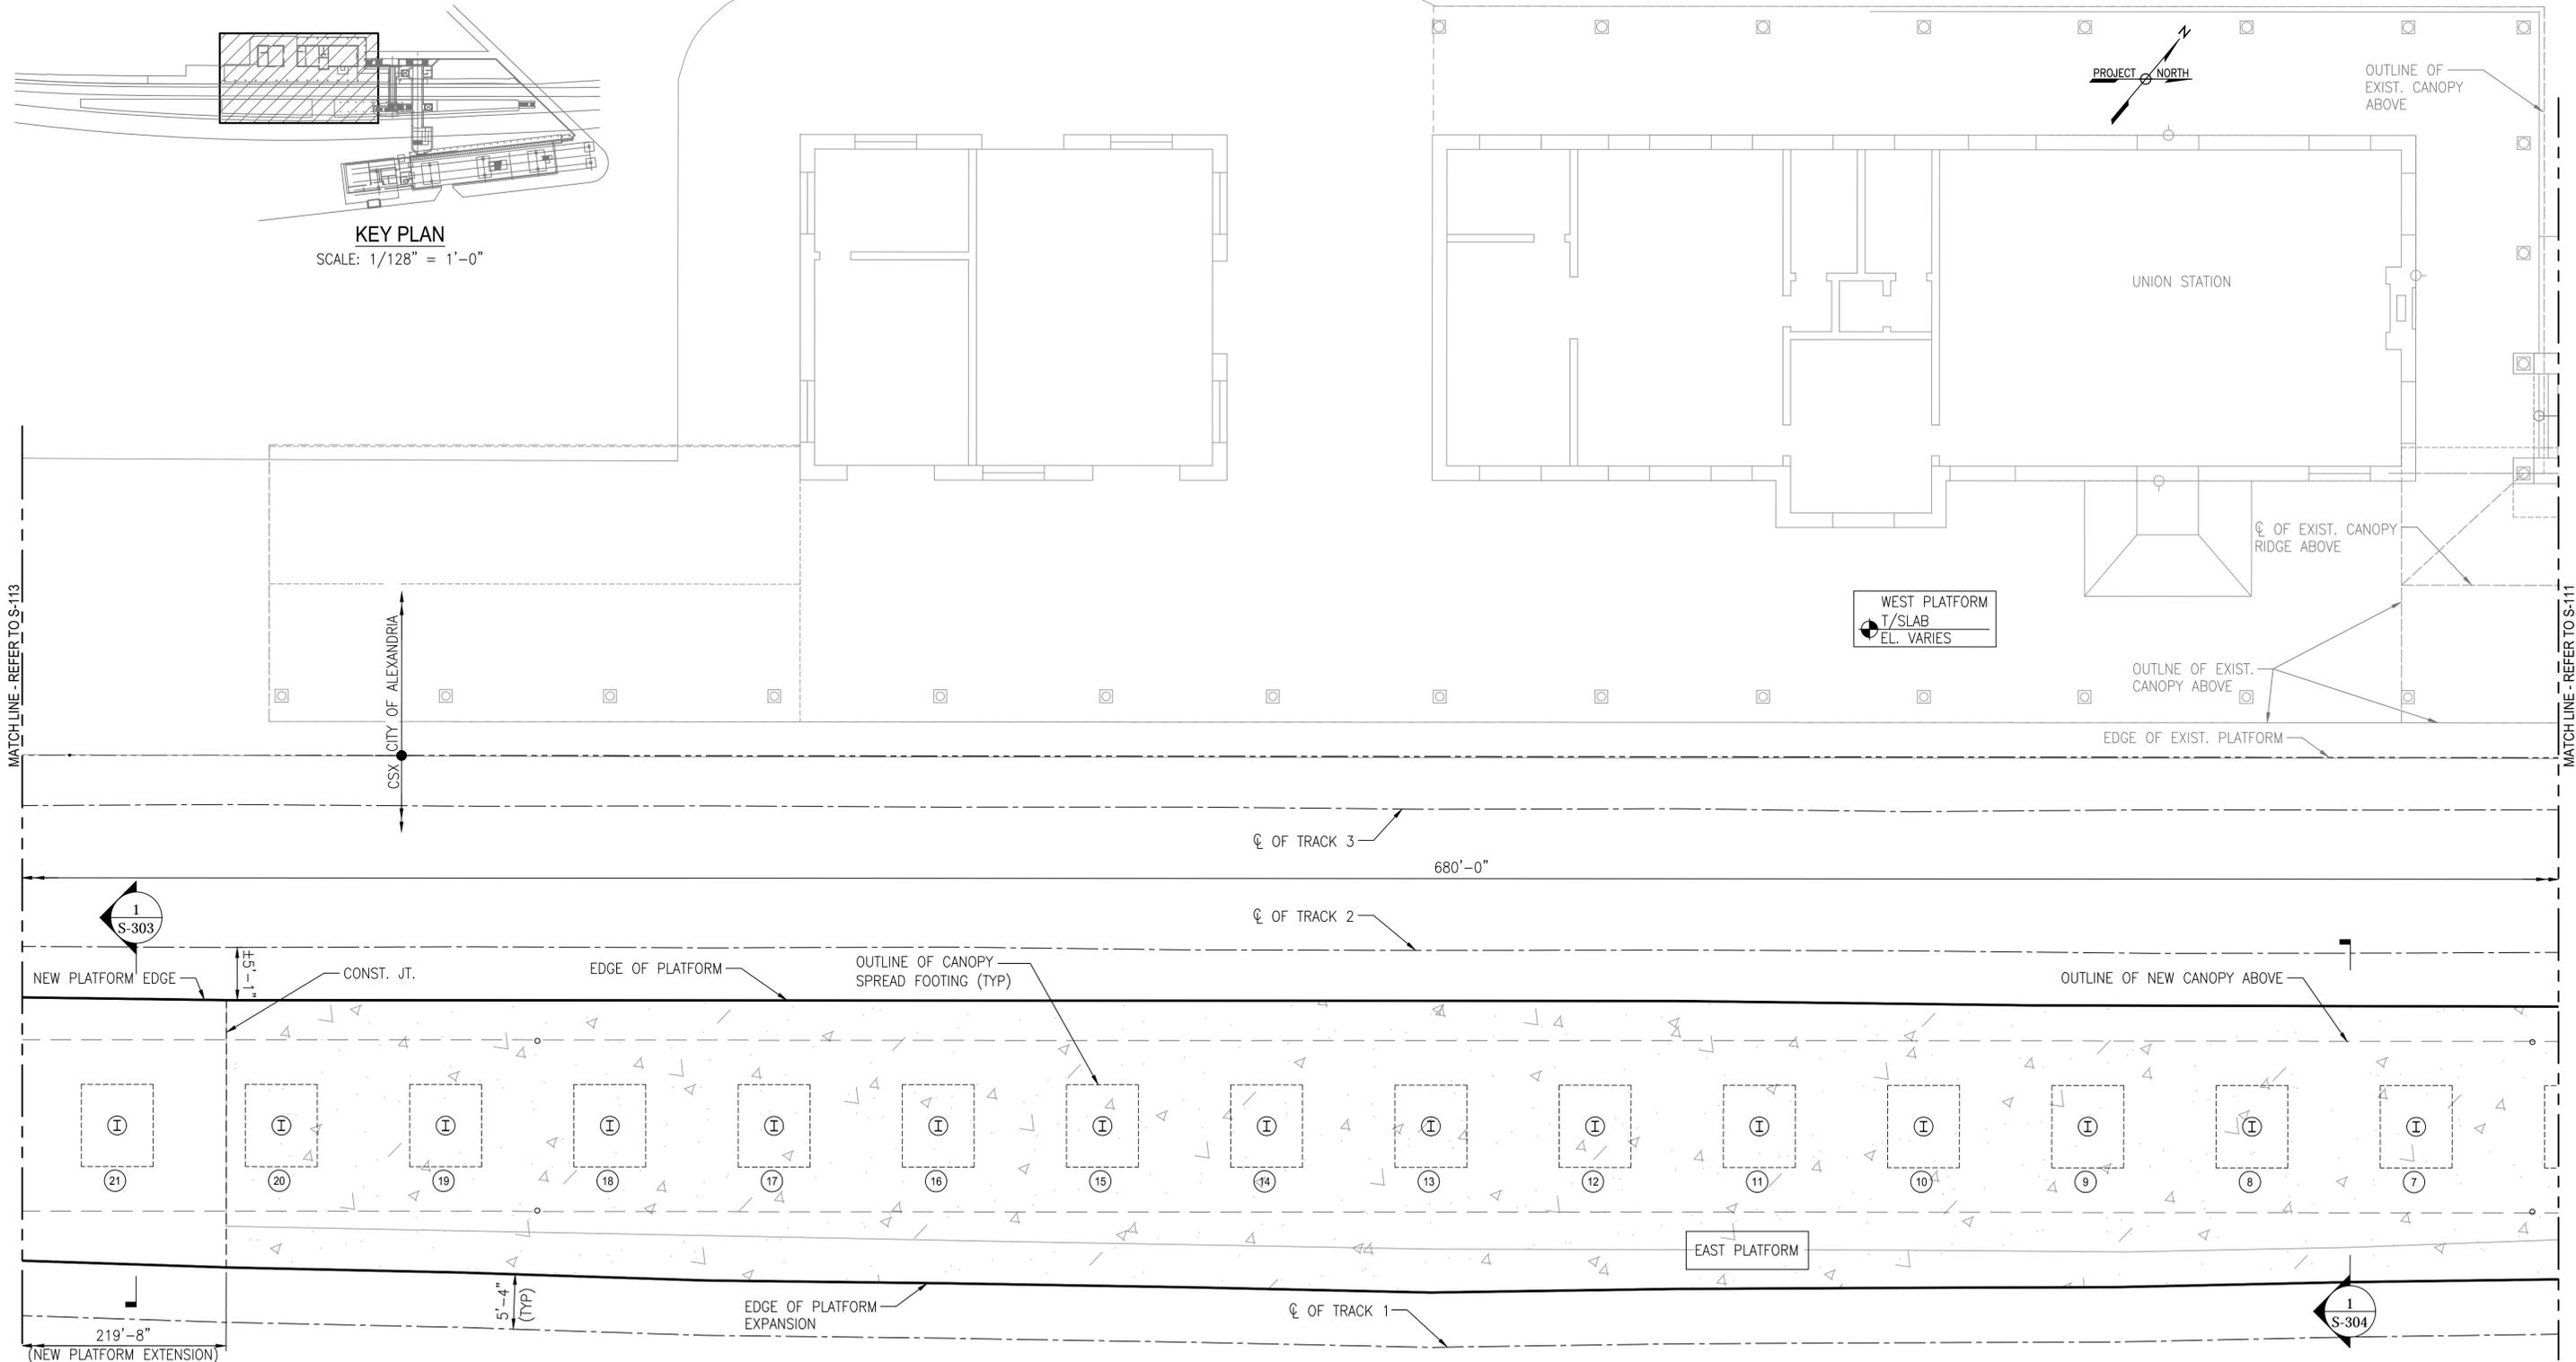

KEY PLAN
SCALE: 1/128" = 1'-0"

PROJECT NORTH

OUTLINE OF EXIST. CANOPY ABOVE

UNION STATION

CL OF EXIST. CANOPY RIDGE ABOVE

WEST PLATFORM
T/SLAB
EL. VARIES

OUTLINE OF EXIST. CANOPY ABOVE

EDGE OF EXIST. PLATFORM

CL OF TRACK 3
680'-0"

CL OF TRACK 2

1
S-303

NEW PLATFORM EDGE

1'-6"

CONST. JT.

EDGE OF PLATFORM

OUTLINE OF CANOPY SPREAD FOOTING (TYP)

OUTLINE OF NEW CANOPY ABOVE

21
20
19
18
17
16
15
14
13
12
11
10
9
8
7

EAST PLATFORM

219'-8"
(NEW PLATFORM EXTENSION)

5'-4"
(TYP)

EDGE OF PLATFORM EXPANSION

CL OF TRACK 1

1
S-304

LEGEND:

CONCRETE OVERLAY

COLUMN LINE

NOTES:

1. FOR GENERAL NOTES, REFER TO DRAWINGS S-001 TO S-004.

1 S-112 PLATFORM PART PLAN 2 OF 3
SCALE: 1/8" = 1'-0"




60% SUBMITTAL

CONTRACT NO:		REVISIONS			
PROJECT NO:		BY	NO	DATE	DESCRIPTION
DESIGNED:	IA				
DRAFTED:	LTN				
CHECKED:	MA/DB				
APPROVED:					



VIRGINIA RAILWAY EXPRESS
ALEXANDRIA
PEDESTRIAN TUNNEL

DISCIPLINE:		DRAWING NO:
STRUCTURAL PLATFORM PART PLAN 2 OF 3		S-112
SCALE:	DATE ISSUED:	LIST NO:
1/8" = 1'-0"	5/25/16	

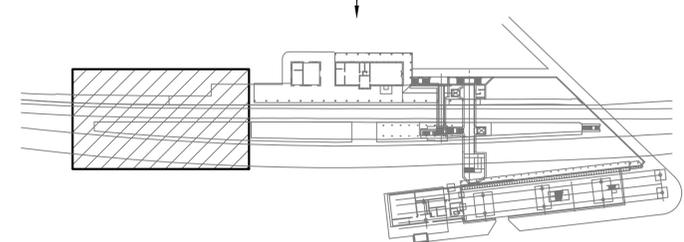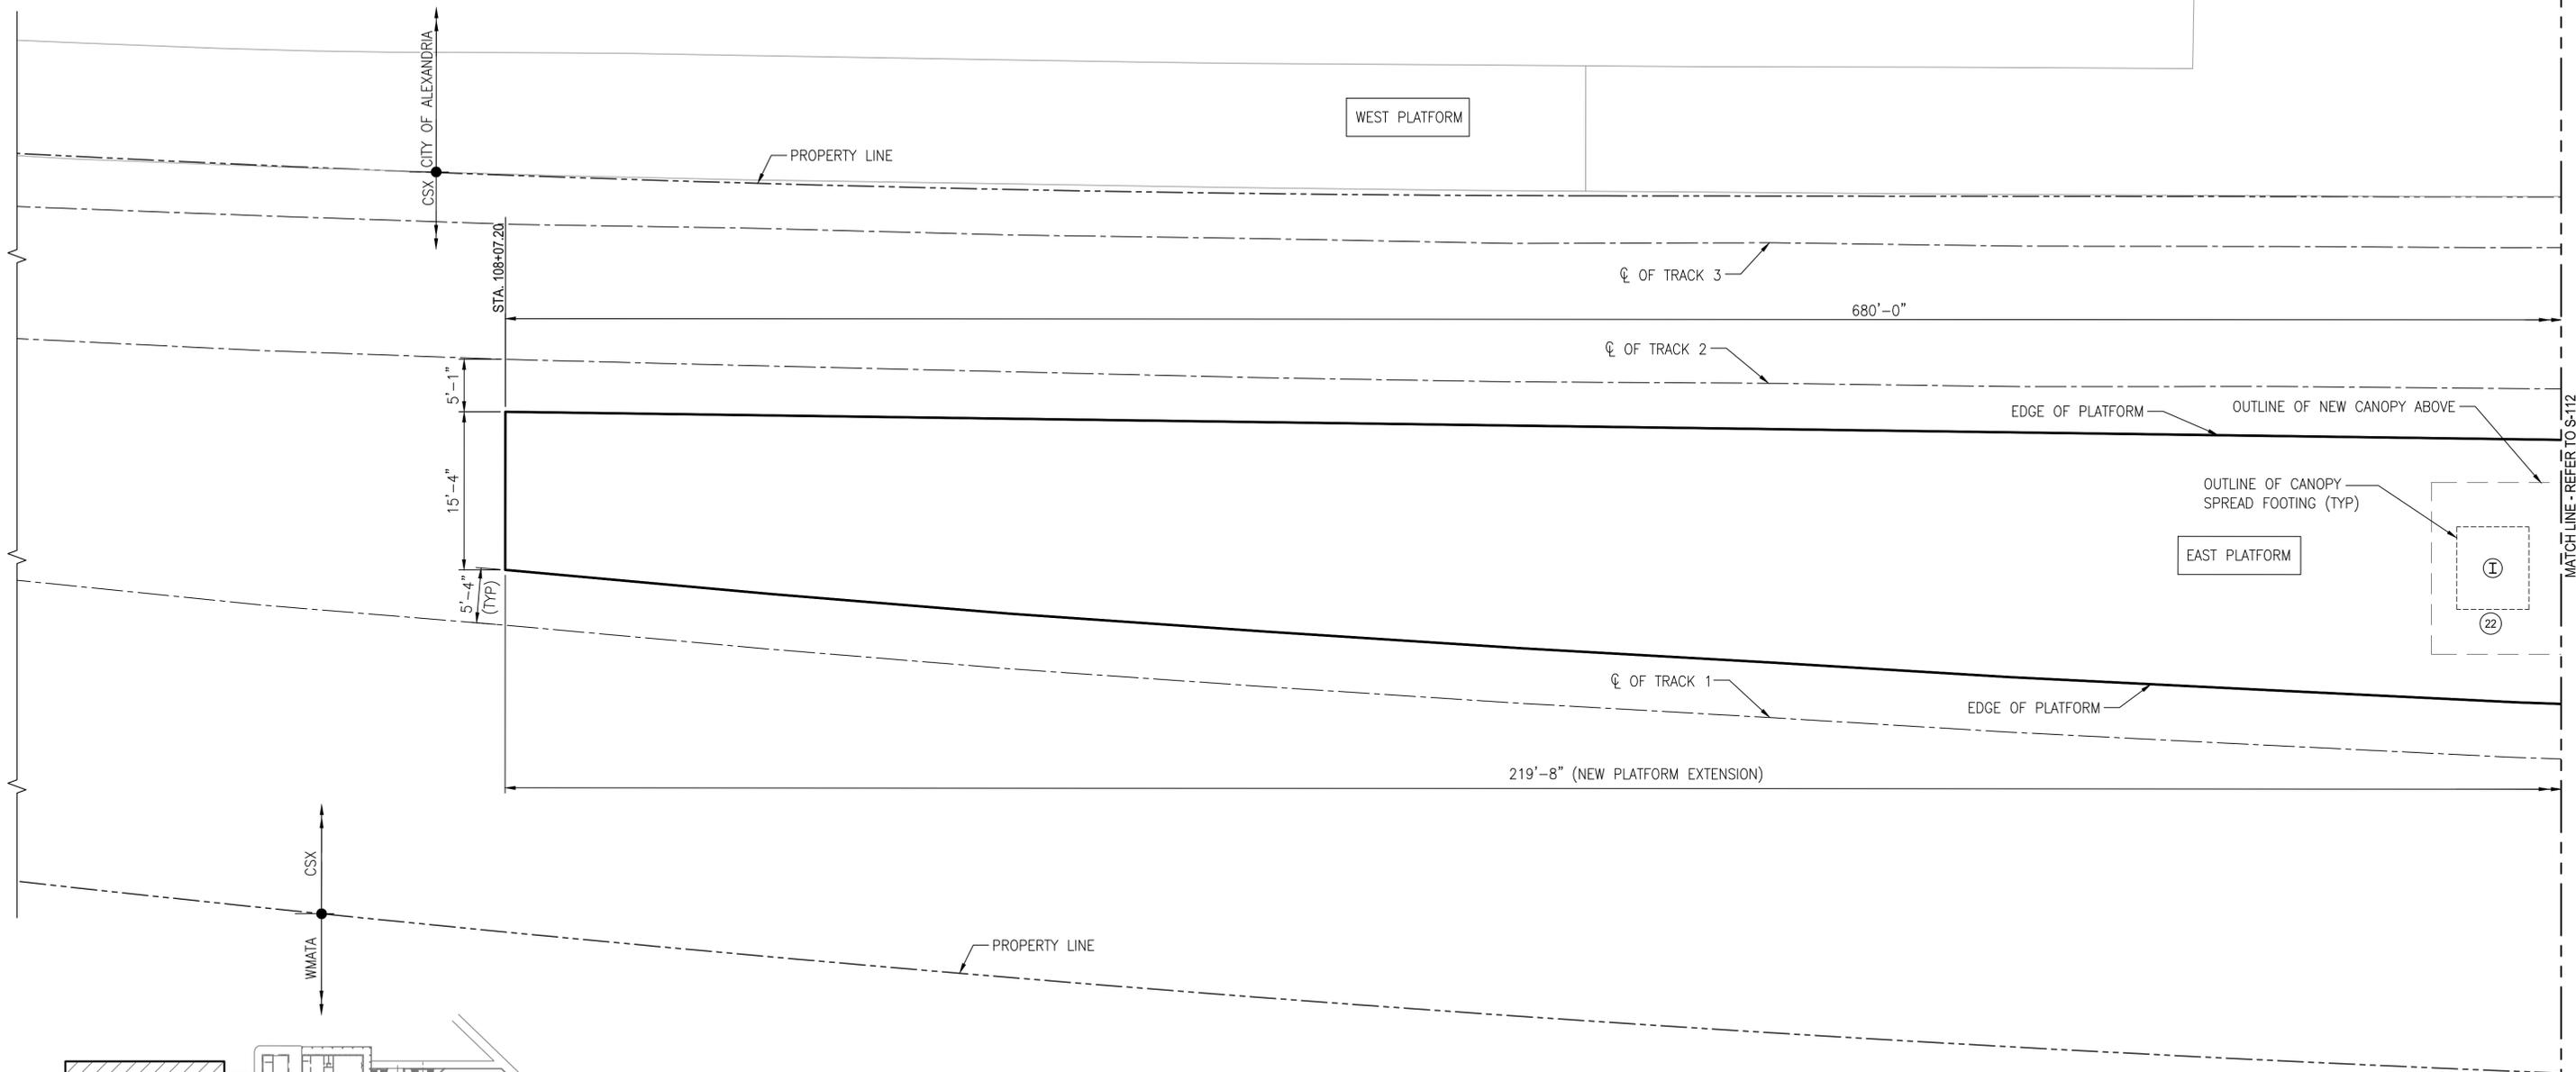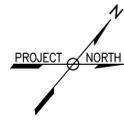

KEY PLAN
SCALE: 1/128" = 1'-0"

1 S-113 **PLATFORM PART PLAN 3 OF 3**
SCALE: 1/8" = 1'-0"

NOTES:

- FOR GENERAL NOTES, REFER TO DRAWINGS S-001 TO S-004.

LEGEND:

- ① COLUMN LINE

60% SUBMITTAL


CONTRACT NO:		REVISIONS			
PROJECT NO:		BY	NO	DATE	DESCRIPTION
DESIGNED:	IA				
DRAFTED:	LTN				
CHECKED:	MA/DB				
APPROVED:					



VIRGINIA RAILWAY EXPRESS
**ALEXANDRIA
PEDESTRIAN TUNNEL**

DISCIPLINE:		DRAWING NO:
STRUCTURAL		S-113
PLATFORM PART PLAN 3 OF 3		LIST NO:
SCALE:	DATE ISSUED:	
1/8" = 1'-0"	5/25/16	

DRAWING NO:
S-113
LIST NO:

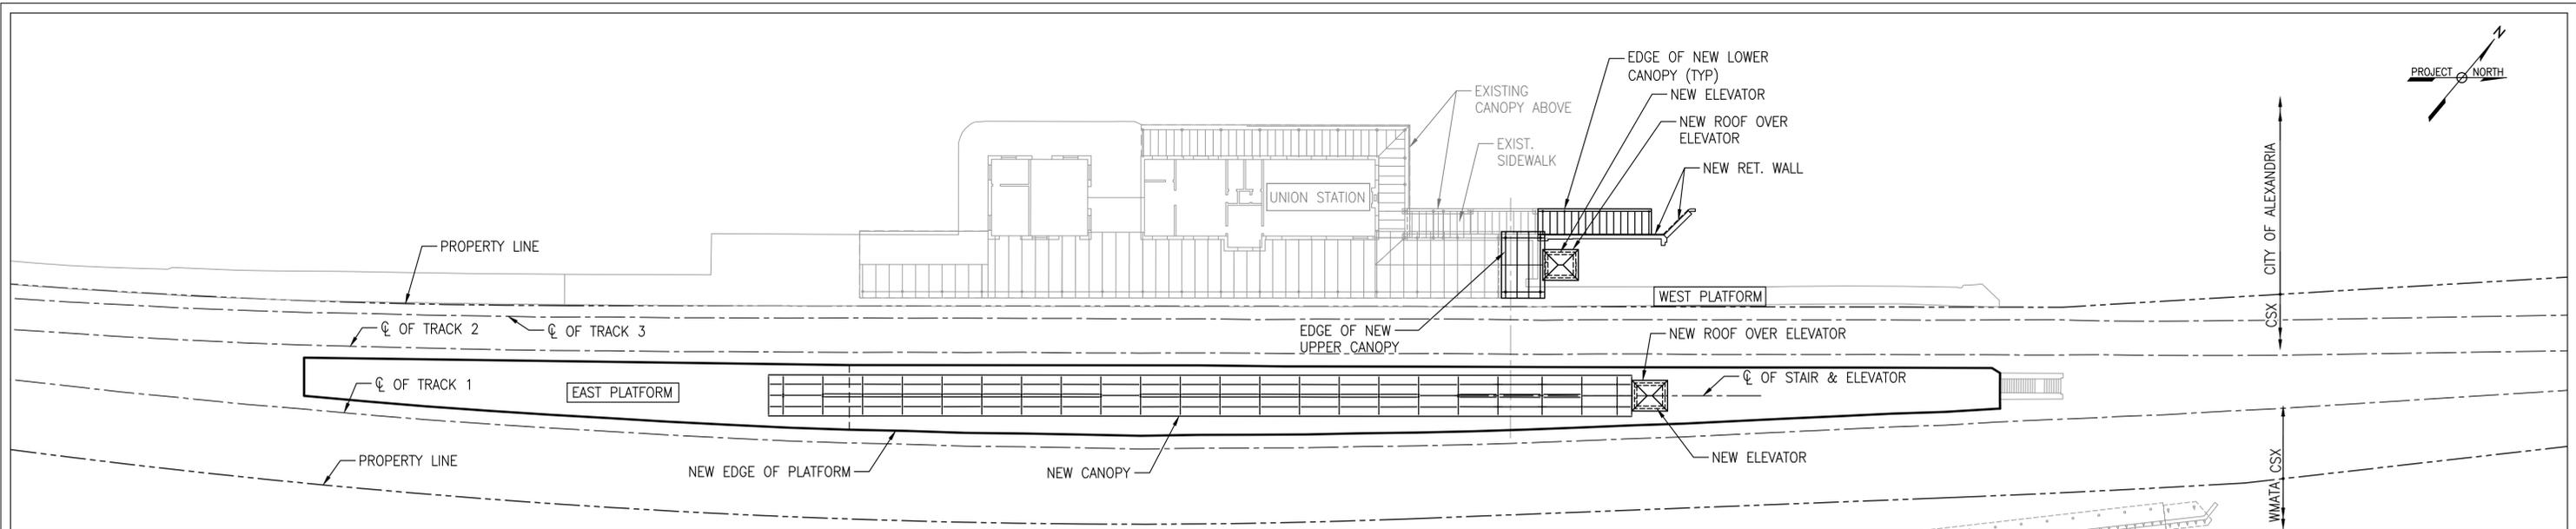

1 OVERALL CANOPY PLAN
 S-114 SCALE: 1/32" = 1'-0"

NOTES:

- FOR GENERAL NOTES, REFER TO DRAWINGS S-001 TO S-004.



60% SUBMITTAL

CONTRACT NO:		REVISIONS			
PROJECT NO:		BY	NO	DATE	DESCRIPTION
DESIGNED:	IA				
DRAFTED:	LTN				
CHECKED:	MA/DB				
APPROVED:					




VIRGINIA RAILWAY EXPRESS
 ALEXANDRIA
 PEDESTRIAN TUNNEL

DISCIPLINE:		DRAWING NO:
STRUCTURAL OVERALL CANOPY PLAN		S-114
SCALE:	DATE ISSUED:	LIST NO:
1/32" = 1'-0"	5/25/16	

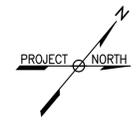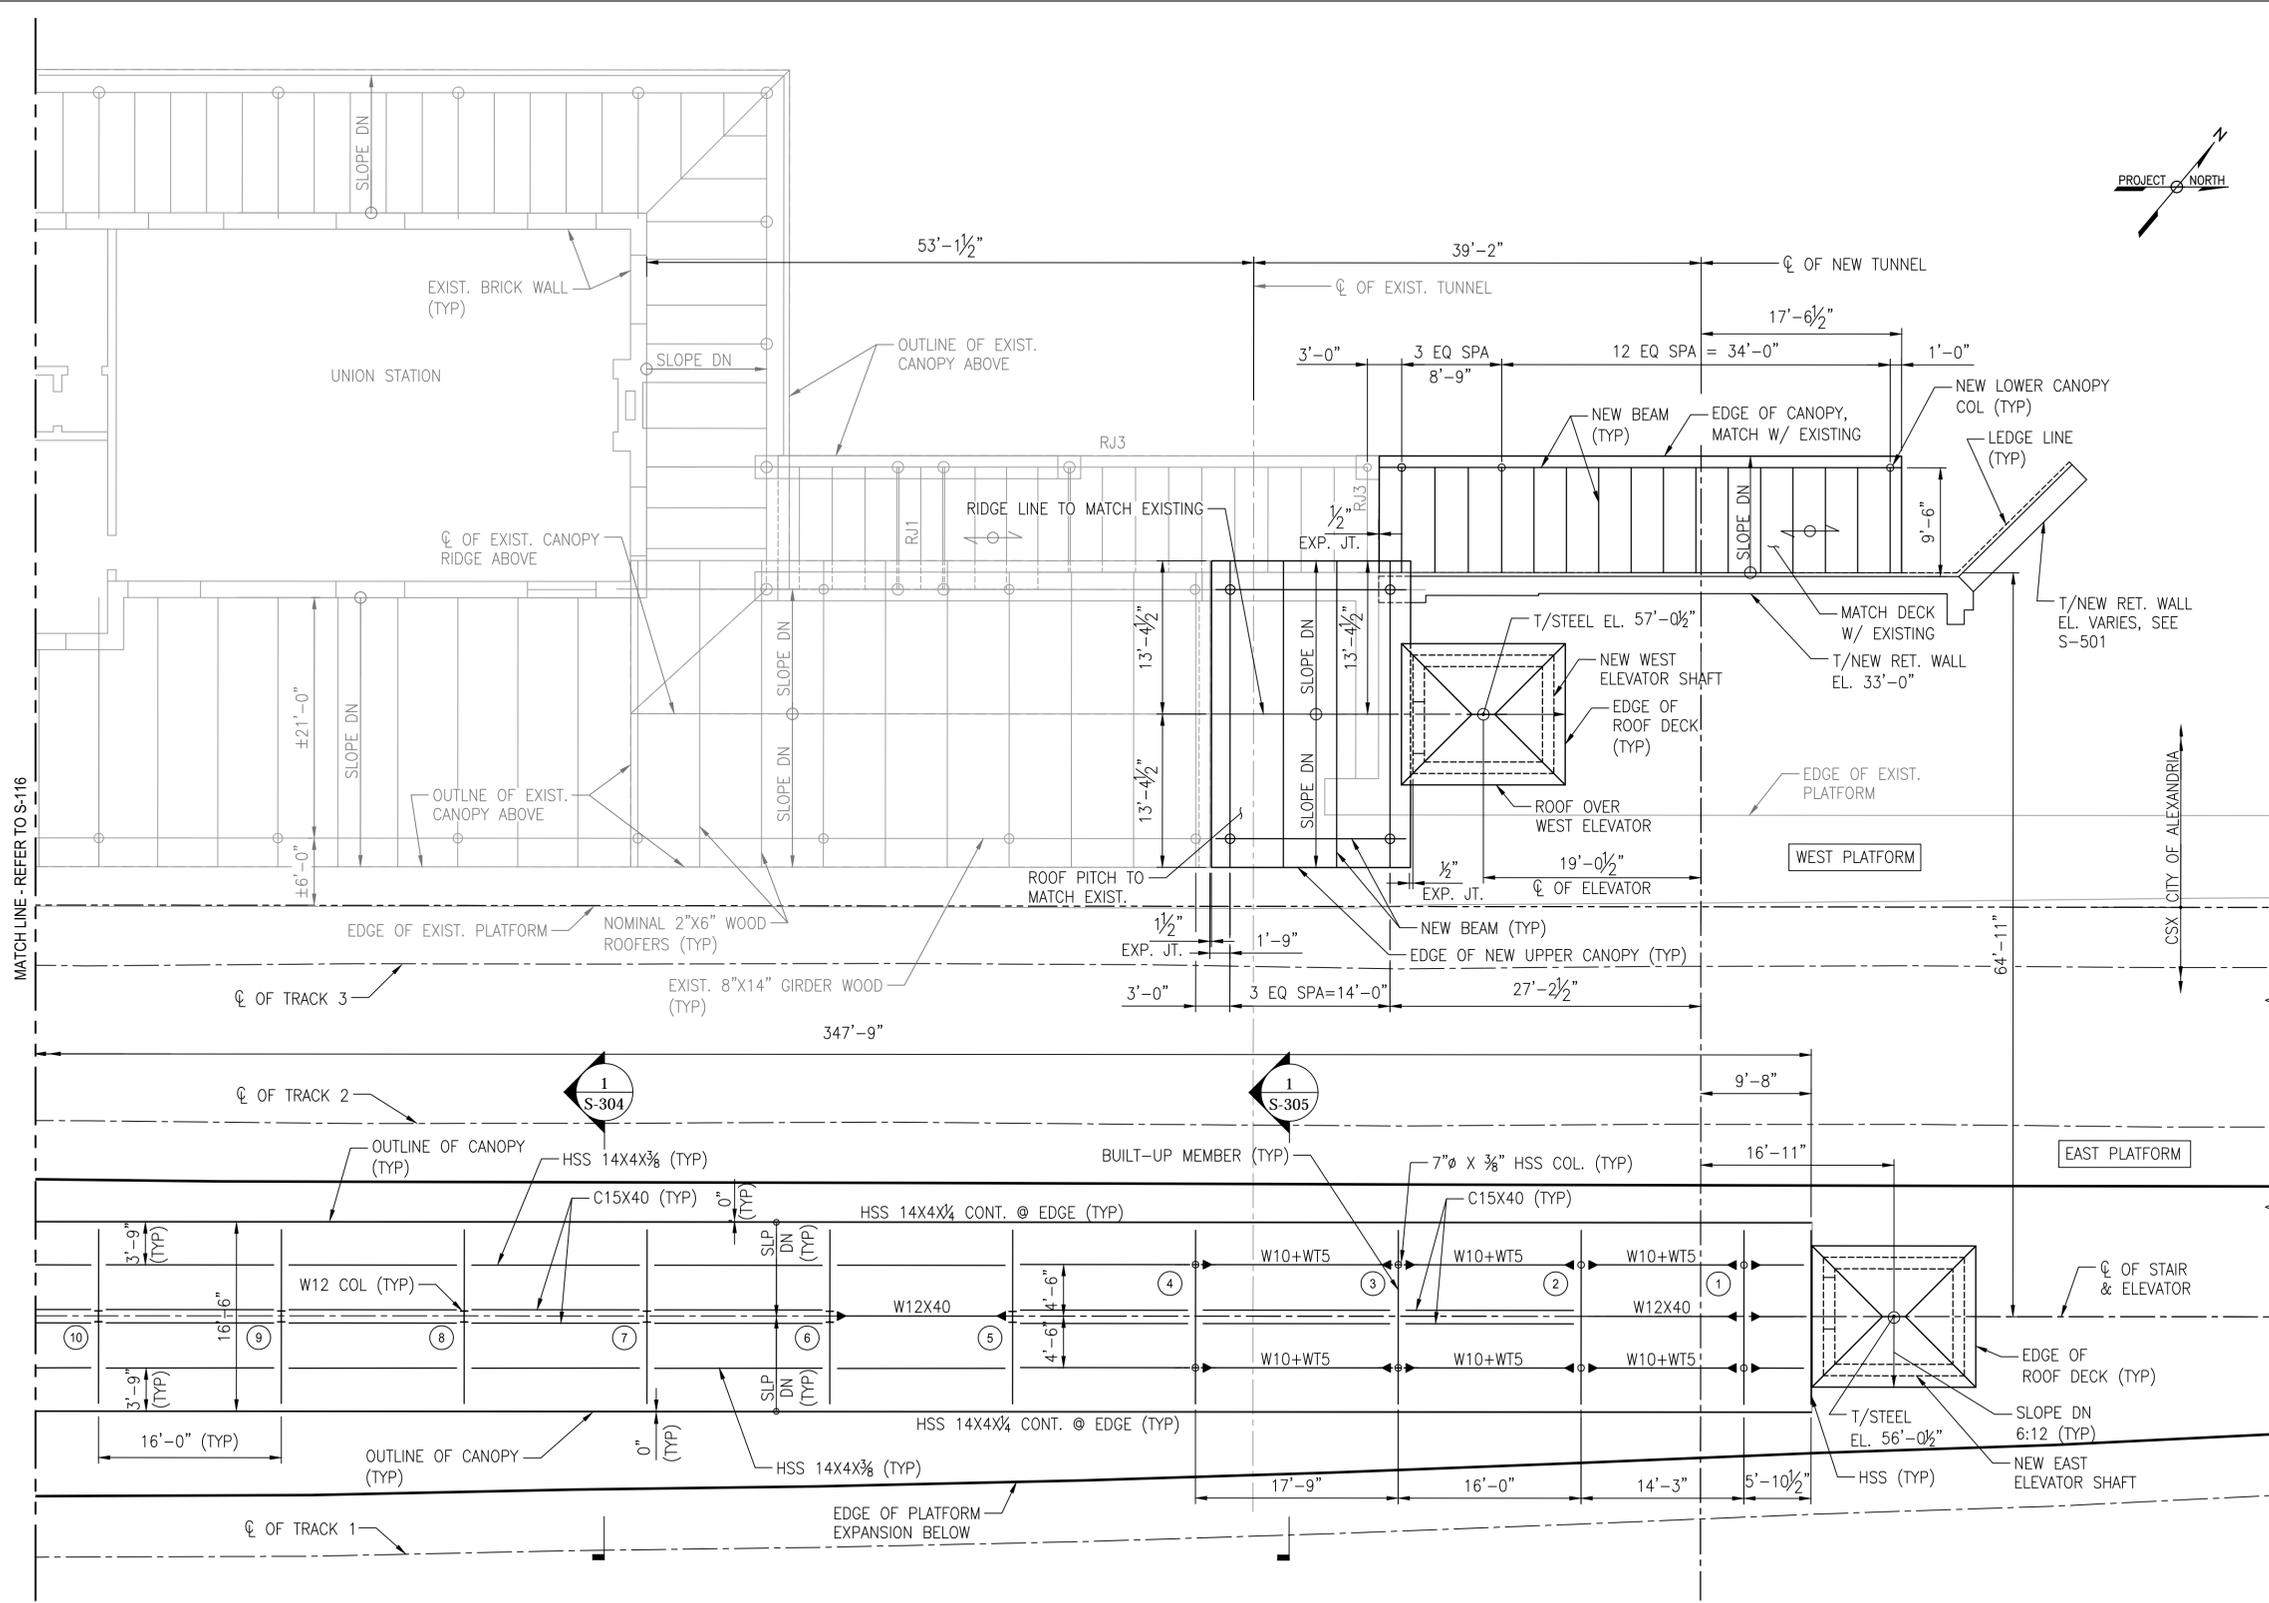

- NOTES:**
- FOR GENERAL NOTES, REFER TO DRAWINGS S-001 TO S-004.
 - EXISTING LOWER CANOPY ROOF
 - 3/4" PLYWOOD ROOF SHEATHING OVER 3/4" TONGUE AND GROOVE BEADED BOARD.
 - RJ1 3 1/2" X 9 1/4" WOOD JOIST
 - RJ2 4 - 2" X 12" WOOD BEAM
 - RJ3 3 1/2" X 14" + 1 3/4" X 14" WOOD GIRDER
 - FOR ELEVATOR ROOF PART PLAN, SEE DRAWING S-402.

- LEGEND:**
- MOMENT CONNECTION
 - COLUMN LINE

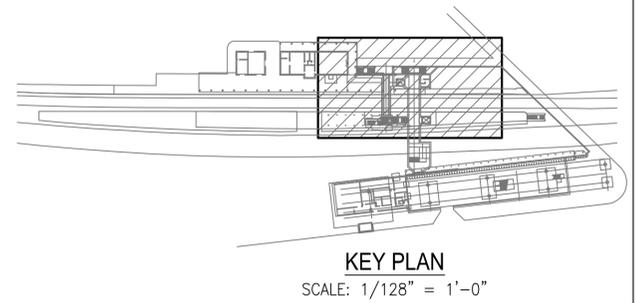

1
S-115 **CANOPY PART PLAN 1 OF 2**
SCALE: 1/8" = 1'-0"


60% SUBMITTAL

CONTRACT NO:	REVISIONS			
PROJECT NO:	BY	NO	DATE	DESCRIPTION
DESIGNED: IA				
DRAFTED: LTN				
CHECKED: MA/DB				
APPROVED:				




VIRGINIA RAILWAY EXPRESS
ALEXANDRIA
PEDESTRIAN TUNNEL

DISCIPLINE:	DRAWING NO:
STRUCTURAL	S-115
CANOPY PART PLAN 1 OF 2	LIST NO:
SCALE: 1/8" = 1'-0"	DATE ISSUED: 5/25/16

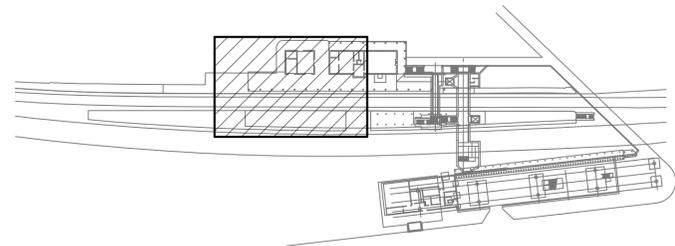

KEY PLAN
SCALE: 1/128" = 1'-0"

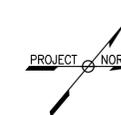


NOTES:

- FOR GENERAL NOTES, REFER TO DRAWINGS S-001 TO S-004.

LEGEND:

- MOMENT CONNECTION
- COLUMN LINE

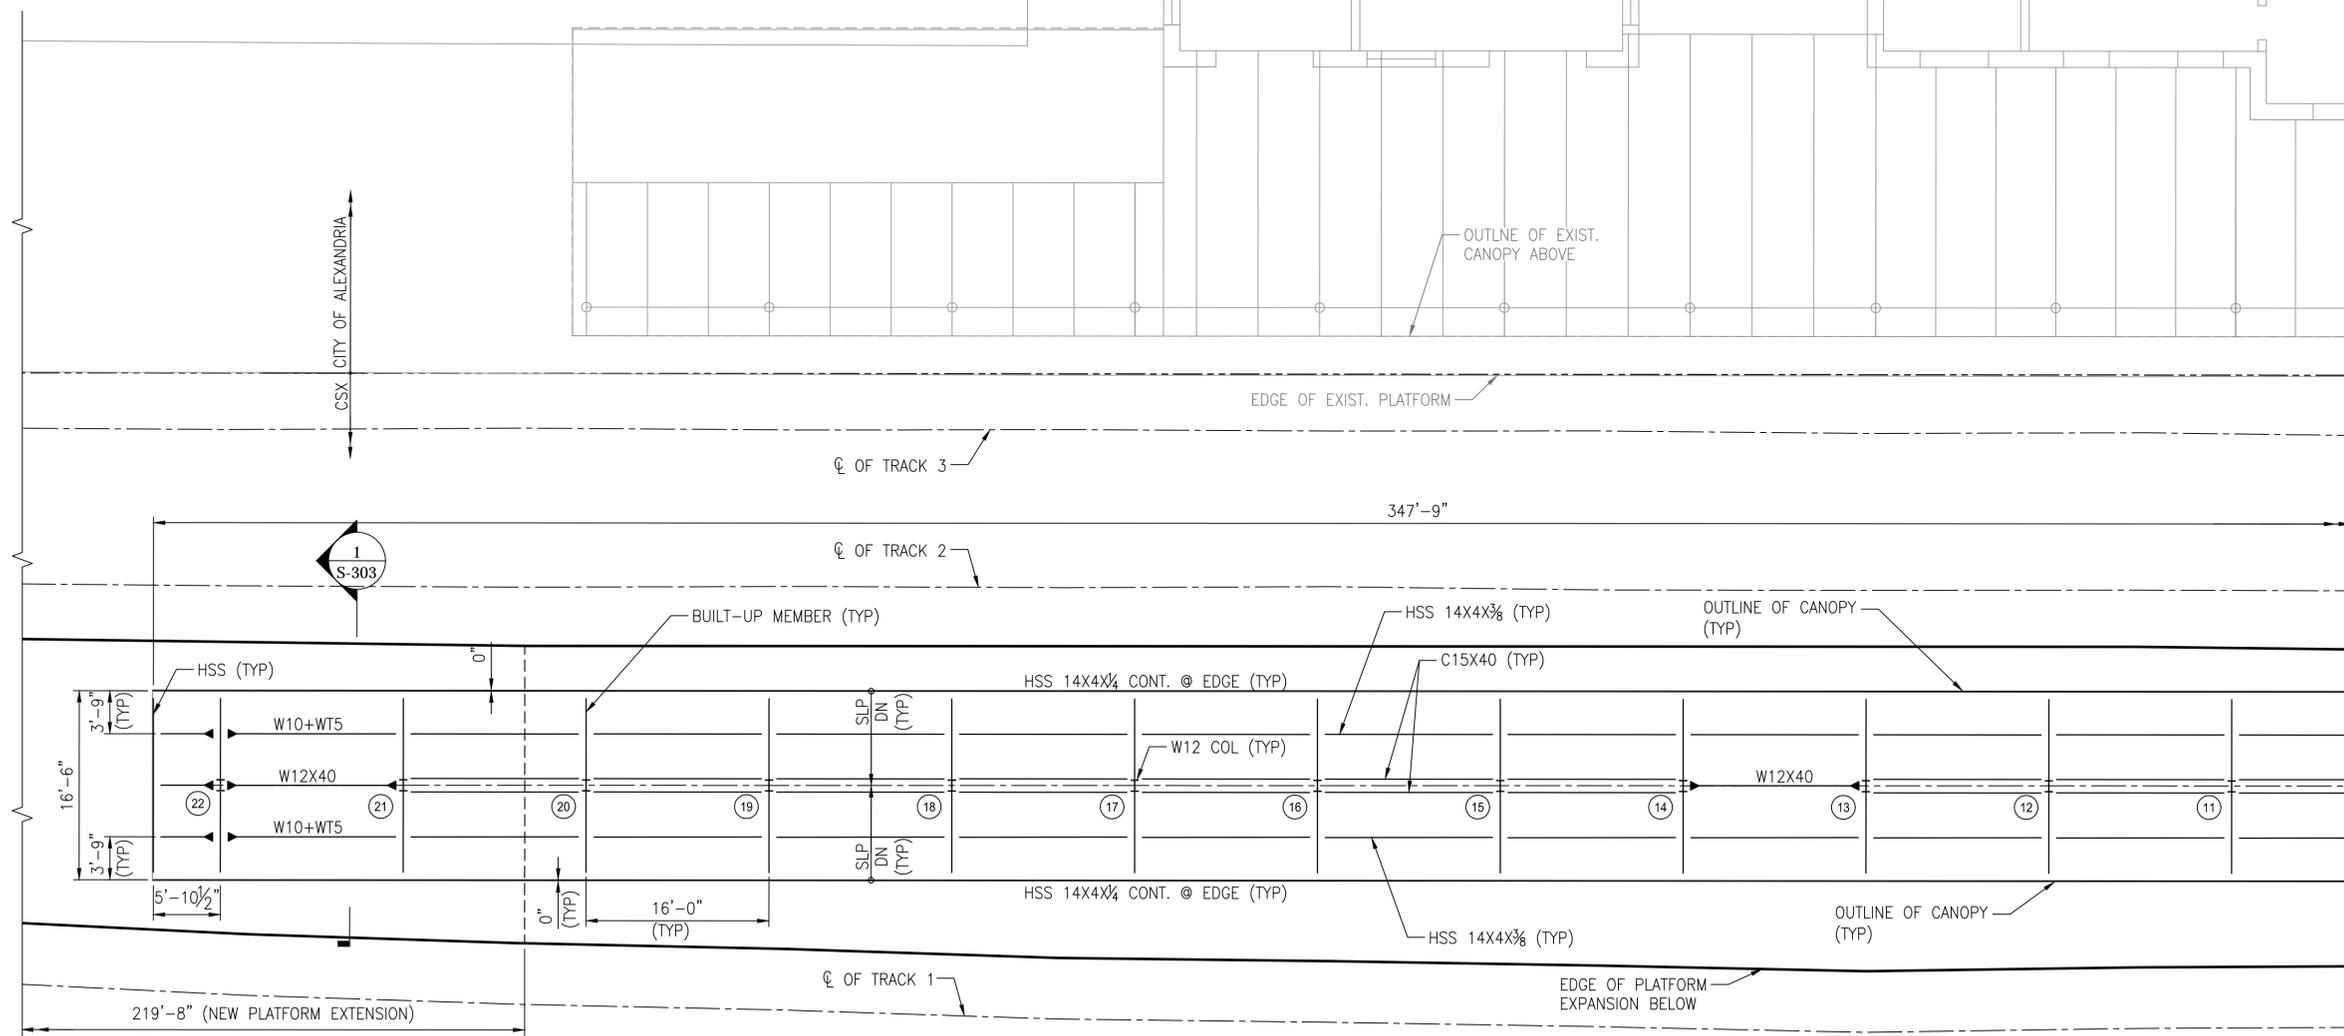

1
S-116 CANOPY PART PLAN 2 OF 2
SCALE: 1/8" = 1'-0"


60% SUBMITTAL

CONTRACT NO:	REVISIONS			
PROJECT NO:	BY	NO	DATE	DESCRIPTION
DESIGNED: IA				
DRAFTED: LTN				
CHECKED: MA/DB				
APPROVED:				



VIRGINIA RAILWAY EXPRESS
ALEXANDRIA
PEDESTRIAN TUNNEL

DISCIPLINE:	DRAWING NO:
STRUCTURAL	S-116
CANOPY PART PLAN 2 OF 2	LIST NO:
SCALE: 1/8" = 1'-0"	DATE ISSUED: 5/25/16

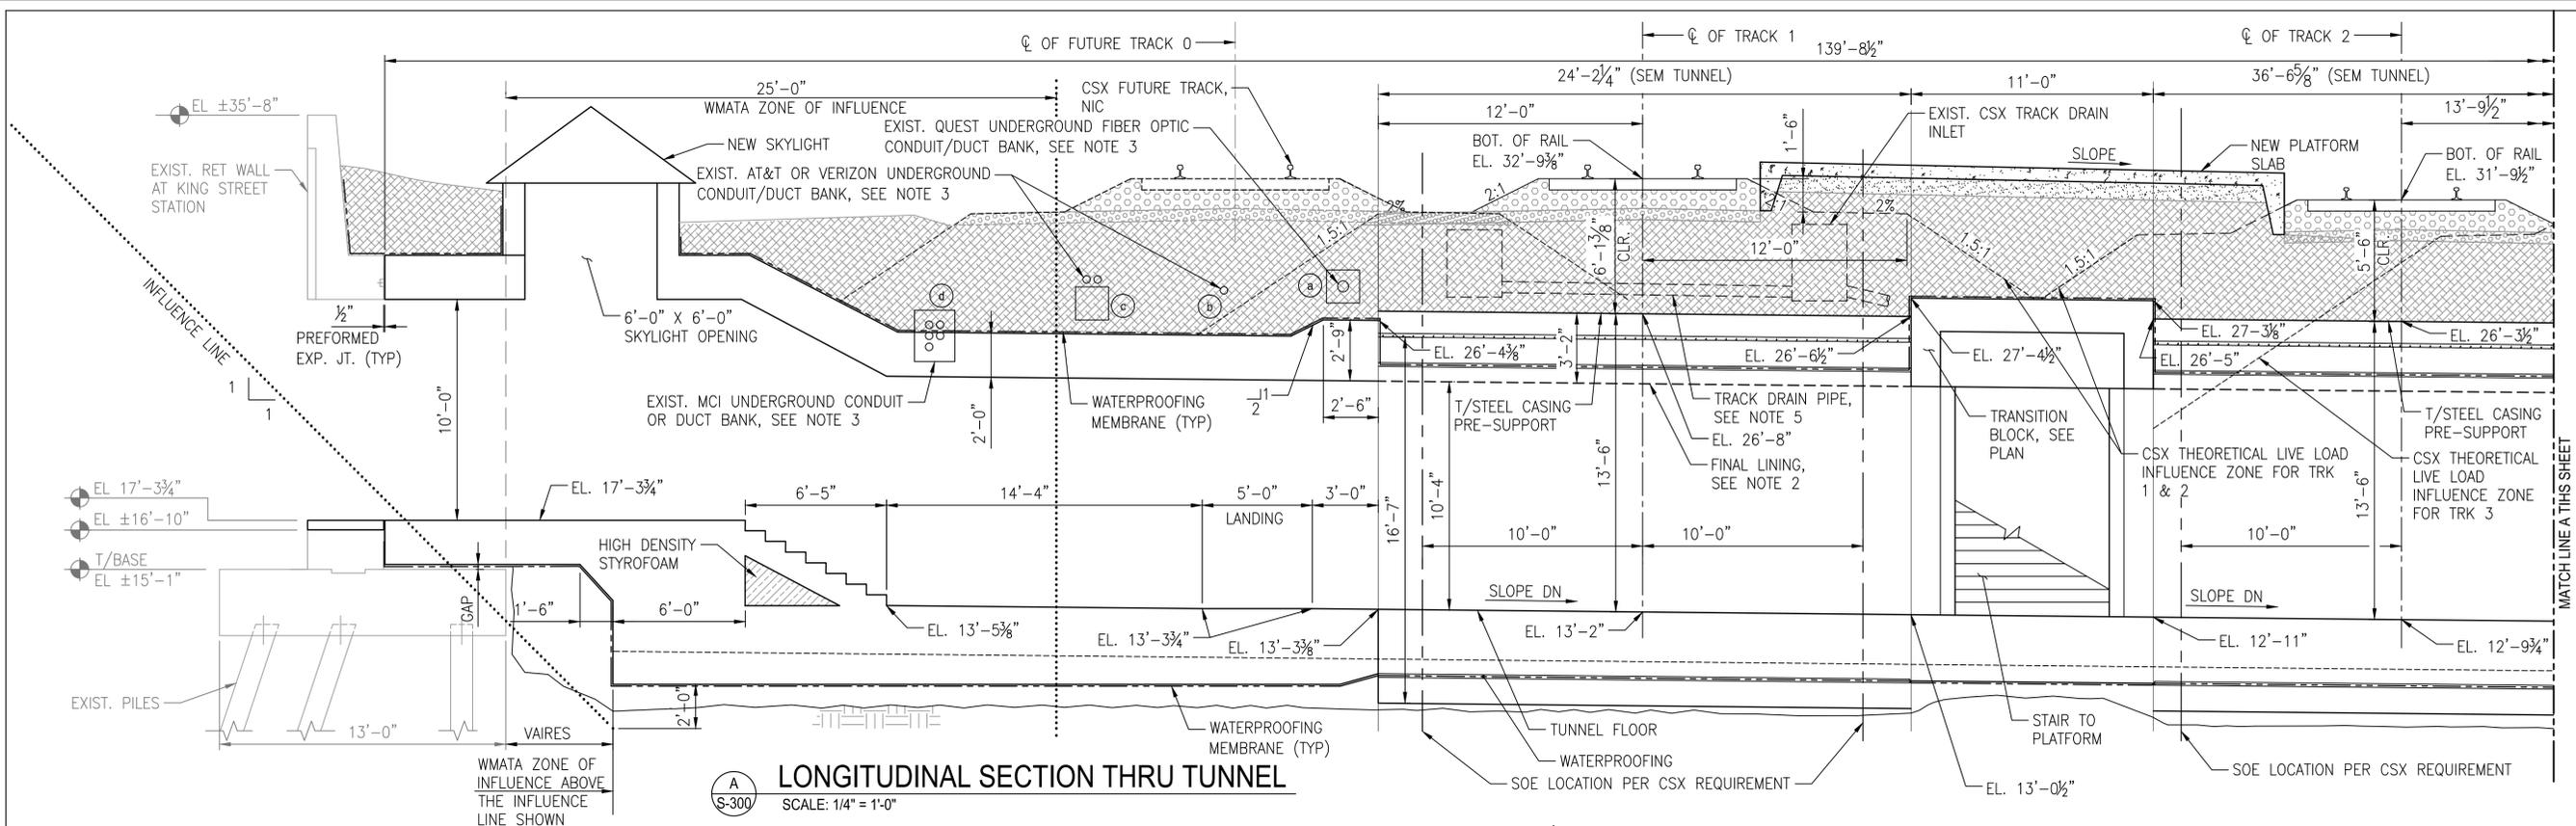


NOTES:

- FOR GENERAL NOTES, REFER TO DRAWINGS S-001 TO S-004.
- FOR INFO RELATED TO SEM TUNNEL, REFER STRUCTURAL-TUNNEL DRAWING SERIES.
- LOCATION OF (b) TO (d) CONDUIT/DUCT BANKS ARE BASED ON LIMITED TEST HOLE INFORMATION DEVELOPED BY ACCUMARK DATED 04-11-15. LOCATION OF CONDUIT/DUCT BANK (a) IS BASED ON GENERAL INFORMATION PROVIDED BY THE OWNER, QUEST CENTURY LINK. FOR TEMPORARY SUPPORT OF ALL EXISTING UTILITIES DURING CONSTRUCTION AND PERMANENT RELOCATION, REFER TO CIVIL DRAWINGS AND S-117.
- FOR TUNNEL WATERPROOFING PLANS AND DETAILS, REFER TO DRAWINGS S-780 TO S-786.

LEGEND:

- (a) CONDUIT/DUCT BANK NUMBER

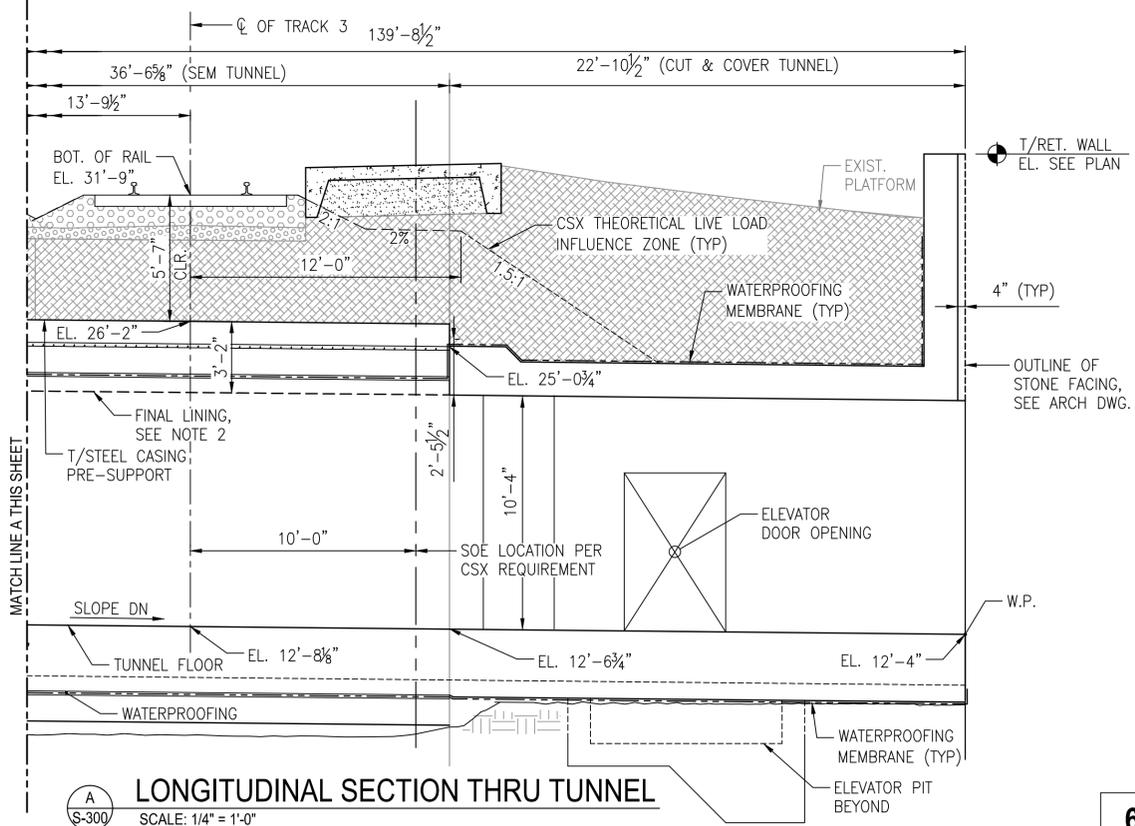

60% SUBMITTAL


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	BY	NO	DATE	DESCRIPTION
PROJECT NO:				
DESIGNED: IA				
DRAFTED: LTN				
CHECKED: MA/DB				
APPROVED:				




VIRGINIA RAILWAY EXPRESS
 ALEXANDRIA
 PEDESTRIAN TUNNEL

DISCIPLINE:
**STRUCTURAL
 TUNNEL LONGITUDINAL SECTION**
 SCALE: 1/4" = 1'-0" DATE ISSUED: 5/25/16

DRAWING NO:
S-300
 LIST NO:

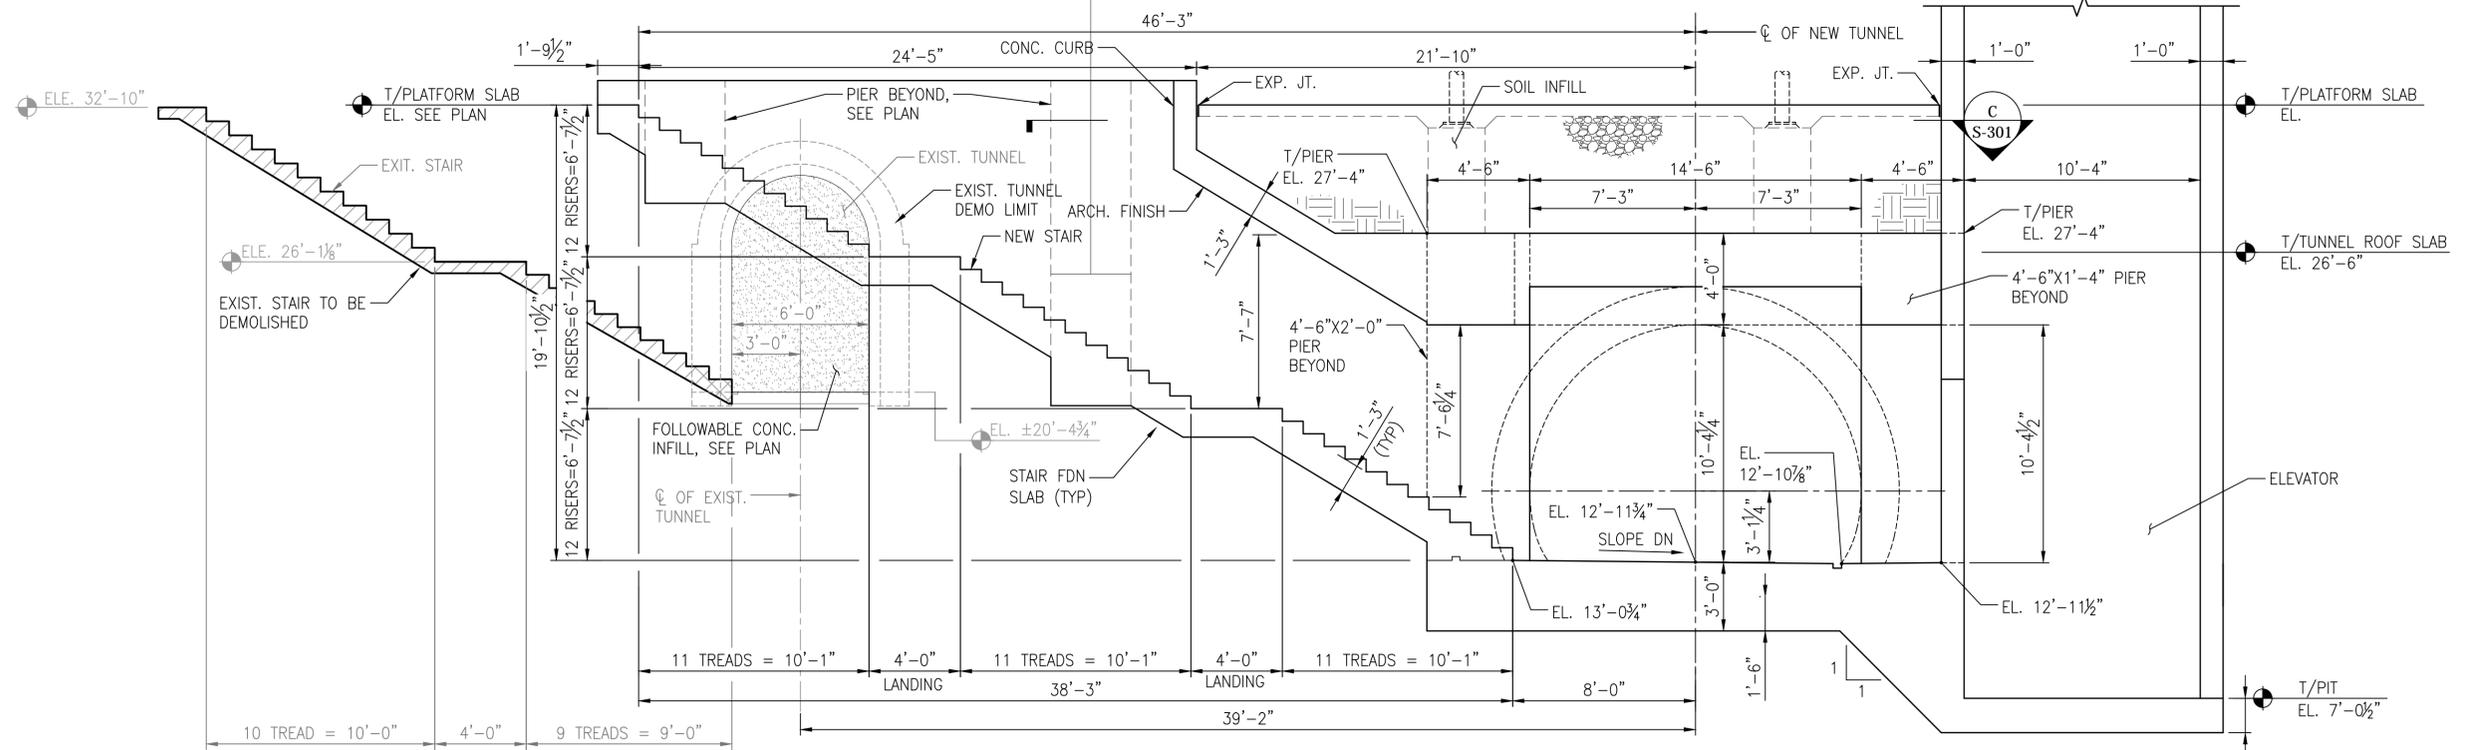


A
SECTION THRU NEW STAIR
SCALE: 1/4" = 1'-0"

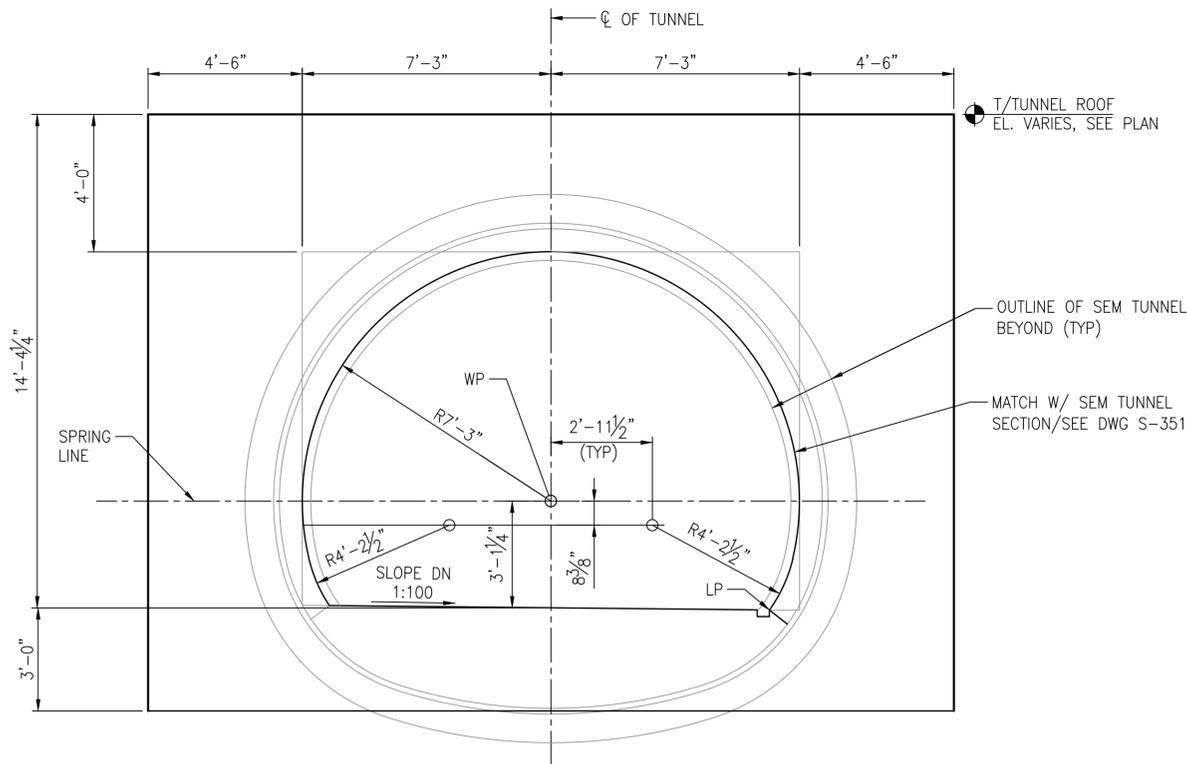

B
TUNNEL INTERFACE SECTION
SCALE: 3/8" = 1'-0"

NOTE:
1. FOR ADDITIONAL INFORMATION RELATE SEM TUNNEL, REFER TO DRAWINGS S-351 AND S-352.

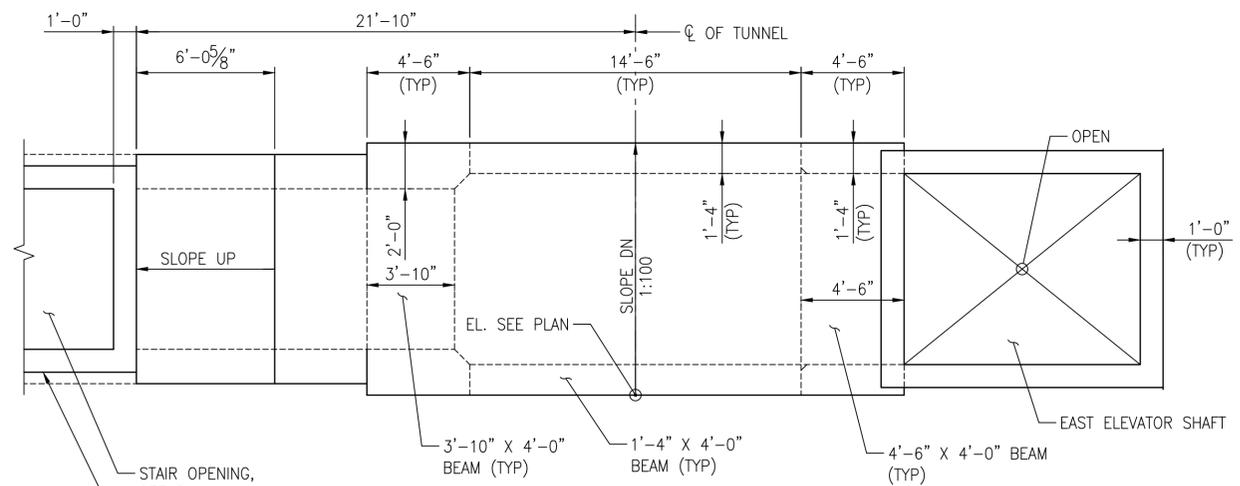

C
TUNNEL ROOF PLAN AT EAST PLATFORM
SCALE: 1/4" = 1'-0"

NOTES:
1. FOR GENERAL NOTES, REFER TO DRAWINGS S-001 TO S-004.


60% SUBMITTAL

CONTRACT NO:		REVISIONS			
PROJECT NO:		BY	NO	DATE	DESCRIPTION
DESIGNED:	IA				
DRAFTED:	LTN				
CHECKED:	MA/DB				
APPROVED:					



VIRGINIA RAILWAY EXPRESS
ALEXANDRIA
PEDESTRIAN TUNNEL

DISCIPLINE: STRUCTURAL TUNNEL SECTIONS AND DETAILS		DRAWING NO: S-301
SCALE: AS SHOWN	DATE ISSUED: 5/25/16	LIST NO:

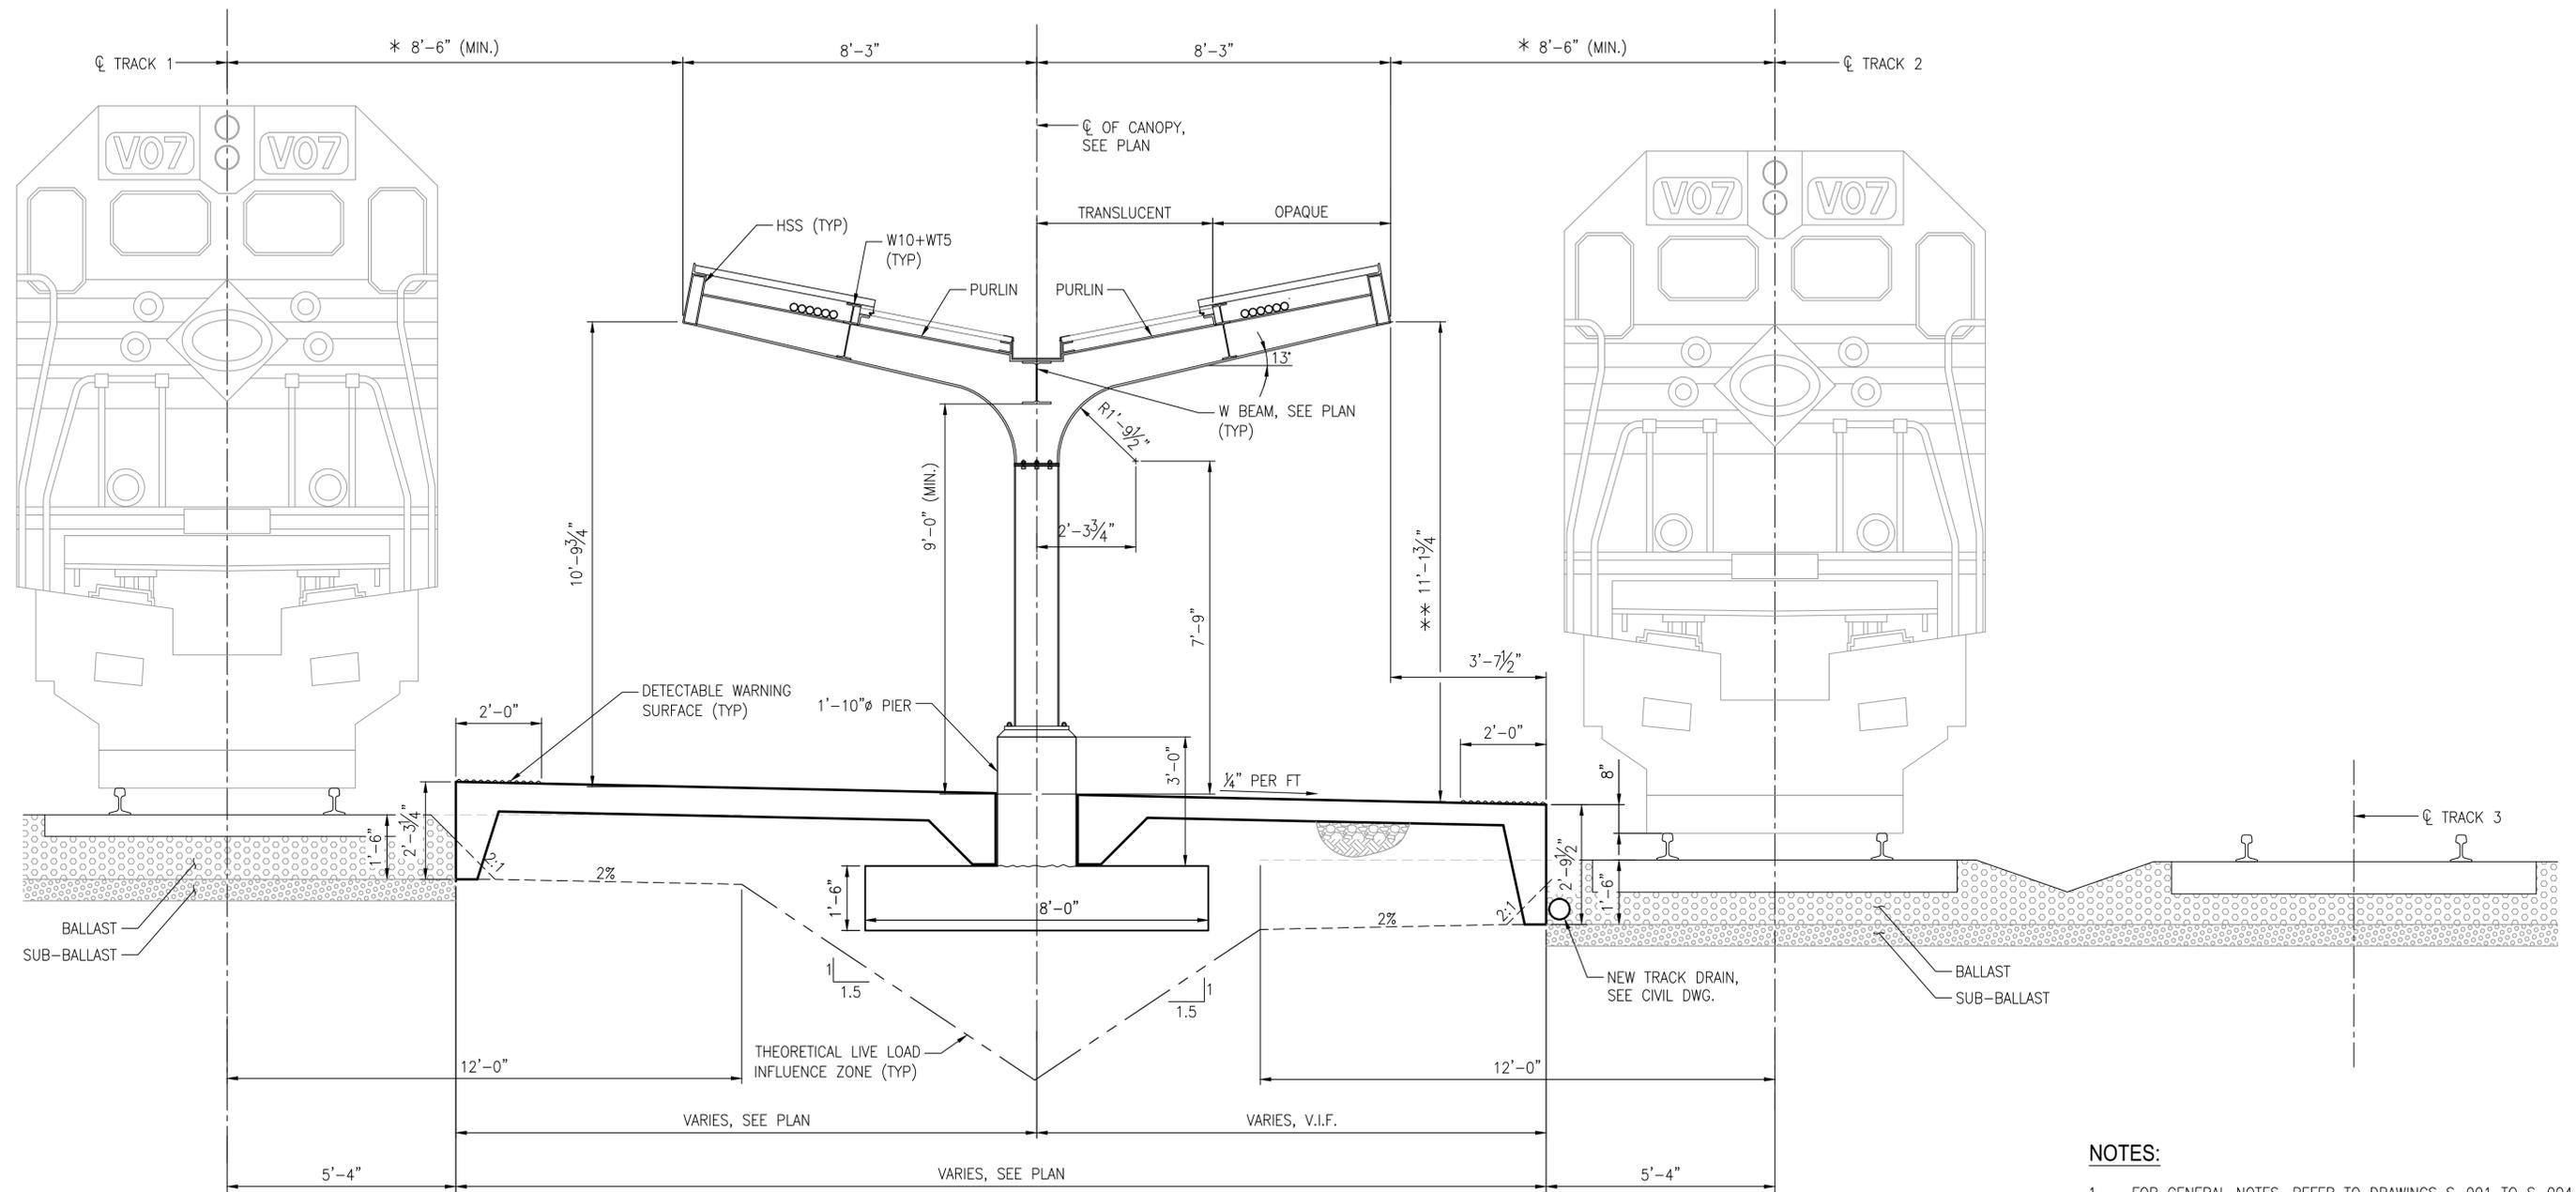

1 SECTION - INVERTED CANOPY
SCALE: 1/2" = 1'-0"

NOTES:

1. FOR GENERAL NOTES, REFER TO DRAWINGS S-001 TO S-004.
 2. * CSX MINIMUM CLEARANCE - 9'-0" MINIMUM.
VRE CLEARANCE - 7'-6" MINIMUM.
 - * * VRE CLEARANCE - 8'-0" MINIMUM.
- PLATFORM WIDTH VARIES BETWEEN 28'-4" TO 23'-9".


60% SUBMITTAL

CONTRACT NO:	REVISIONS			
PROJECT NO:	BY	NO	DATE	DESCRIPTION
DESIGNED: IA				
DRAFTED: LTN				
CHECKED: MA/DB				
APPROVED:				



VIRGINIA RAILWAY EXPRESS
ALEXANDRIA
PEDESTRIAN TUNNEL

DISCIPLINE:	DRAWING NO:
STRUCTURAL	S-303
CANOPY SECTION 1 OF 3	LIST NO:
SCALE: AS SHOWN	DATE ISSUED: 5/25/16

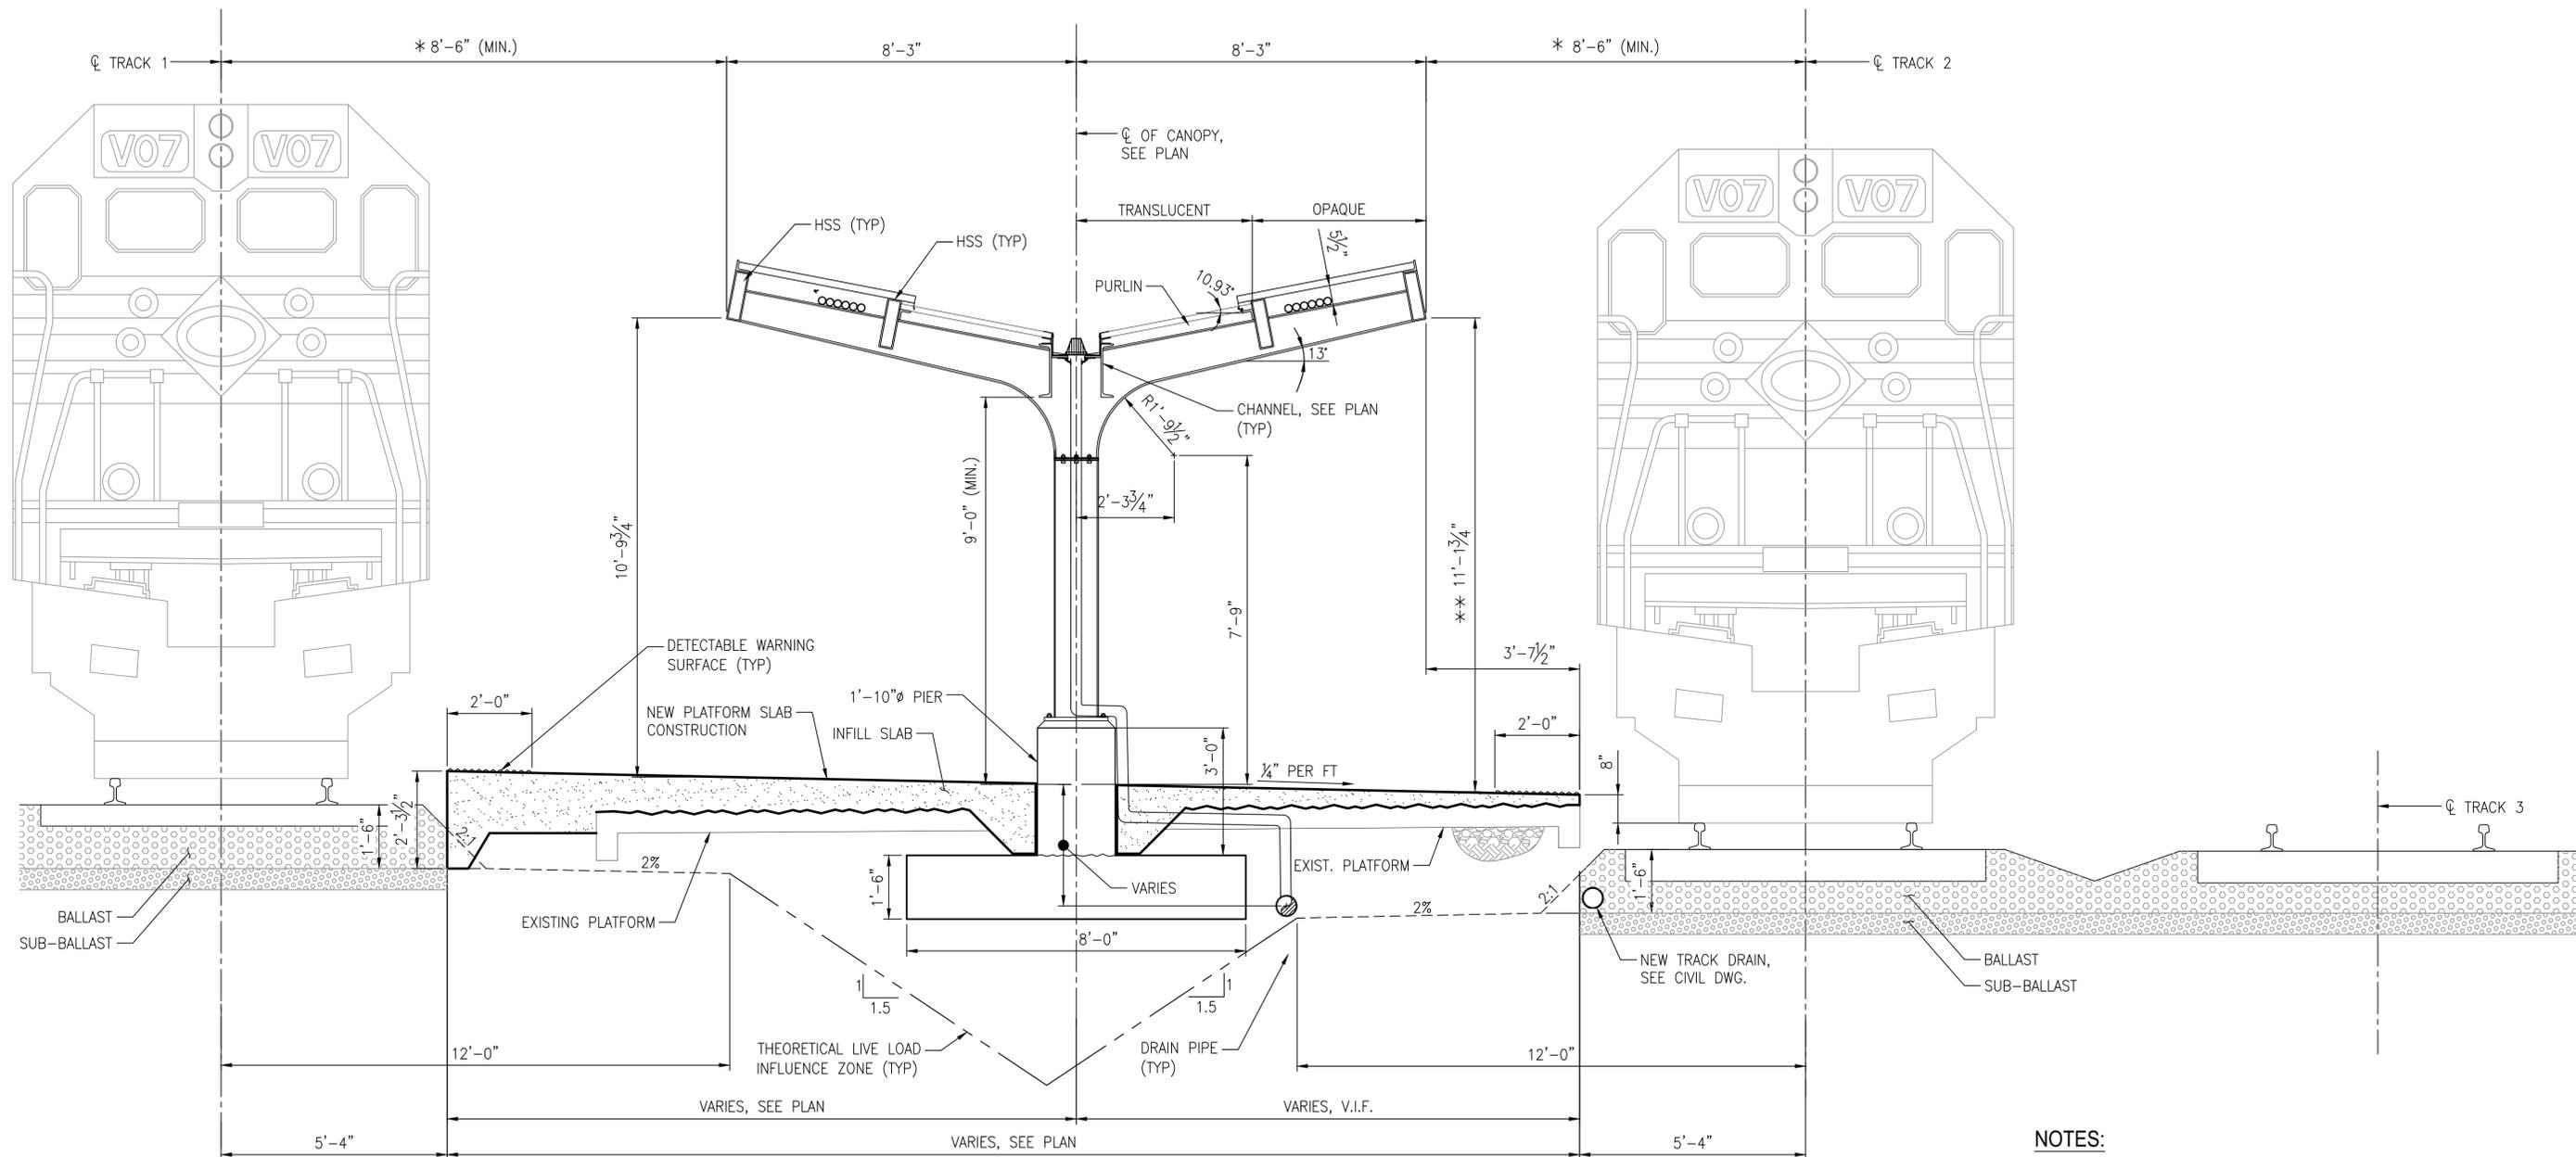

1 SECTION - INVERTED CANOPY
S-304 SCALE: 1/2" = 1'-0"

NOTES:

1. FOR GENERAL NOTES, REFER TO DRAWINGS S-001 TO S-004.
 2. * CSX MINIMUM CLEARANCE - 9'-0" MINIMUM.
VRE CLEARANCE - 7'-6" MINIMUM.
 - ** VRE CLEARANCE - 8'-0" MINIMUM.
- PLATFORM WIDTH VARIES BETWEEN 28'-4" TO 23'-9".


60% SUBMITTAL

CONTRACT NO:	REVISIONS			
PROJECT NO:	BY	NO	DATE	DESCRIPTION
DESIGNED: IA				
DRAFTED: LTN				
CHECKED: MA/DB				
APPROVED:				



VIRGINIA RAILWAY EXPRESS
ALEXANDRIA
PEDESTRIAN TUNNEL

DISCIPLINE:	DRAWING NO:
STRUCTURAL	S-304
CANOPY SECTION 2 OF 3	LIST NO:
SCALE: AS SHOWN	DATE ISSUED: 5/25/16

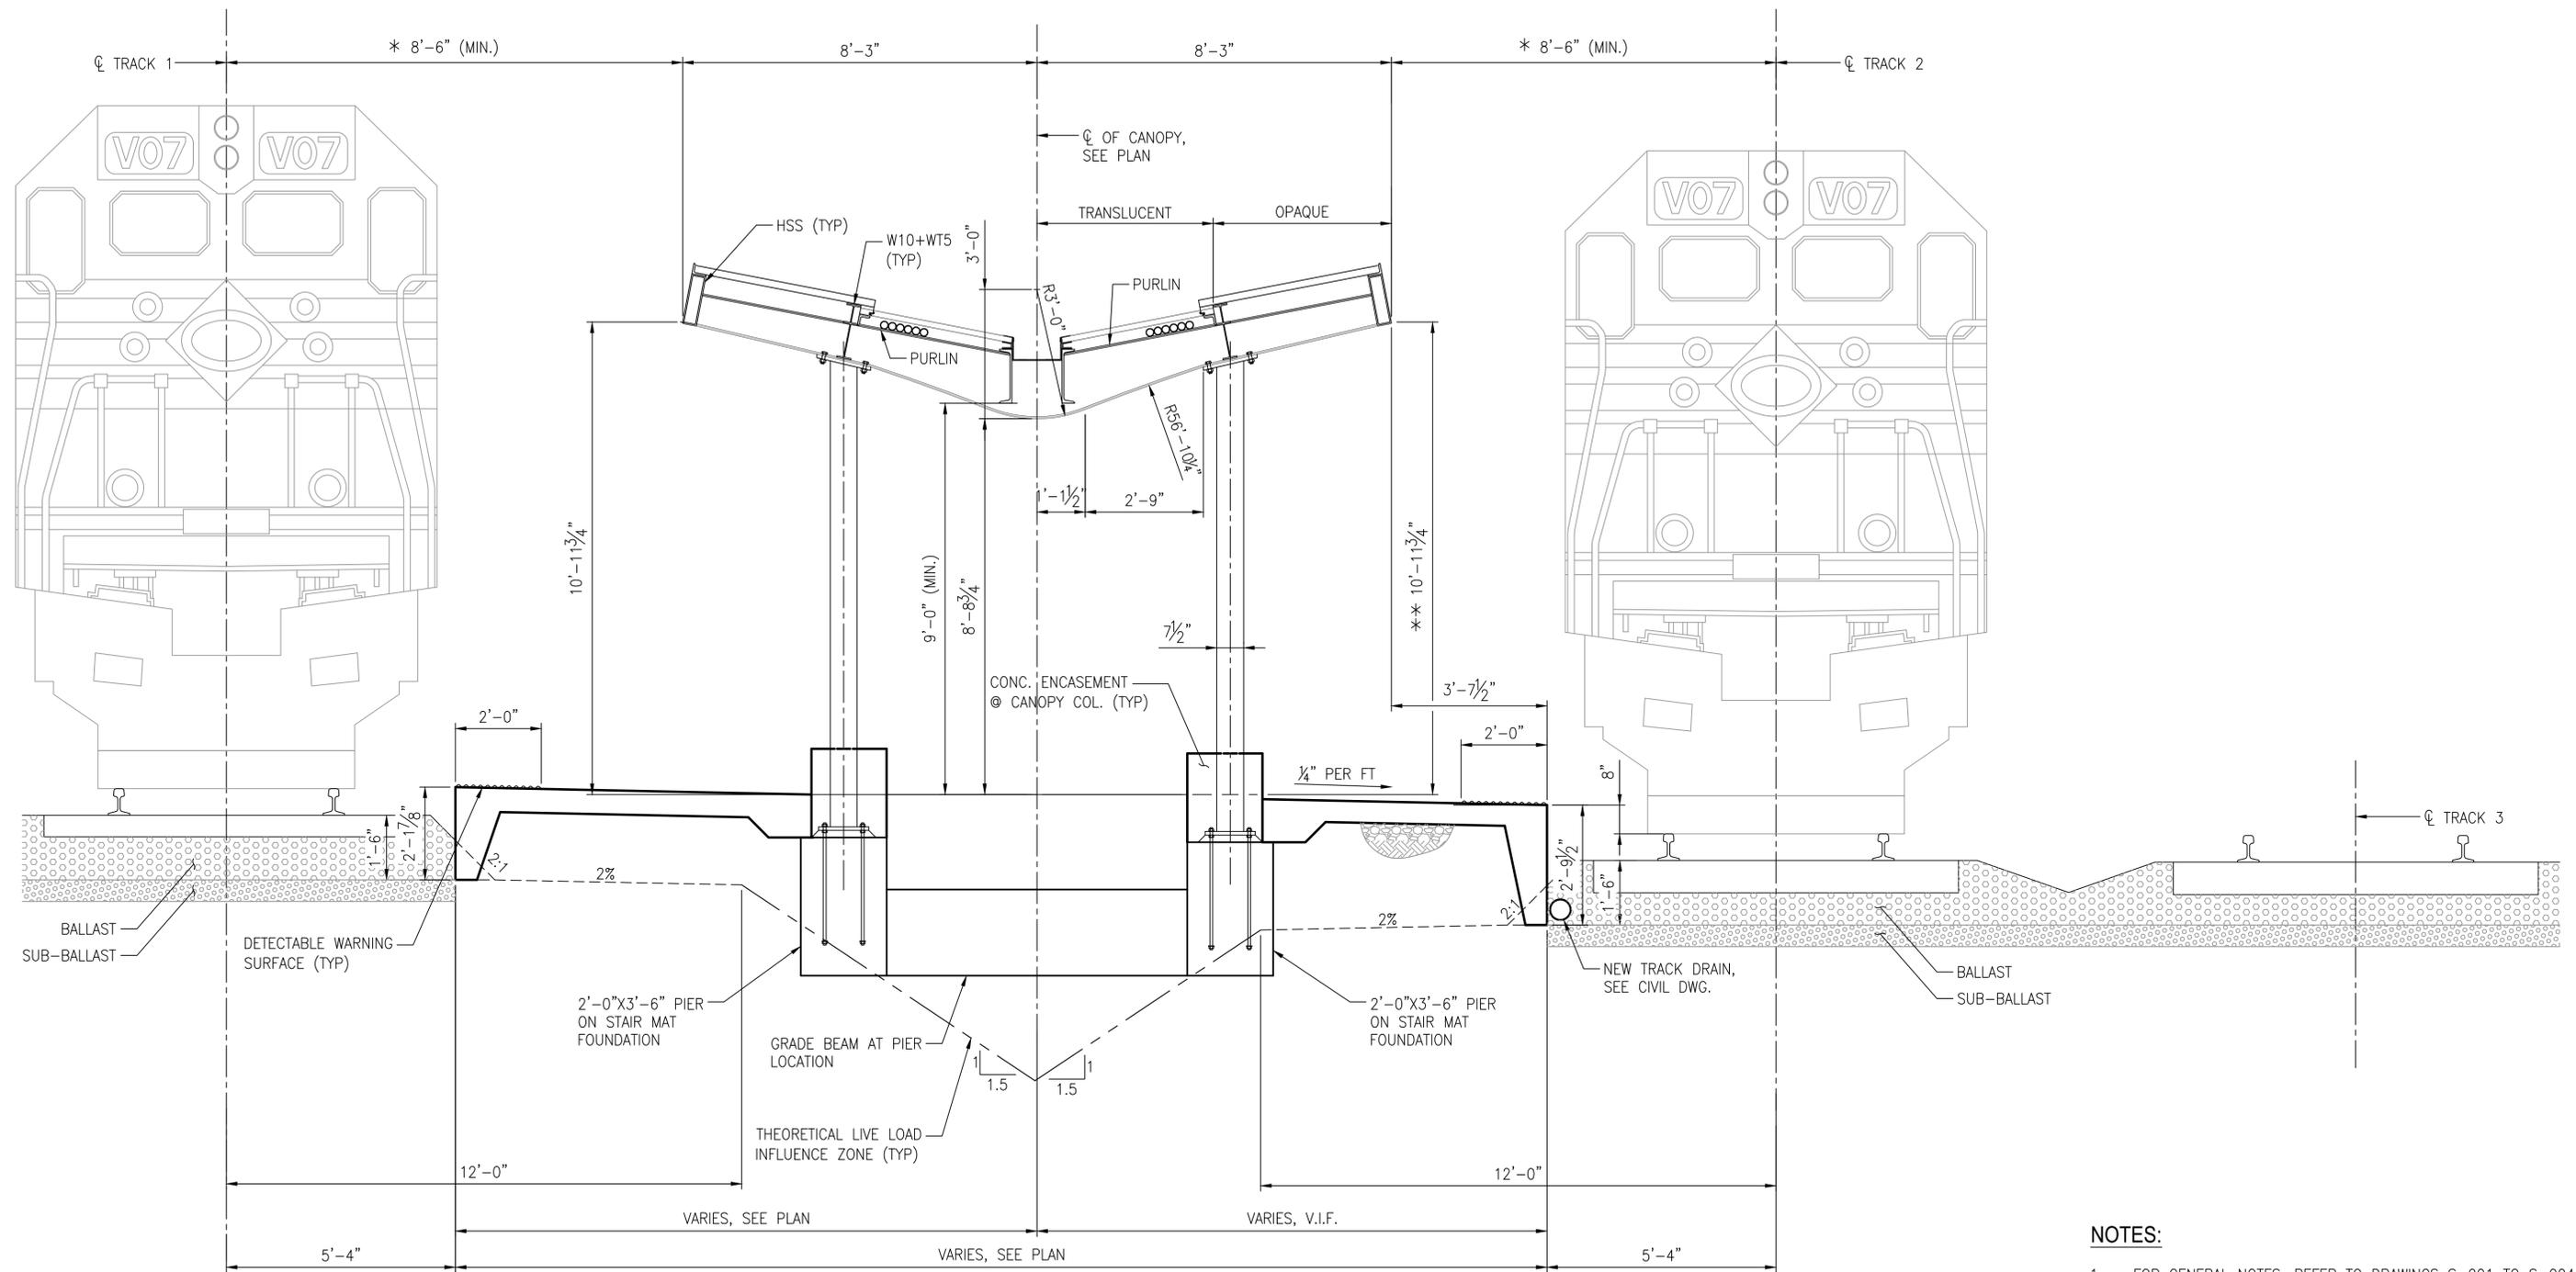

- NOTES:**
- FOR GENERAL NOTES, REFER TO DRAWINGS S-001 TO S-004.
 - * CSX MINIMUM CLEARANCE - 9'-0" MINIMUM.
VRE CLEARANCE - 7'-6" MINIMUM.
 - ** VRE CLEARANCE - 8'-0" MINIMUM.
- PLATFORM WIDTH VARIES BETWEEN 28'-4" TO 23'-9".

SECTION - INVERTED CANOPY
SCALE: 1/2" = 1'-0"


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PROJECT NO:	BY	NO	DATE	DESCRIPTION
DESIGNED: IA				
DRAFTED: LTN				
CHECKED: MA/DB				
APPROVED:				




VIRGINIA RAILWAY EXPRESS
ALEXANDRIA
PEDESTRIAN TUNNEL

DISCIPLINE:	DRAWING NO:
STRUCTURAL	S-305
CANOPY SECTION 3 OF 3	LIST NO:
SCALE: AS SHOWN	DATE ISSUED: 5/25/16

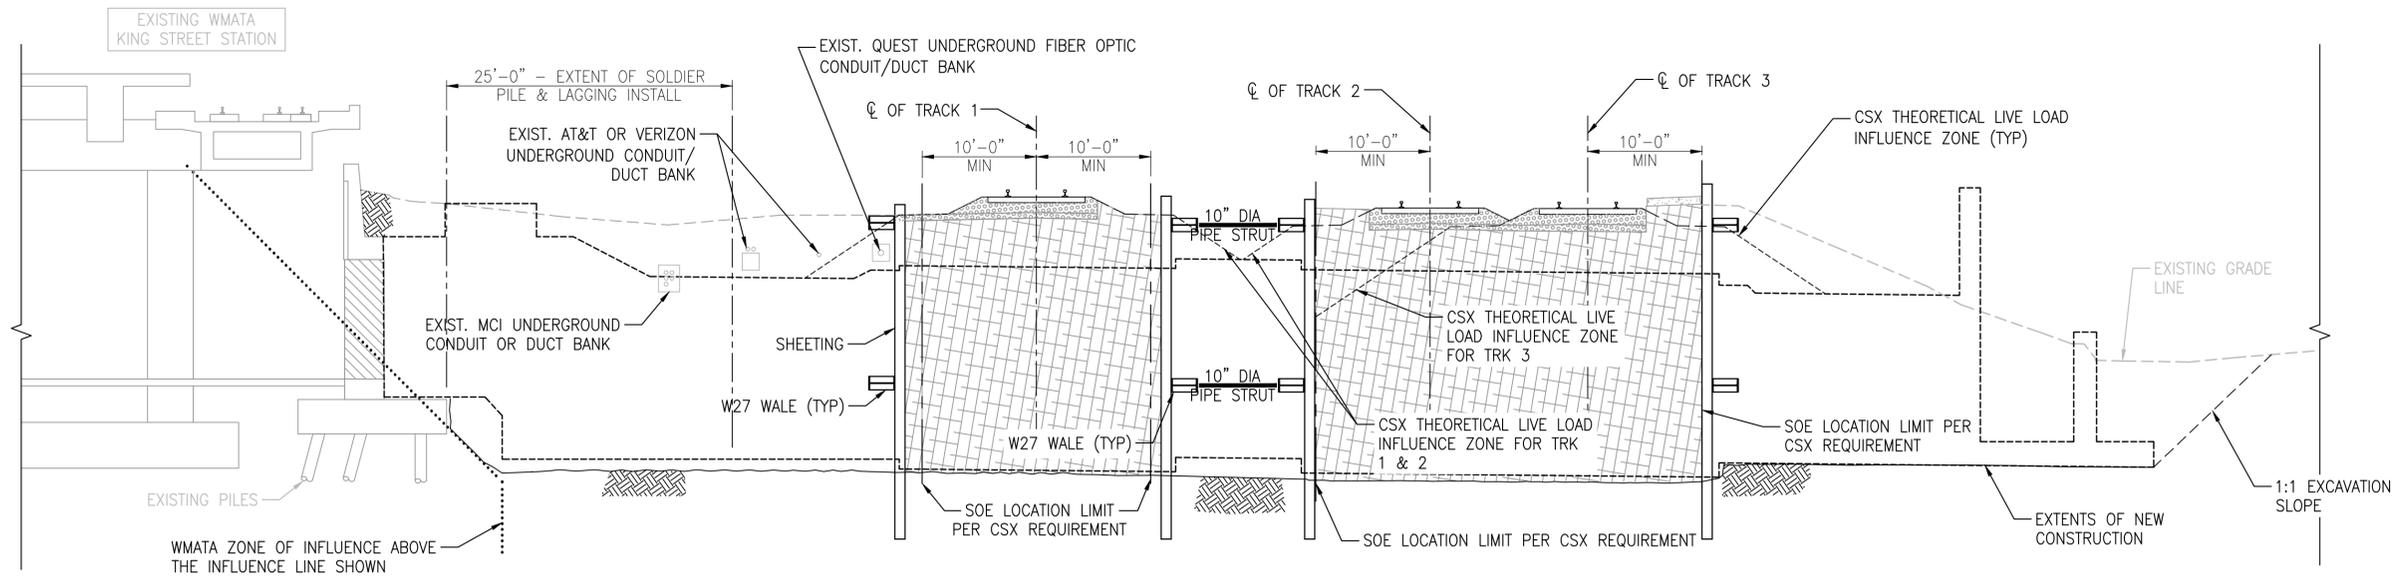

1
S-306
SUPPORT OF EXCAVATION - LONGITUDINAL SECTION
SCALE: 1/8" = 1'-0"


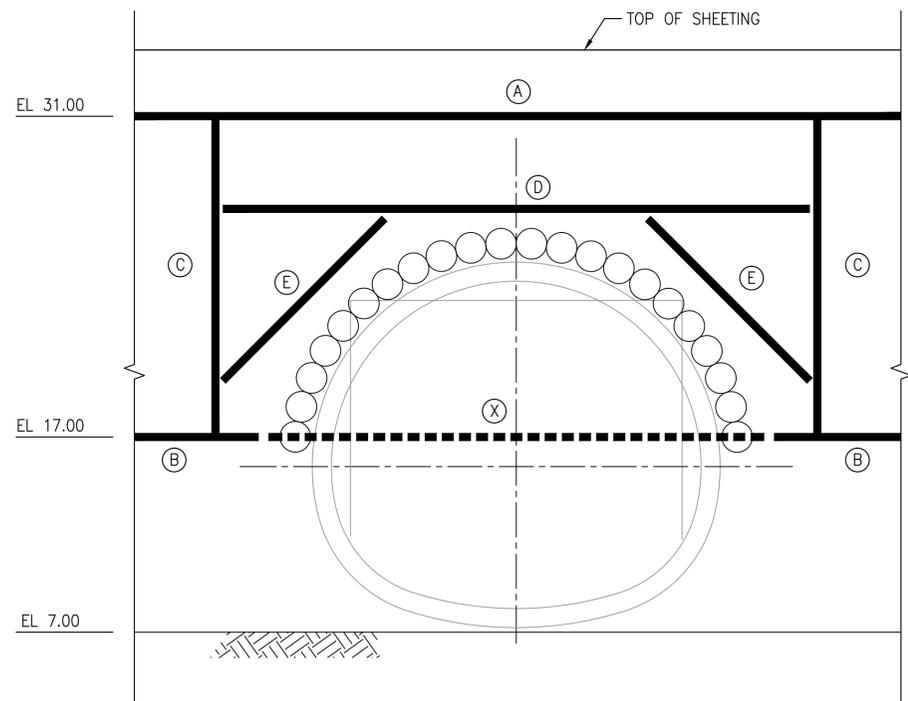


NOTE: ALL MEMBERS SHOWN ARE ASSUMED TO BE W27 SHAPES

2
S-306
TYPICAL SHEETING SUPPORT AT TUNNELS ENDS - ELEVATION VIEW
SCALE: 1/4" = 1'-0"

PROPOSED SHEETING INSTALLATION SEQUENCE AT TUNNEL ENDS

1. LOCATE AND IDENTIFY ALL UTILITIES WITHIN CONSTRUCTION ZONE. ALL EXISTING UTILITIES SHALL BE PROTECTED THROUGHOUT THE DURATION OF CONSTRUCTION.
2. DRIVE INTERLOCKING SHEETING AS SHOWN ON SHEET S-117.
3. EXCAVATE SOIL BELOW ELEVATION 31.00 AS REQUIRED TO INSTALL WALER "A" AND ALL CORRESPONDING STRUTS/BRACES AT THIS ELEVATION, AS SHOWN ON SHEET S-117.
4. EXCAVATE SOIL BELOW ELEVATION 17.00 AS REQUIRED TO INSTALL WALER "B", "X", AND ALL STRUTS/BRACES LOCATED AT THIS ELEVATION, AS SHOWN ON SHEET S-117.
5. INSTALL "C" COLUMNS BETWEEN WALERS "A" AND "B".
6. INSTALL WALER "D" AND INCLINED "E" WALERS.
7. LOCALLY CUT SHEETING FOR PIPE ARCH INSTALLATION. A MAXIMUM OF THREE SHEET PILES MAY BE CUT AT ANY GIVEN TIME FOR INSTALLATION OF AN INDIVIDUAL PIPE. THE CUTTING OF ADDITIONAL SHEET PILES MAY ONLY PROCEED AFTER PREVIOUSLY CUT SHEET PILES HAVE BEEN WELDED TO NEWLY INSTALLED PILES.
8. DRIVE SUPPORT PIPES UNDER THE TRACKS TO THE ADJACENT EXCAVATION PIT. AFTER EACH PIPE IS INSTALLED, CUT ENDS OF PIPE TO A DISTANCE OF 6" BEYOND THE FACE OF SHEETING. WELD CUT SHEET PILES ABOVE AND BELOW INSTALLED PIPE PRIOR TO PROCEEDING WITH INSTALLATION OF NEXT PIPE.
9. REPEAT STEPS 7 & 8 FOR THE INSTALLATION OF REMAINING ARCH SUPPORT PIPES UNTIL ELEVATION 17.00 IS REACHED. AT ELEVATION 17.00, WALER "X" MAY BE REMOVED BETWEEN "C" COLUMNS TO ENABLE INSTALLATION OF REMAINING PIPES. NOTE: AT ANY GIVEN POINT AFTER STEP 3, THE CONTRACTOR MAY CHOOSE TO EXCAVATE DEEPER THAN ELEVATION 17.00 TO AFFORD ADEQUATE EQUIPMENT ACCESS FOR PIPE INSTALLATION.

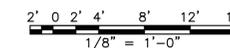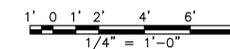


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CONTRACT NO:	REVISIONS			
PROJECT NO:	BY	NO	DATE	DESCRIPTION
DESIGNED:				
DRAFTED:				
CHECKED:				
APPROVED:				



VIRGINIA RAILWAY EXPRESS
**ALEXANDRIA
PEDESTRIAN TUNNEL**

DISCIPLINE:	DRAWING NO:
STRUCTURAL SUPPORT OF EXCAVATION SECTIONS	S-306
SCALE:	LIST NO:
DATE ISSUED:	
5/25/16	

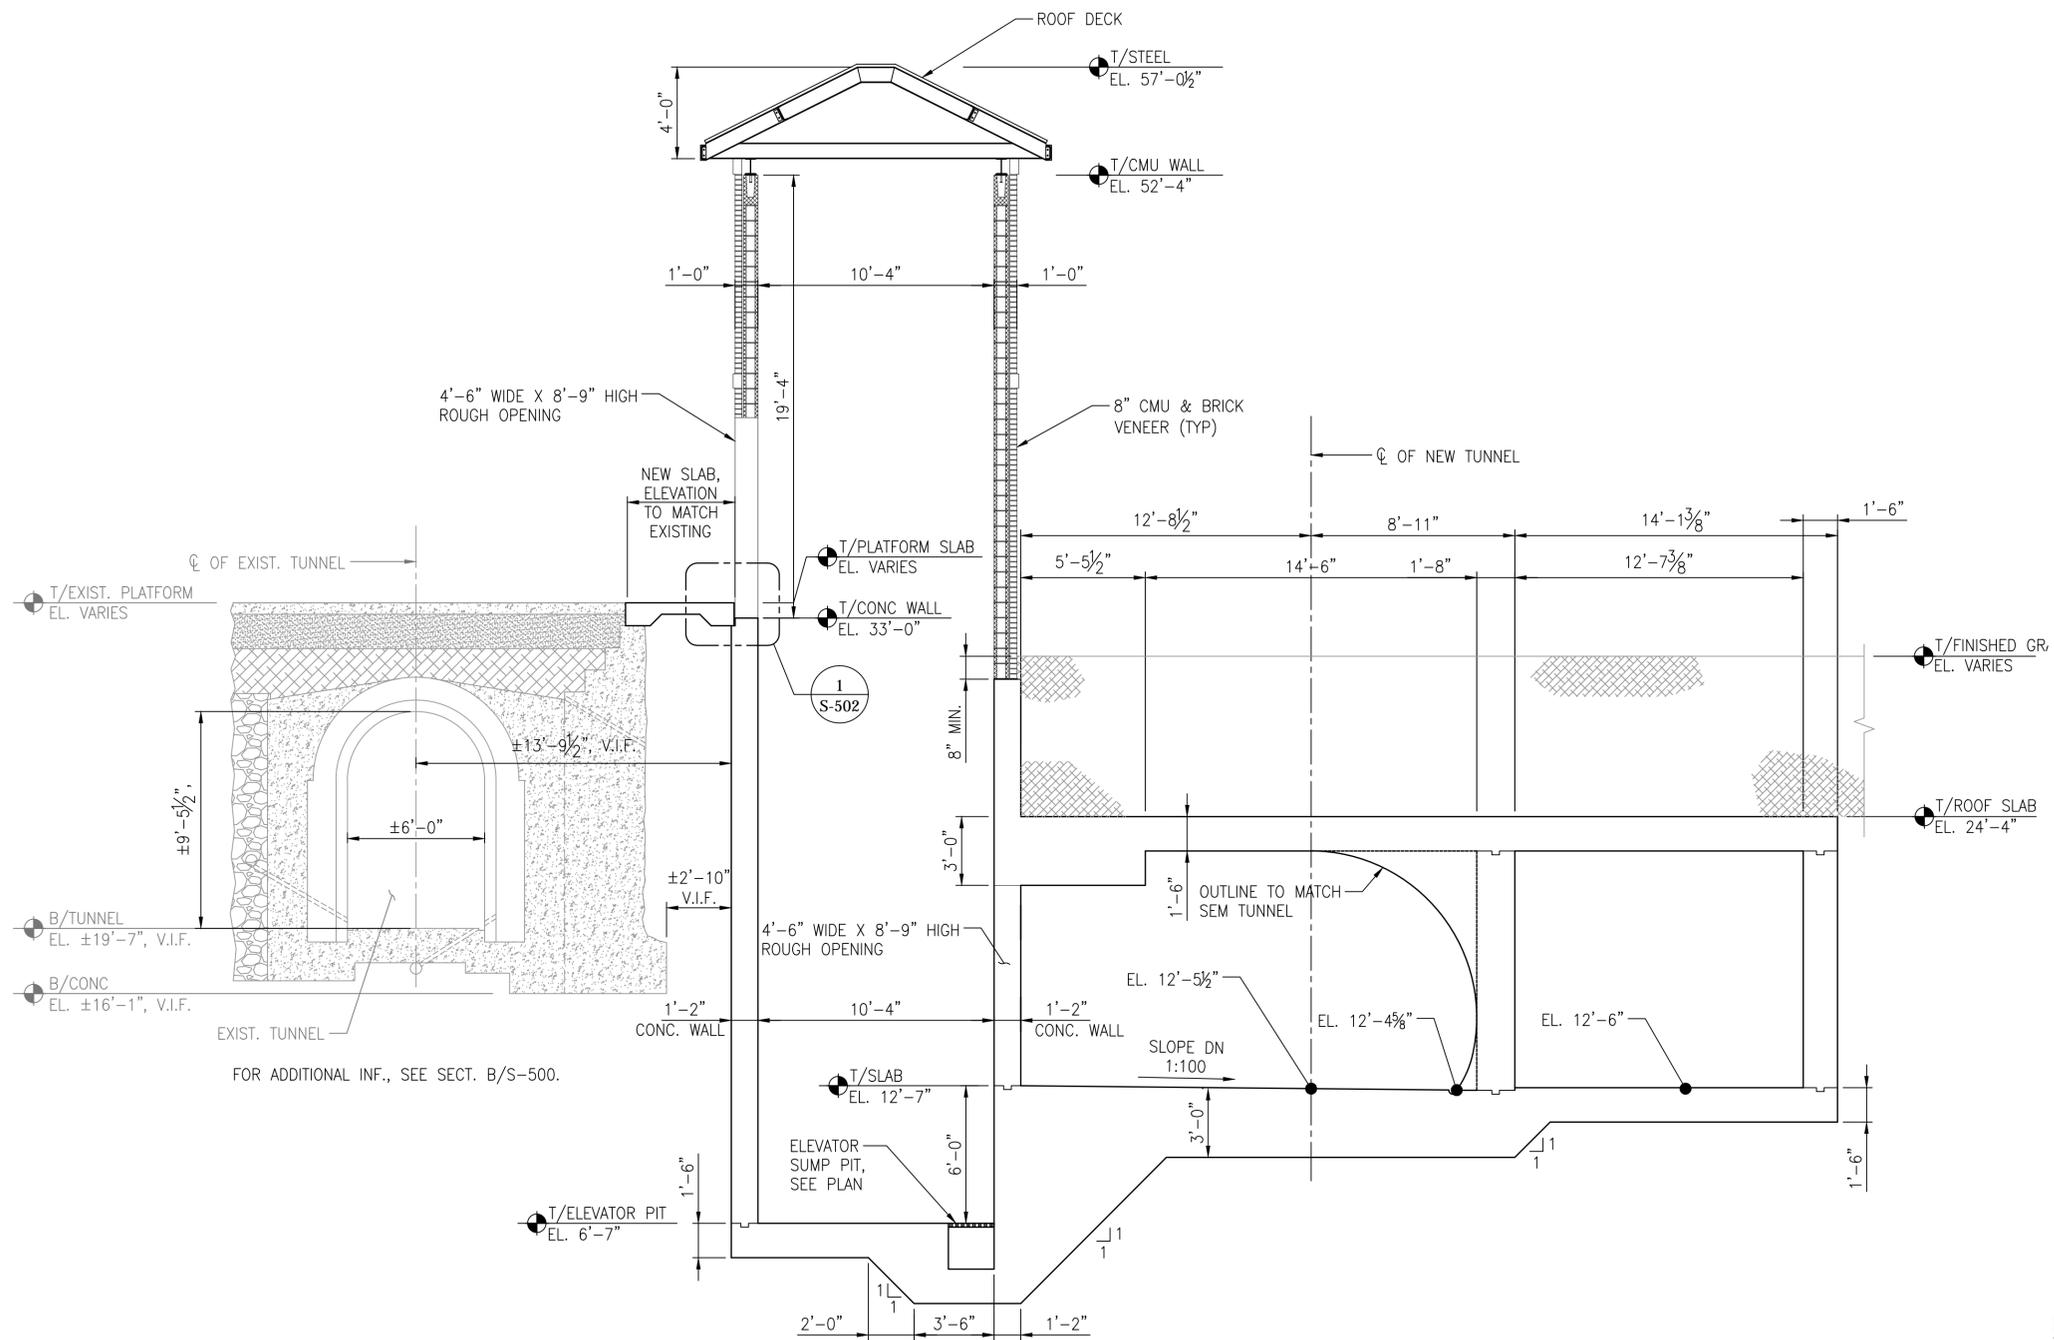

SECTION AT WEST ELEVATOR
 SCALE: 1/4" = 1'-0"

NOTES:

1. FOR GENERAL NOTES, REFER TO DRAWINGS S-001 TO S-004.
2. FOR ELEVATOR ROOF FRAMING, SEE DRAWING S-402.
FOR SUPPORT OF EXCAVATION PLAN, SEE DRAWING S-117.
3. THE (±) MARKS SHOWN WITH DIMENSION DO NOT INDICATE ANY DEGREE OF PRECISION. THESE DIMENSIONS WILL REQUIRE FIELD VERIFICATION BY THE CONTRACTOR. VERIFY EXISTING TUNNEL INVERT AND EXISTING RETAINING FOUNDATION IN THE FIELD.


60% SUBMITTAL

CONTRACT NO:		REVISIONS			
PROJECT NO:		BY	NO	DATE	DESCRIPTION
DESIGNED:	IA				
DRAFTED:	LTN				
CHECKED:	MA/DB				
APPROVED:					



VIRGINIA RAILWAY EXPRESS
 ALEXANDRIA
 PEDESTRIAN TUNNEL

DISCIPLINE:		DRAWING NO:
STRUCTURAL CUT AND COVER TUNNEL SECTIONS		S-307
SCALE:	DATE ISSUED:	LIST NO:
AS SHOWN	5/25/16	

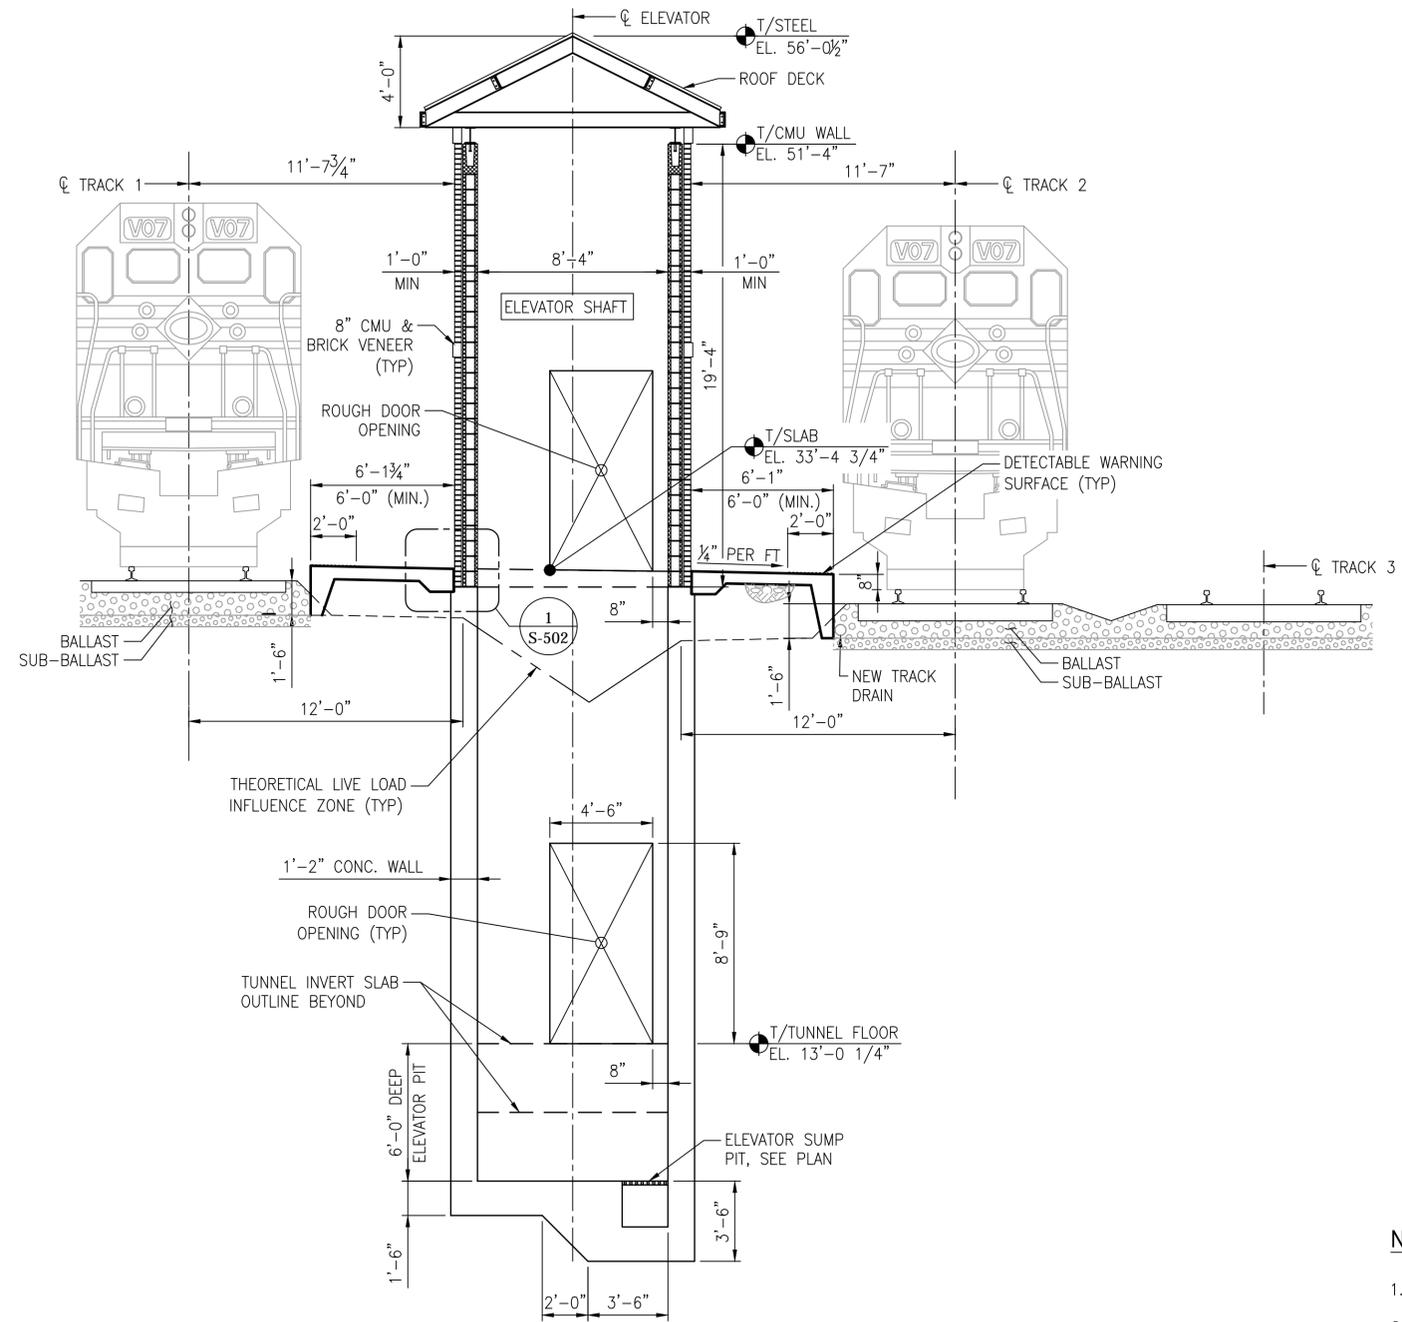

SECTION AT EAST ELEVATOR
 SCALE: 1/4" = 1'-0"

NOTES:

1. FOR GENERAL NOTES, REFER TO DRAWINGS S-001 TO S-004.
2. FOR ELEVATOR ROOF PARTIAL PLAN, SEE DRAWING S-402.
3. OUTLINE OF BRICK VENEER FACE VARIES AROUND ELEVATOR SHAFT. FOR FINISHED FACE OUTLINE OF BRICK VENEER, REFER TO ARCHITECTURAL DRAWINGS.
4. FOR LIVE LOAD INFLUENCE ZONE PROFILE, SEE DRAWING S-305.

60% SUBMITTAL

CONTRACT NO:		REVISIONS			
PROJECT NO:		BY	NO	DATE	DESCRIPTION
DESIGNED:	IA				
DRAFTED:	LTN				
CHECKED:	MA/DB				
APPROVED:					



VIRGINIA RAILWAY EXPRESS
 ALEXANDRIA
 PEDESTRIAN TUNNEL

DISCIPLINE:		DRAWING NO:
STRUCTURAL EAST PLATFORM ELEVATOR SECTION		S-308
SCALE:	DATE ISSUED:	LIST NO:
AS SHOWN	5/25/16	

GENERAL NOTES

- NOT ALL SYMBOLS DEPICTED ON THIS DRAWING ARE USED IN THE ARCHITECTURAL DRAWINGS.
- ALL WORK TO CONFORM TO REQUIREMENTS OF THE GOVERNING BUILDING CODE, OSHA AND ALL OTHER APPLICABLE CODES, RULES, REGULATIONS, ORDINANCES, ETC. IN THEIR LATEST EDITION. ALL WORK SHALL CONFORM TO REQUIREMENTS OF ALL AUTHORITIES HAVING JURISDICTION.
- ALL WORK THAT IS IMPLIED OR REASONABLY INFERRED BY THE DRAWINGS IS THE RESPONSIBILITY OF THE CONTRACTOR. THE CONTRACTOR'S ATTENTION IS DIRECTED TO INCLUDE ALL DRAWINGS COMPRISING THE COMPLETE SET. THE INCLUSION OF ANY AND ALL WORK BY MENTION, NOTATION, DETAIL, ITEMIZATION OR IMPLICATION, HOWEVER BRIEF, MEANS THAT THE CONTRACTOR SHALL PROVIDE AND INSTALL SAME AT NO ADDITIONAL COST OR BURDEN TO THE OWNER. ALL WORK PERFORMED SHALL INCLUDE ALL APPURTENANCES AND APPARATUS NORMALLY DEEMED TO BE PART OF A COMPLETE PACKAGE WITHIN THE DEFINITIONS OF ORDINARY INDUSTRY STANDARDS. ALL TRADES ARE RESPONSIBLE FOR REVIEWING THE ENTIRE SET OF DRAWINGS THEREBY NOTING AND INCLUDING THEIR WORK AS APPLICABLE. THE INTENT OF THE DRAWING SET IS TO RESULT IN A COMPLETE AND FINISHED PROJECT IN ALL REGARDS AT THE CONCLUSION OF THE WORK. CONTRACTOR TO INCLUDE ALL WORK, WHETHER SHOWN OR NOT, AS MAY BE NECESSARY TO ACCOMPLISH THE INTENDED RESULT.
- ALL PERMITS, INSPECTIONS, APPROVALS, ETC. SHALL BE APPLIED AND PAID FOR BY THE CONTRACTOR. CONTRACTOR SHALL BE RESPONSIBLE FOR THE ARRANGING AND COORDINATING ALL REQUIRED INSPECTIONS AND FOR SECURING ALL NECESSARY APPROVALS OF THE WORK.
- CONTRACTOR SHALL FAMILIARIZE THEMSELV WITH THE PROJECT THROUGH INSPECTION OF THE SITE AND REVIEW OF THE DRAWINGS SO AS TO THOROUGHLY UNDERSTAND THE NATURE AND REQUIREMENTS OF THE WORK. ANY AND ALL DISCREPANCIES OR OMISSIONS SHALL BE REPORTED TO THE OWNER PRIOR TO THE COMMENCEMENT OF ANY WORK AFFECTED BY SUCH DISCREPANCY OR OMISSION. IT IS THE RESPONSIBILITY OF THE CONTRACTOR TO ENSURE THAT DISCREPANCIES OR OMISSIONS ARE REPORTED AND CLARIFICATION OBTAINED PRIOR TO WORK BEING PERFORMED. ANY AND ALL WORK PROCEEDING OTHERWISE AND THEN FOUND TO BE INCORRECT OR INCONSISTENT WITH THE INTENDED RESULT SHALL BE REMOVED, REPLACED AND/OR CORRECTED BY THE CONTRACTOR AT NO ADDITIONAL COST OR BURDEN TO THE OWNER. CONTRACTOR TO VERIFY ALL DIMENSIONS AND LOCATIONS IN THE FIELD. CONTRACTOR TO COORDINATE ALL WORK WITH CONDITIONS ENCOUNTERED IN THE FIELD AND MAKE ALL NECESSARY ADJUSTMENTS ACCORDINGLY.
- CONTRACTOR IS RESPONSIBLE FOR FINAL FIT, FINISH, APPEARANCE AND PERFORMANCE OF ALL WORK.
- CONTRACTOR SHALL VERIFY ALL DIMENSIONS AND CONDITIONS AT THE WORK SITE PRIOR TO THE COMMENCEMENT OF WORK.
- CONTRACTOR SHALL VERIFY EXISTING CONDITIONS AFFECTING THE WORK PRIOR TO BIDDING AND SHALL FAMILIARIZE HIMSELF WITH ALL ASPECTS OF THE WORK PRIOR TO COMMENCEMENT.
- ALL MATERIALS SHALL BE APPLIED, INSTALLED OR UTILIZED IN ACCORDANCE WITH MANUFACTURER'S PRINTED LITERATURE.
- ALL WORK SHALL BE PROPERLY AND ADEQUATELY PROTECTED FROM DAMAGE AT ALL TIMES REGARDLESS OF THE STAGE OF COMPLETION. CONTRACTOR SOLELY RESPONSIBLE FOR SAFETY AT ALL TIMES, IN ALL PLACES AND UNDER ALL CONDITIONS AFFECTING OR AFFECTED BY THE WORK. CONTRACTOR SHALL ADHERE TO ALL ACCEPTED SAFETY PRACTICES AND SHALL PROVIDE ALL FENCES, BARRICADES, GUARDRAILS, PARTITIONS, ETC. AS MAY BE NECESSARY IN ORDER TO PROTECT LIFE AND PROPERTY FROM INJURY OR DAMAGE AND AS MAY BE REQUIRED BY ANY AND ALL AUTHORITIES HAVING JURISDICTION. CONTRACTOR SHALL REPAIR ANY AND ALL DAMAGE TO THE PREMISES ARISING FROM OR ASSOCIATED WITH WORK SITE OPERATIONS AND/OR ACTIVITIES CONNECTED TO THE WORK.
- CONTRACTOR TO PERFORM ALL WORK WITHOUT INTERFERING WITH OWNER'S NORMAL OPERATIONS.
- DO NOT SCALE DRAWINGS FOR CONSTRUCTION PURPOSES.
- ALL INTERIOR DOORS ARE 4" FROM FACE OF THE CLOSEST PERPENDICULAR WALL UNLESS NOTED OTHERWISE.

SYMBOLS LEGEND

-  - DOOR NUMBER REFERENCE
-  - ROOM NAME
-  - ROOM NUMBER REFERENCE
-  - LINTEL TYPE REFERENCE
-  - DEMOLITION NOTE REFERENCE
-  - DETAIL REFERENCE
-  - FIRST DRAWING ON WHICH DETAIL APPEARS
-  - SECTION/DETAIL DRAWING TITLE REFERENCE
-  - FIRST DRAWING ON WHICH DRAWING APPEARS
-  - 1 HR FIRE RATED PARTITION
-  - WALL TYPE
-  - COLUMN REFERENCE
-  - MULTIPLE INTERIOR ELEVATION REFERENCE
-  - DRAWING ON WHICH ELEVATION APPEARS
-  - SINGLE INTERIOR ELEVATION REFERENCE
-  - DRAWING ON WHICH ELEVATION APPEARS
-  - NEW FIRE EXTINGUISHER AND CABINET
-  - LARGE SCALE PLAN REFERENCE

ARCHITECTURAL ABBREVIATIONS

ABV	ABOVE	DPM	DEMOUNTABLE PARTITION	LAB	LABORATORY	REQD	REQUIRED
AC	AIR CONDITIONER		MANUFACTURER	LAM	LAMINATE	RET	RETURN
ACST	ACOUSTIC	DR	DOOR	LAV	LAVATORY	REV	REVISION
ADDL	ADDITIONAL	DS	DOWNSPOUT	LG	LENGTH	REG	REGISTER
ADJ	ADJACENT	DW	DISHWASHER	LH	LEFT HAND	RFG	ROOFING
AFF	ABOVE FINISH FLOOR	DWG	DRAWING	LIB	LIBRARY	RH	RIGHT HAND
AGGR	AGGREGATE	E	EAST	LIN	LINEAR	RM	ROOM
AL	ALUMINUM	EA	EACH	LL	LIVE LOAD	RWC	RAIN WATER CONDUCTOR
ALT	ALTERNATE	EGEN	EMERGENCY GENERATOR	LLH	LONG LEG HORIZONTAL	S	SOUTH
ARCH	ARCHITECTURAL	EF	EXHAUST FAN	LLV	LONG LEG VERTICAL	SAPC	SUSPENDED ACOUSTICAL PANEL CEILING
ASB	ASBESTOS	EIFS	EXTERIOR INSULATION & FINISH SYSTEM	LPT	LOW POINT	SCHED	SCHEDULE
ASPH	ASPHALT			LT	LIGHT	SDG	SIDING
ASPHRS	ASPHALT ROOF SHINGLES	EL	ELEVATION	LWC	LIGHTWEIGHT CONCRETE	SEC	SECTION
ASSN	ASSOCIATION	ELEC	ELECTRICAL	MAINT	MAINTENANCE	SF	SQUARE FOOT
ASST	ASSISTANT	ELEV	ELEVATOR	MAS	MASONRY	SGFT	STRUCTURAL GLAZED FACING TILE
ASSY	ASSEMBLY	ENTR	ENTRANCE	MATL	MATERIAL	SH	SHOWER
AVE	AVENUE	EQ	EQUAL	MAX	MAXIMUM	SHM	SECURITY HOLLOW METAL SHEET
AVG	AVERAGE	EQUIP	EQUIPMENT	MECH	MECHANICAL	SHT	SHEET
B	BOTTOM	EWC	ELECTRIC WATER COOLER	MEMB	MEMBRANE	SI	INTERNATIONAL SYSTEM OF UNITS
BALC	BALCONY	EXH	EXHAUST	MEZZ	MEZZANINE	SIM	SIMILAR
BD	BOARD	EXIST	EXISTING	MFR	MANUFACTURER	SKY	SKYLIGHT
BETW	BETWEEN	EXP	EXPANSION	MGR	MANAGER	SLDR	SLIDING DOOR
BLDG	BUILDING	EXP JT	EXPANSION JOINT	MH	MANHOLE	SOG	SLAB ON GRADE
BLKG	BLOCKING	EXP STR	EXPOSED STRUCTURE	MIL	MILITARY	SMLS	SEAMLESS
BLR	BOILER	EXT	EXTERIOR	MIN	MINIMUM	SPEC	SPECIFICATION
BM	BEAM	FAB	FABRICATE	MISC	MISCELLANEOUS	SPKLR	SPRINKLER
BMK	BENCHMARK	FBD	FIBERBOARD	MISL	METAL LATH	SPKR	SPEAKER
BP	BASE PLATE	FD	FLOOR DRAIN	MTL	METAL	SQ	SQUARE
BRDG	BRIDGING	FDN	FOUNDATION	MLDG	MOLDING	SS	STAINLESS STEEL
BRG	BEARING	FDR	FIRE DOOR	MLCB	MUSIC LINE CHALK BOARD	STD	STANDARD
BS	BOTH SIDES	FE	FIRE EXTINGUISHER	MO	MASONRY OPENING	STL	STEEL
BSMT	BASEMENT	FEC	FIRE EXTINGUISHER & CABINET	MR	MOISTURE RESISTANT	STOR	STORAGE
CAB	CABINET			MTG	MOUNTING	STRUCT	STRUCTURE/STRUCTURAL
CAP	CAPACITY	FHY	FIRE HYDRANT	N	NORTH	STWY	STAIRWAY
CARP	CARPET	FIN	FINISH	NA	NOT APPLICABLE	SUPT	SUPERINTENDENT
CB	CHALK BOARD	FL	FLASHING	NIC	NOT IN CONTRACT	SUPVR	SUPERVISOR
CER	CERAMIC	FLX	FLEXIBLE	NO	NUMBER	SURF	SURFACE
CER TILE	CERAMIC TILE	FLG	FLANGE	NRC	NOISE-REDUCTION COEFFICIENT	SUSP	SUSPENDED/SUSPENSION SYSTEM
CI	CAST IRON	FLR	FLOOR	NTS	NOT TO SCALE	T	TREAD
CIP	CAST-IRON PIPE	FLRG	FLOORING	OA	OVERALL	T/	TOP OF
CJ	CONTROL JOINT	FP	FIREPROOF	OC	ON CENTER	T&B	TOP AND BOTTOM
CL	CENTERLINE	FRP	FIBERGLASS-REINFORCED PLASTICS	OD	OUTSIDE DIAMETER	TB	TACK BOARD
CLG	CEILING	FR	FIRE RATED	OFF	OFFICE	TAN	TANGENT
CLO	CLOSET	FT	FOOT	OH	OPPOSITE HAND	TDD	TELECOMMUNICATION DISPLAY DEVICE
CLR	CLEAR	FTG	FOOTING	OHDR	OVERHEAD DOOR	TEL	TELEPHONE
CMU	CONCRETE MASONRY INSULATED UNIT	FURN	FURNITURE	OPNG	OPENING	TEMP	TEMPORARY
CMU	CONCRETE MASONRY UNIT	GA	GAUGE	OPP	OPPOSITE	TER	TERRAZZO
CNCL	CONCEALED	GALV	GALVANIZED	OSB	ORIENTED STRAND BOARD	T&G	TONGUE AND GROOVE
CO	CLEANOUT	GAR	GARAGE	P/L	PROPERTY LINE	THRU	THROUGH
COL	COLUMN	GEN	GENERATOR	PASS	PASSENGER	TLT	TOILET
COMP	COMPOSITION	GL	GLASS	PERF	PERFORATED	TRTD	TREATED
CONC	CONCRETE	GLU-LAM	GLUE-LAMINATED	PL	PLATE	TYP	TYPICAL
CONSTR	CONSTRUCTION	GOVT	GOVERNMENT	PLAS	PLASTER	UNO	UNLESS NOTED OTHERWISE
CONT	CONTINUOUS	GR	GRADE	PLBG	PLUMBING	VAT	VINYL ASBESTOS TILE
CONTR	CONTRACTOR	GRD	GROUND	PLYWD	PLYWOOD	VCT	VINYL COMPOSITION TILE
CRV	CURVED	GVL	GRAVEL	PNL	PANEL	VERT	VERTICAL
CSK	COUNTERSINK	GWB	GYP SUM WALLBOARD	PNT	PAINT	VIF	VERIFY IN FIELD
CTD	COATED	GYP	GYP SUM	PORC	PORCELAIN	VTR	VENT THRU ROOF
CTR	CENTER	H	HIGH	PR	PAIR	W	WIDE
CUH	CABINET UNIT HEATER	HDWE	HARDWARE	PREFAB	PREFABRICATED	W/	WITH
D	DEPTH	HM	HOLLOW METAL	PROJ	PROJECT	W/O	WITHOUT
DBL	DOUBLE	HMD	HOLLOW METAL DOOR	PSF	POUNDS PER SQUARE FOOT	WBD	WALLBOARD
DEG	DEGREE	HORIZ	HORIZONTAL	PSI	POUNDS PER SQUARE INCH	WC	WATER CLOSET
DEPT	DEPARTMENT	HPT	HIGH POINT	PT	POINT	WD	WOOD
DET	DETAIL	HT	HEIGHT	PTD	PAINTED	WDR	WOOD DOOR
DGL	DIAGONAL	HTR	HEATER	PTN	PARTITION	WH	WATER HEATER
DIA	DIAMETER	HVAC	HEATING, VENTILATING, & AIR CONDITIONING	PVC	POLYVINYL CHLORIDE	WTRPRF	WATERPROOFING
DIM	DIMENSION	ID	INSIDE DIAMETER	QTF	QUARRY-TILE FLOOR	WWF	WELDED WIRE FABRIC
DIV	DIVISION	IE	THAT IS	R	RISER	XFMR	TRANSFORMER
DL	DEAD LOAD	IH	INTAKE HOOD	RAD	RADIUS		
DMPF	DAMP PROOFING	INSUL	INSULATION	RD	ROOF DRAIN		
DN	DOWN	INTR	INTERIOR	REFR	REFRIGERATOR		
		JST	JOIST	REIN	REINFORCE		
		JT	JOINT				

MATERIALS LEGEND

	BRICK		STEEL
	CMU		ALUMINUM
	ACOUSTICAL CMU		FINISH LUMBER
	CMU		DIMENSIONAL LUMBER
	SGFT / GLAZED CMU		SHIM
	CONCRETE		PLYWOOD
	GYP BD / GROUT		ACOUSTICAL PANEL
	BATT INSULATION		TILE
	RIGID INSULATION		EARTH
	COARSE AGGREGATE /BALLAST		

60% SUBMITTAL

CONTRACT NO: PROJECT NO: DATE:	<table border="1" style="width: 100%; border-collapse: collapse;"> <thead> <tr> <th colspan="4">REVISIONS</th> </tr> <tr> <th>BY</th> <th>NO</th> <th>DATE</th> <th>DESCRIPTION</th> </tr> </thead> <tbody> <tr><td> </td><td> </td><td> </td><td> </td></tr> </tbody> </table>	REVISIONS				BY	NO	DATE	DESCRIPTION																			VIRGINIA RAILWAY EXPRESS ALEXANDRIA PEDESTRIAN TUNNEL	DISCIPLINE: ARCHITECTURAL GENERAL NOTES, LEGENDS AND ABBREVIATIONS SCALE: NONE DATE ISSUED: 5/25/16	DRAWING NO: A-001 LIST NO:
REVISIONS																														
BY	NO	DATE	DESCRIPTION																											

CODE INFORMATION:

1. APPLICABLE CODES

BUILDING CODE: 2012 VIRGINIA UNIFORM CONSTRUCTION CODE
 PLUMBING CODE: 2012 INTERNATIONAL PLUMBING CODE
 ELECTRICAL CODE: 2011 NATIONAL ELECTRICAL CODE (NFPA 70)
 MECHANICAL CODE: 2012 INTERNATIONAL MECHANICAL CODE
 ENERGY SUBCODE: 2012 INTERNATIONAL ENERGY CONSERVATION CODE
 FIRE ALARM CODE: 2013 NFPA 72 NATIONAL FIRE ALARM CODE
 FIRE PREVENTION CODE: 2014 NFPA 130 STANDARD FOR FIXED GUIDEWAY TRANSIT AND PASSENGER RAIL SYSTEMS
 ACCESSIBILITY CODE: ACCESSIBLE AND USEABLE BUILDINGS AND FACILITIES - ICC A117.1-2009

2. BUILDING DESCRIPTION (IBC TABLE 503):

CONSTRUCTION TYPE: 2B
 USE GROUP: U (UTILITY)
 ALLOWABLE TABULAR AREA: 35,500 SF
 ACTUAL AREA:
 EAST PLATFORM AREA: 15,836 SF
 CANOPY (INCLUDED IN PLATFORM AREA): 6,900 SF
 ALLOWABLE HEIGHT: 5 STORY
 ACTUAL HEIGHT: CANOPY 1 STORY

3. PLATFORM OCCUPANCY CALCULATION (NFPA 130):

AREA NAME	OCCUPANT LOAD
EAST PLATFORM	1194

4. OCCUPANCY AND EGRESS:


NUMBER OF OCCUPANTS:
 ENTRAINING LOAD
 TRACK 1: 19
 TRACK 2: 95
 DETRAINING LOAD: 1080
 TOTAL EAST PLATFORM OCCUPANCY: 1194
 SAFE DISPERSAL AREA:
 REQUIRED AREA: 5 SF/PERSON (STANDING)xOCC. = 1,990 SF
 NEW STAIR: 424
 EXISTING STAIR: 372
 TOTAL STAIR LOAD: 796
 MINIMUM REQUIRED STAIR WIDTH:
 (OCC./4 MINUTES/1.41people/inch/minute): 142 INCHES
 TOTAL STAIR WIDTH PROVIDED: 150 INCHES
 MAXIMUM TRAVEL DISTANCE ON PLATFORM: 325 FT
 LONGEST ROUTE ON PLATFORM: 240 FT

5. EVACUATION TIME:


MAXIMUM TRAVEL SPEED ALONG PLATFORM = 124 FT/MIN.
 MAXIMUM TRAVEL SPEED FOR STAIRS = 48 FT/MIN.
 TEST 1: EVACUATE PLATFORM IN 4 MINUTES OR LESS
 $150 \text{ in.} \times 1.41 = 211.5$
 $796 \text{ people} / 211.5 = 3.77 \text{ minutes}$
 PLATFORM EVACUATION TIME: 3.77 MINUTES; PASS
 TEST 2: EVACUATE STATION TO POINT OF SAFETY IN 6 MINUTES OR LESS
 $240 \text{ FT.} / 124 = 1.94 \sim$
 $44 \text{ FT.} / 48 = .92 \sim ; 1.94 + .92 = 2.86$
 STATION EVACUATION TIME: 2.86 MINUTES; PASS

EGRESS LEGEND

- (1194) OCCUPANT LOAD AT PLATFORM
- (398) OCCUPANT LOAD AT EXIT DISCHARGE
- - - - - PATH OF EGRESS FOR TRAVEL DISTANCE
- ⊕ MOST REMOTE POINT ON PLATFORM
- EXISTING ACCESSIBLE ROUTE REMAINS OPEN DURING CONSTRUCTION
- PROPOSED ACCESSIBLE ROUTE

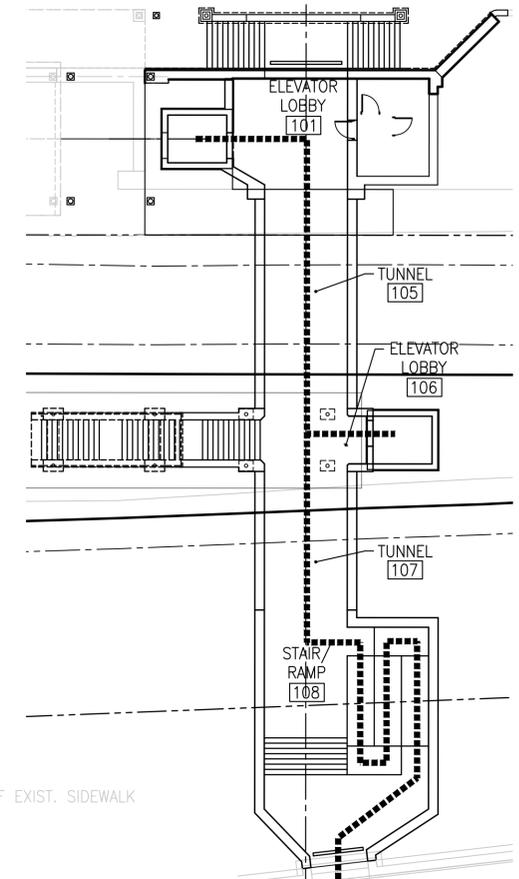

2 TUNNEL LEVEL PLAN
 SCALE: 1/16" = 1'-0"

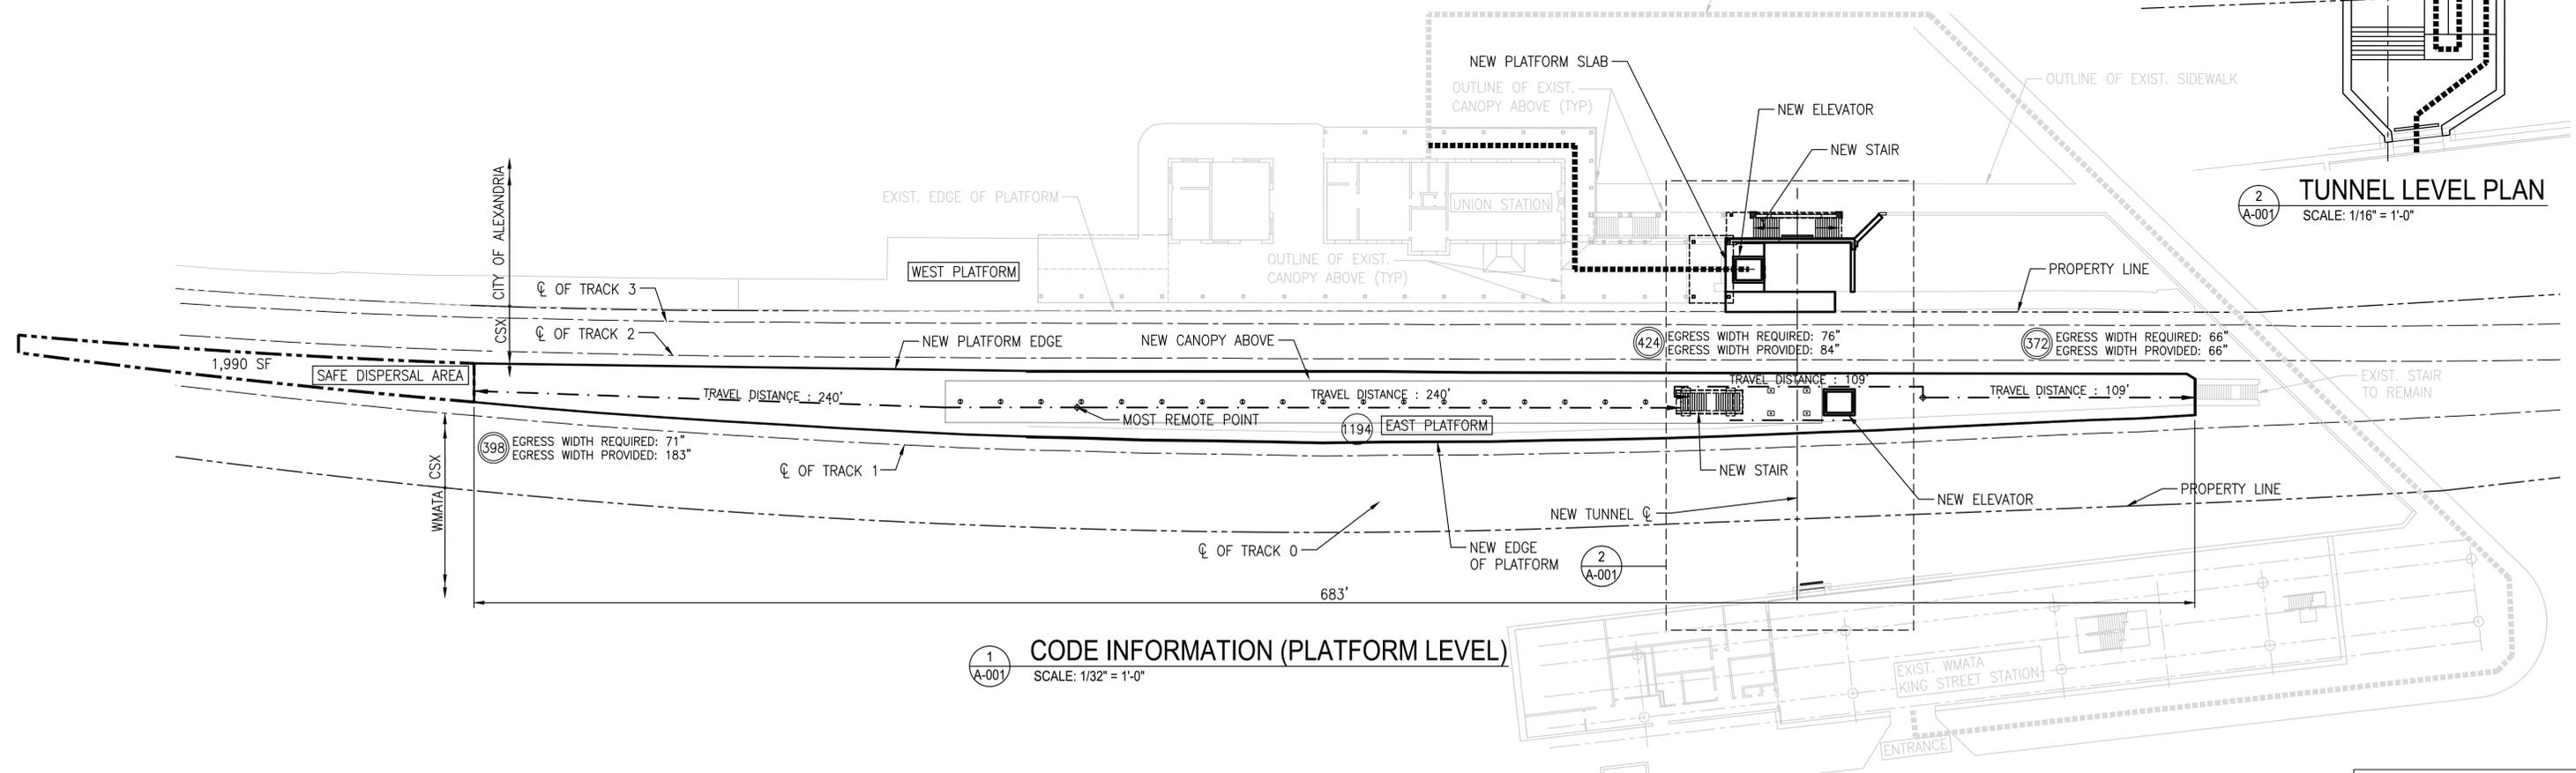

1 CODE INFORMATION (PLATFORM LEVEL)
 SCALE: 1/32" = 1'-0"

60% SUBMITTAL


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BY	NO	DATE	DESCRIPTION		



VIRGINIA RAILWAY EXPRESS
 ALEXANDRIA
 PEDESTRIAN TUNNEL

DISCIPLINE:
 ARCHITECTURAL
 CODE INFORMATION AND
 LIFE SAFETY PLAN
 SCALE: AS SHOWN
 DATE ISSUED: 5/25/16

DRAWING NO:
A-002
 LIST NO:

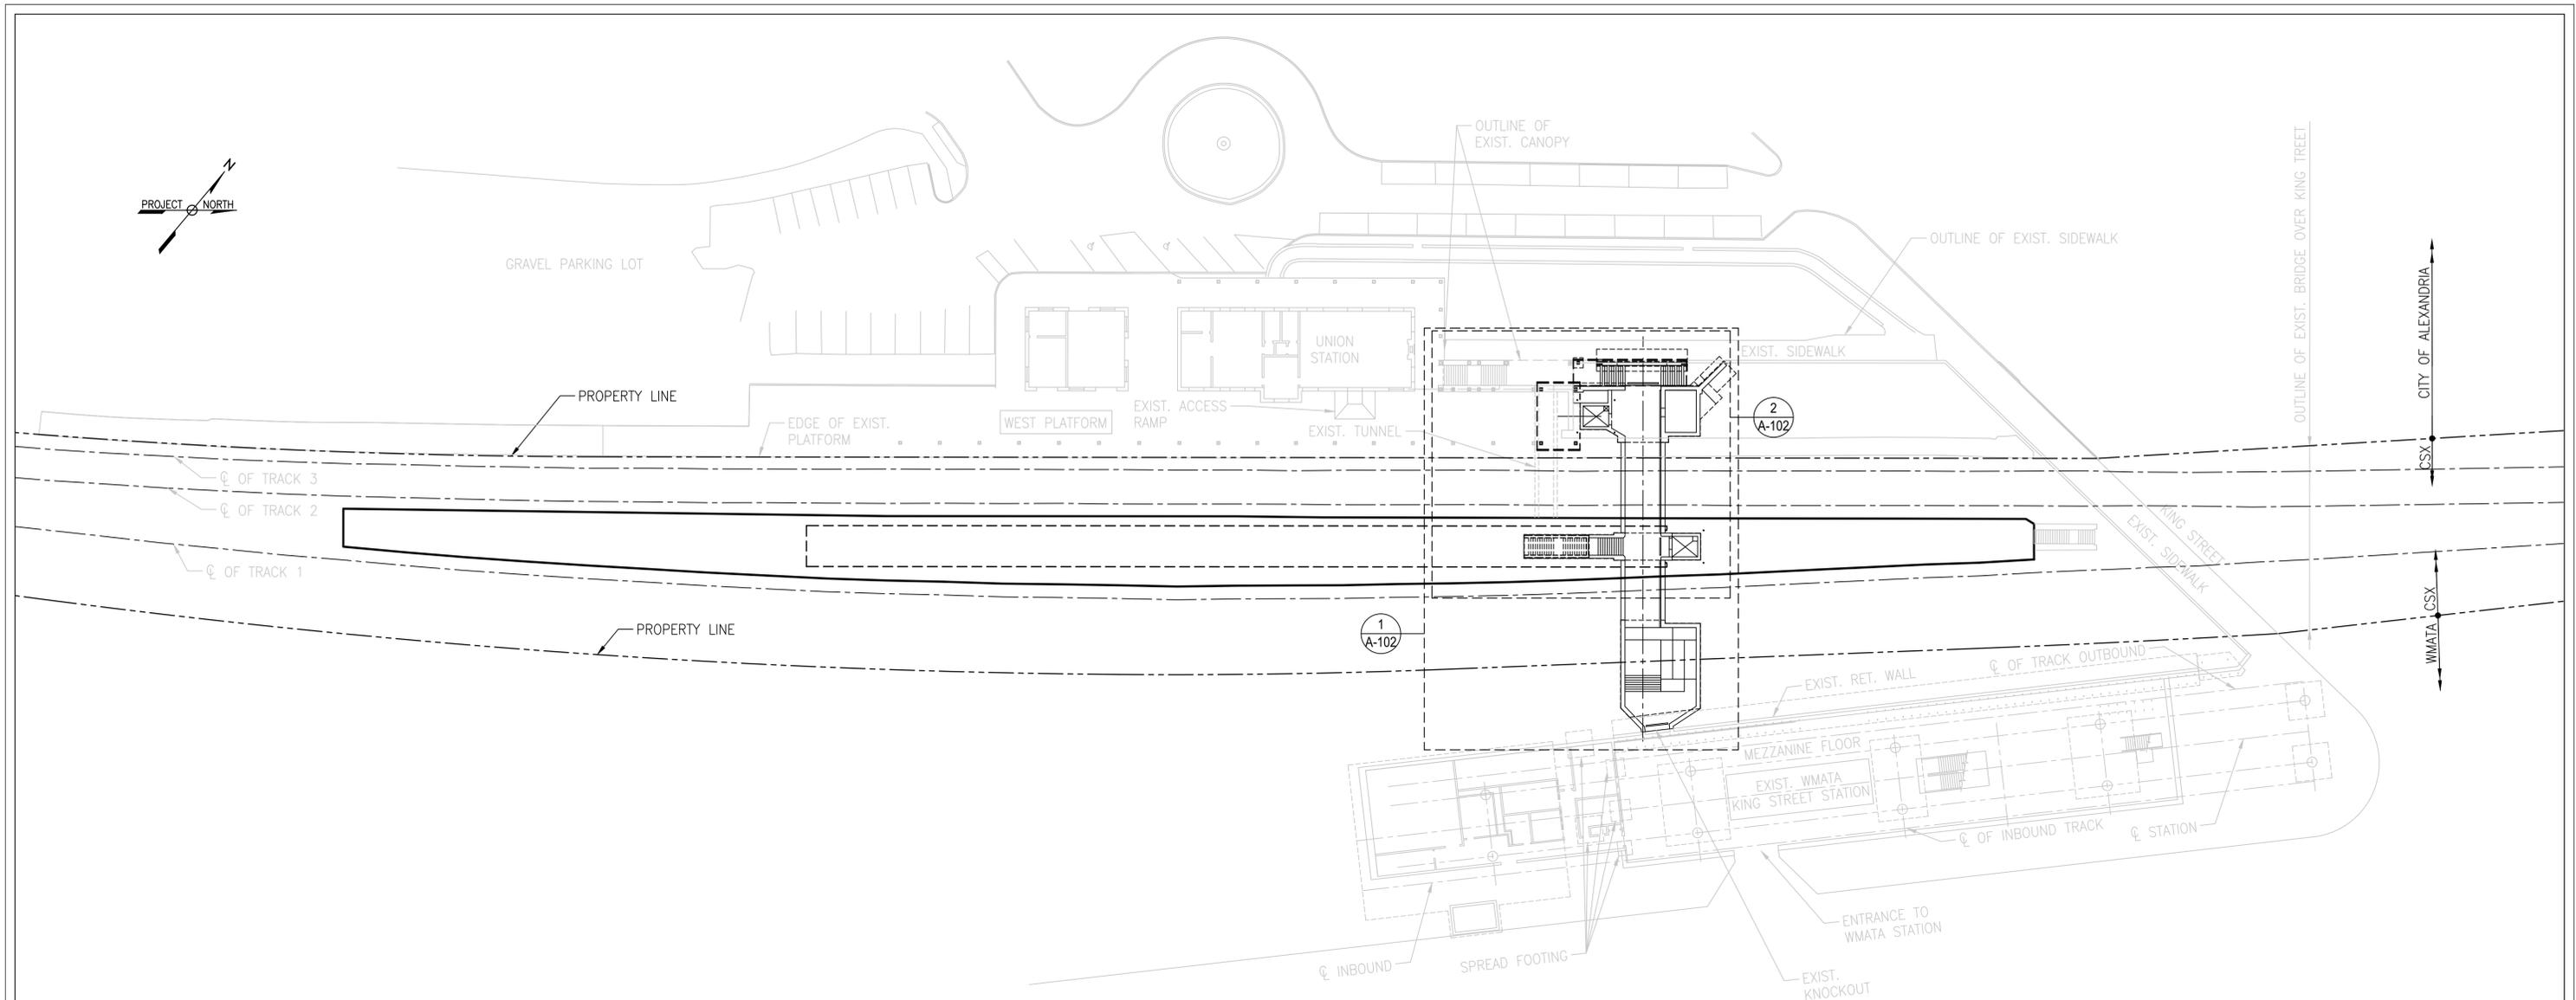

1
A-100 ARCHITECTURAL KEY PLAN
SCALE: 1/32" = 1'-0"

NOTES:

- FOR GENERAL NOTES, REFER TO DRAWING A-001.

60% SUBMITTAL


CONTRACT NO:		REVISIONS			
PROJECT NO:		BY	NO	DATE	DESCRIPTION
DESIGNED:	DRE				
DRAFTED:	DRE				
CHECKED:	JRS				
APPROVED:					



VIRGINIA RAILWAY EXPRESS
ALEXANDRIA
PEDESTRIAN TUNNEL

DISCIPLINE:		DRAWING NO:
ARCHITECTURAL KEY PLAN		A-100
SCALE:	DATE ISSUED:	LIST NO:
1/32" = 1'-0"	5/25/16	

DRAWING NO:
A-100
LIST NO:

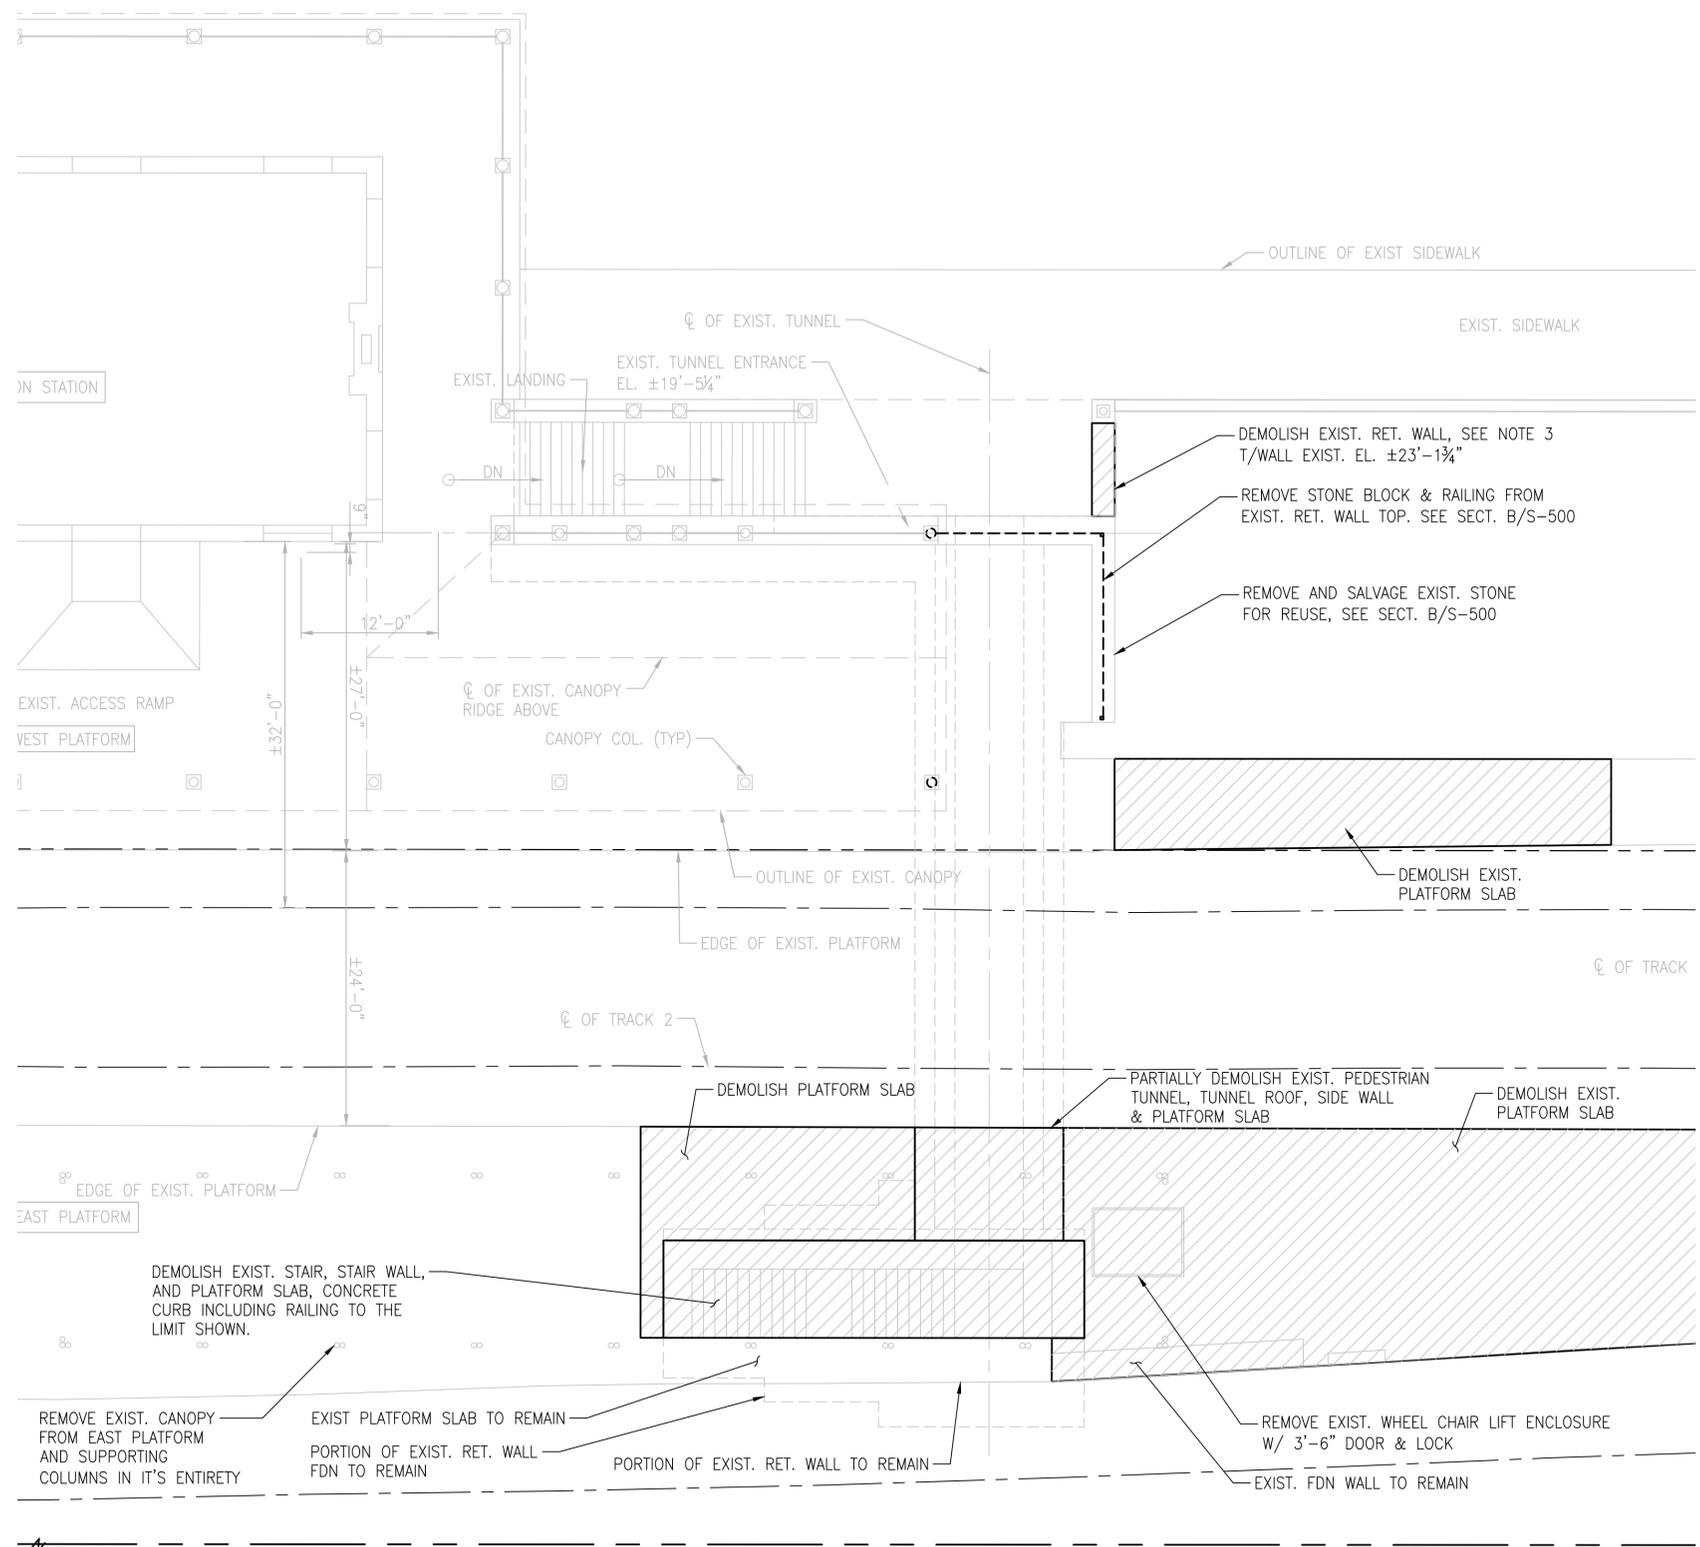

GENERAL DEMOLITON NOTES:

1. FOR DEMOLITION RELATED TO OTHER DISCIPLINES, SEE INDIVIDUAL DISCIPLINE DRAWINGS.
2. VERIFY EXISTING CONDITIONS AND FIELD CONDITIONS.
3. PRIOR TO DEMOLITION, VERIFY MATERIALS AND EQUIPMENT TO BESALVAGED.
4. VERIFY AND MARK ALL UTILITIES PRIOR TO THE START OF WORK.
5. REMOVE ALL RUBBISH AND DEMOLITION DEBRIS FROM THE SITE AND DISPOSE OF IN A LAWFUL MANNER.
6. COORDINATE GENERAL CONSTRUCTION DEMOLITION WITH THE MECHANICAL, PLUMBING, AND ELECTRICAL DEMOLITION WORK.
7. PROVIDE TEMPORARY LINTELS OR STRUCTURAL SUPPORT FOR OPENINGS CREATED BY THE DEMOLITION.
8. WORK AND MAINTAIN SUCH SUPPORTS UNTIL PERMANENT STRUCTURAL SUPPORTS ARE INSTALLED.
9. PROVIDE TEMPORARY STRUCTURAL SUPPORT FOR WALLS AND ROOFS AS REQUIRED DURING DEMOLITION WORK AND MAINTAIN SUCH SUPPORTS UNTIL PERMANENT STRUCTURAL SUPPORTS ARE INSTALLED.
10. REPAIR ALL EXISTING STRUCTURES, UTILITIES, AND EQUIPMENT, SCHEDULED TO REMAIN, WHICH ARE DAMAGED DURING DEMOLITION OPERATIONS.
11. ALL WORK SCHEDULED TO BE DEMOLISHED, WILL BE REMOVED COMPLETELY INCLUDING ALL FASTENERS, ATTACHMENTS, ACCESSORIES, OR ANY RELATED WORK.
12. DEMOLITION INCLUDES ALL ITEMS WHETHER OR NOT SHOWN ON THE DRAWINGS, THAT ARE REQUIRED TO BE REMOVED IN ORDER TO INSTALL THE NEW WORK SHOWN ON DRAWINGS AND OTHER PORTIONS OF THE CONTRACT DOCUMENTS.
13. IT IS THE CONTRACTORS RESPONSIBILITY TO COORDINATE DEMOLITION IN CONNECTION WITH NEW WORK. ANY DEMOLITION REMOVED AND NOT REQUIRED TO BE PART OF NEW CONSTRUCTION WILL BE REPLACED AT NO ADDITIONAL COST TO THE OWNER.

1 PARTIAL PLAN - DEMOLITION
 SCALE: 1/8" = 1'-0"


60% SUBMITTAL

CONTRACT NO:	REVISIONS			
PROJECT NO:	BY	NO	DATE	DESCRIPTION
DESIGNED:				
DRAFTED: DRE				
CHECKED:				
APPROVED:				




VIRGINIA RAILWAY EXPRESS
 ALEXANDRIA
 PEDESTRIAN TUNNEL


DISCIPLINE:	DRAWING NO:
ARCHITECTURAL DEMOLITION PLAN	A-101
SCALE: 1/8" = 1'-0"	LIST NO:
DATE ISSUED: 5/25/16	

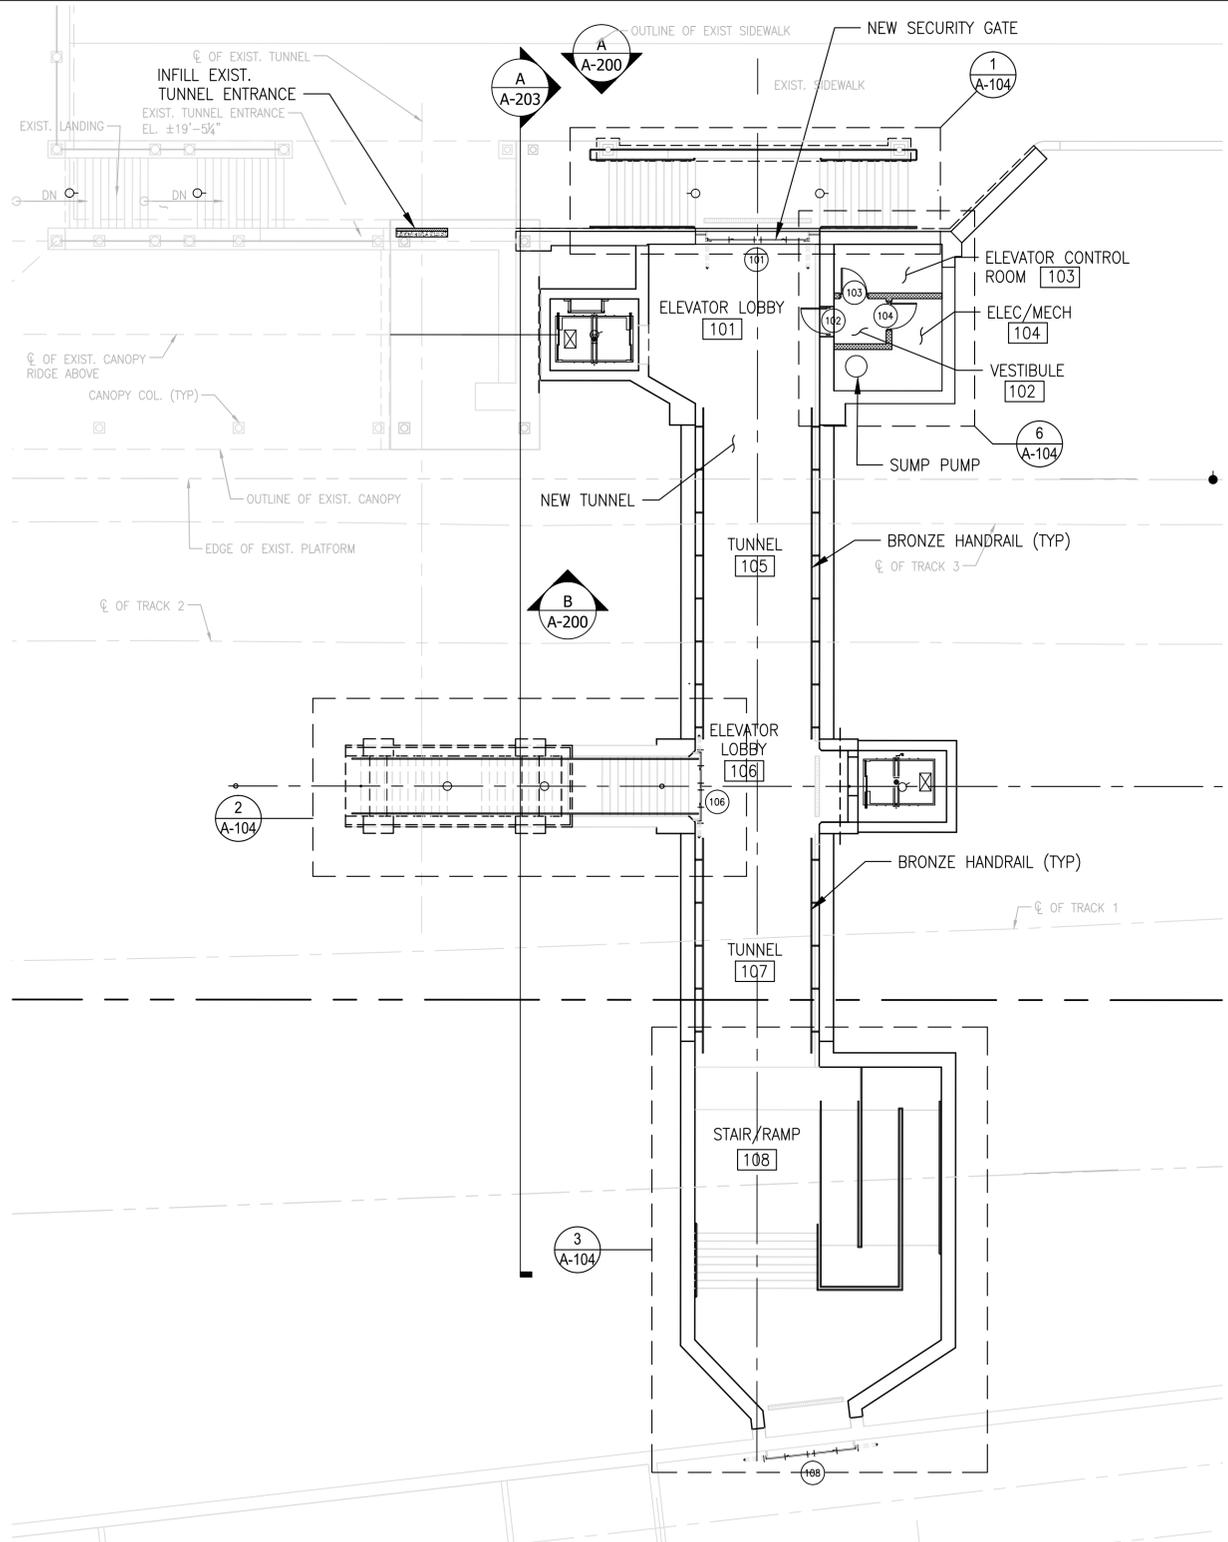

1
 PARTIAL PLAN - TUNNEL LEVEL
 SCALE: 3/32" = 1'-0"

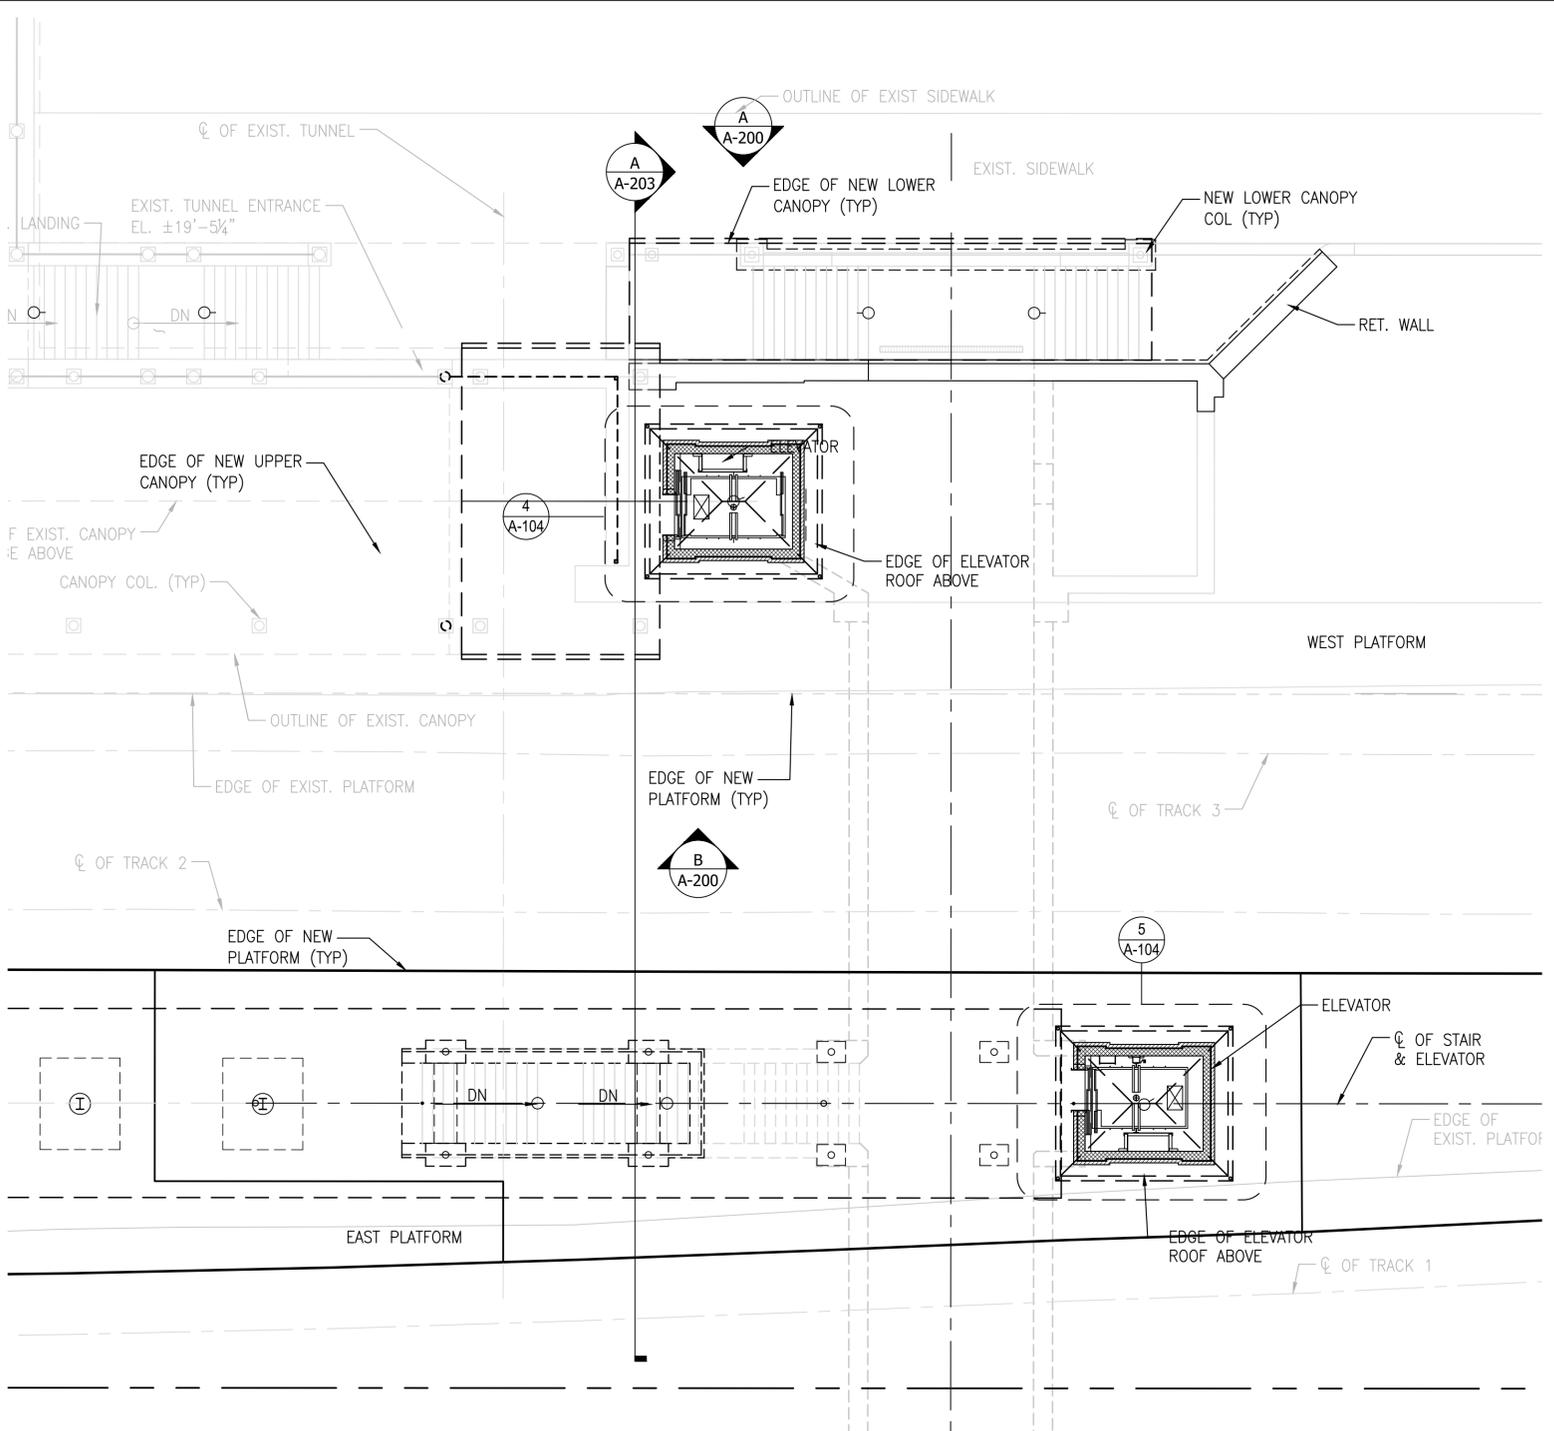

2
 PARTIAL PLAN - PLATFORM LEVEL
 SCALE: 1/8" = 1'-0"

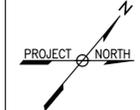


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PROJECT NO:	BY	NO	DATE	DESCRIPTION
DESIGNED:				
DRAFTED: DRE				
CHECKED:				
APPROVED:				





VIRGINIA RAILWAY EXPRESS
 ALEXANDRIA
 PEDESTRIAN TUNNEL

DISCIPLINE:	DRAWING NO:
ARCHITECTURAL ELEVATORS AND TUNNEL PLANS	A-102
SCALE:	LIST NO:
AS SHOWN	
DATE ISSUED:	
5/25/16	

60% SUBMITTAL

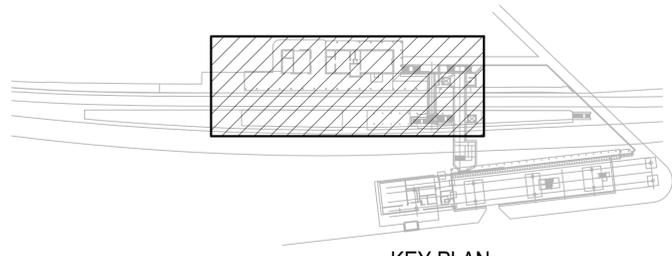

KEY PLAN
SCALE: 1/128" = 1'-0"

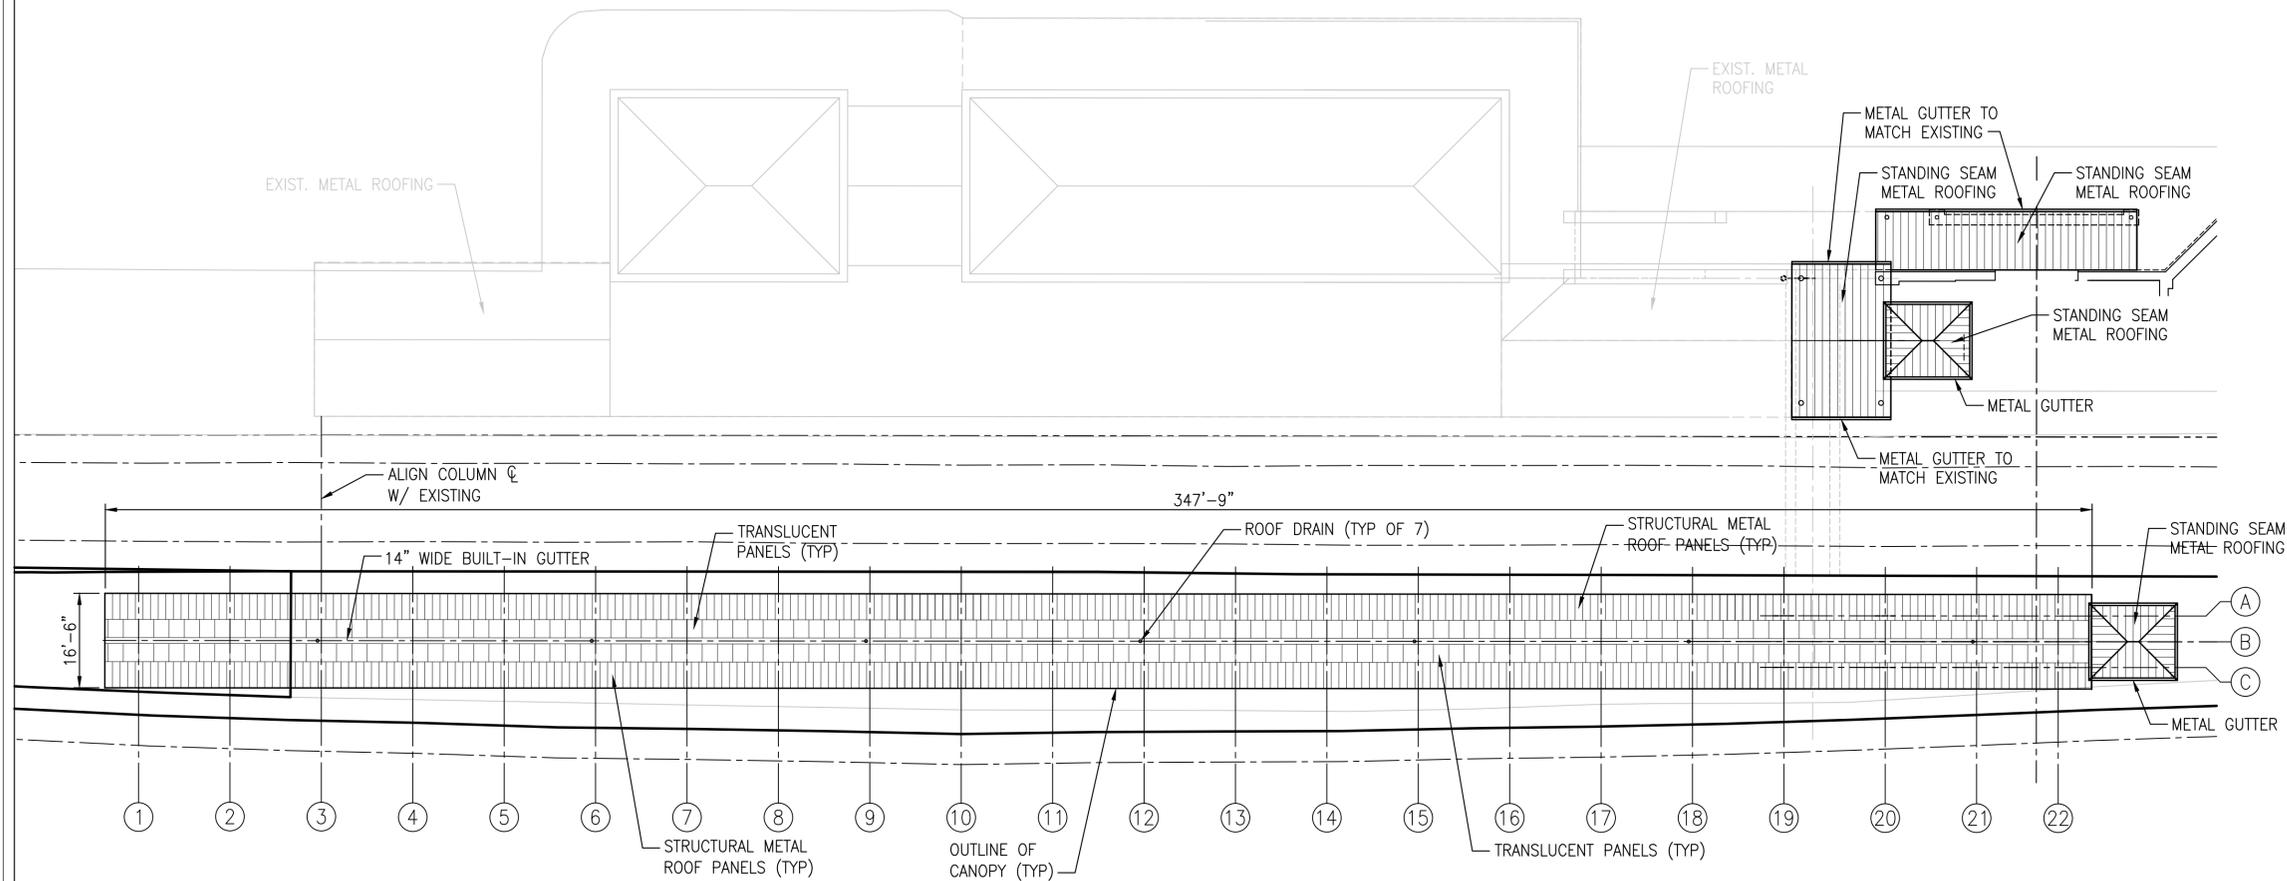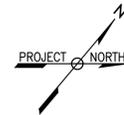

1
A-103 **CANOPY AND ELEVATOR ROOF PLAN**
SCALE: 1/16" = 1'-0"

- NOTES:**
- FOR GENERAL NOTES, REFER TO DRAWING A-001.

60% SUBMITTAL


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PROJECT NO:		BY	NO	DATE	DESCRIPTION
DESIGNED:	JRS				
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CHECKED:	JRS				
APPROVED:					




VIRGINIA RAILWAY EXPRESS
**ALEXANDRIA
PEDESTRIAN TUNNEL**

DISCIPLINE:		DRAWING NO:
ARCHITECTURAL CANOPY ROOF PLAN		A-103
SCALE:	DATE ISSUED:	LIST NO:
1/16" = 1'-0"	5/25/16	


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A-103
LIST NO:

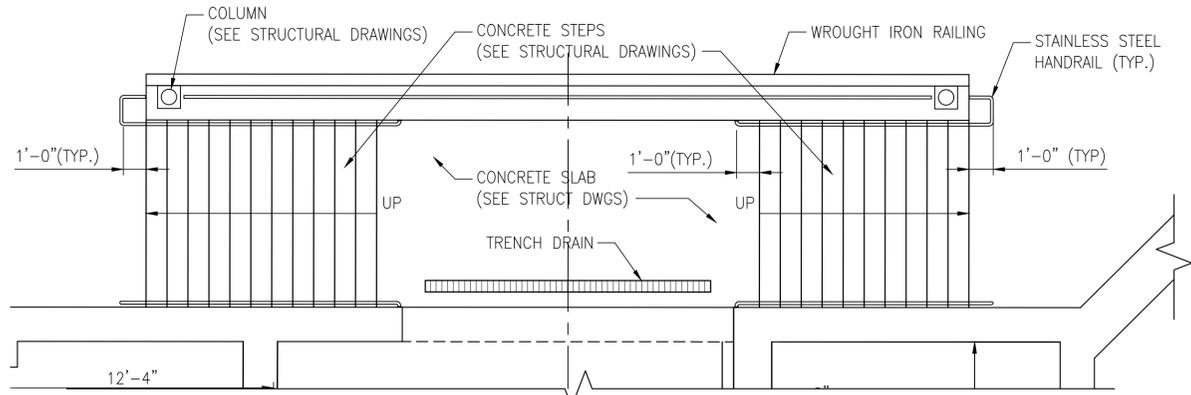


1
A-104 ENLARGED PLAN - STAIR 1
SCALE: 1/4" = 1'-0"

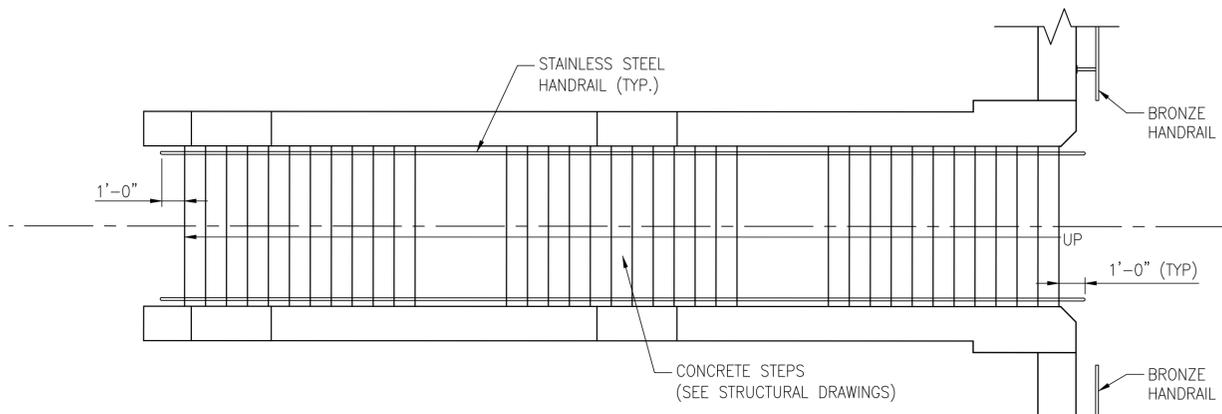


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A-104 ENLARGED PLAN - STAIR 1
SCALE: 1/4" = 1'-0"

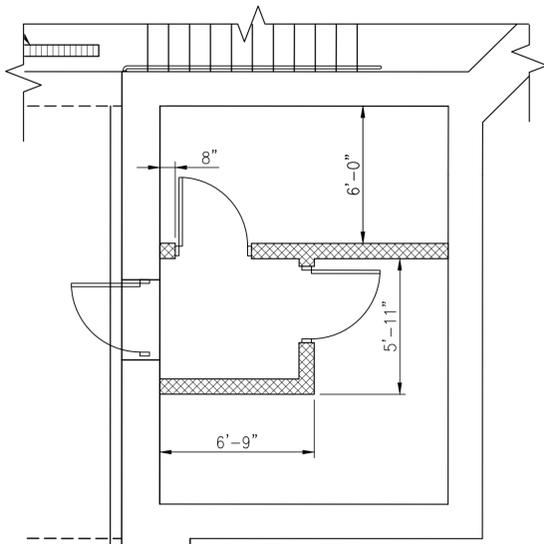


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A-104 ENLARGED PLAN
SCALE: 1/4" = 1'-0"

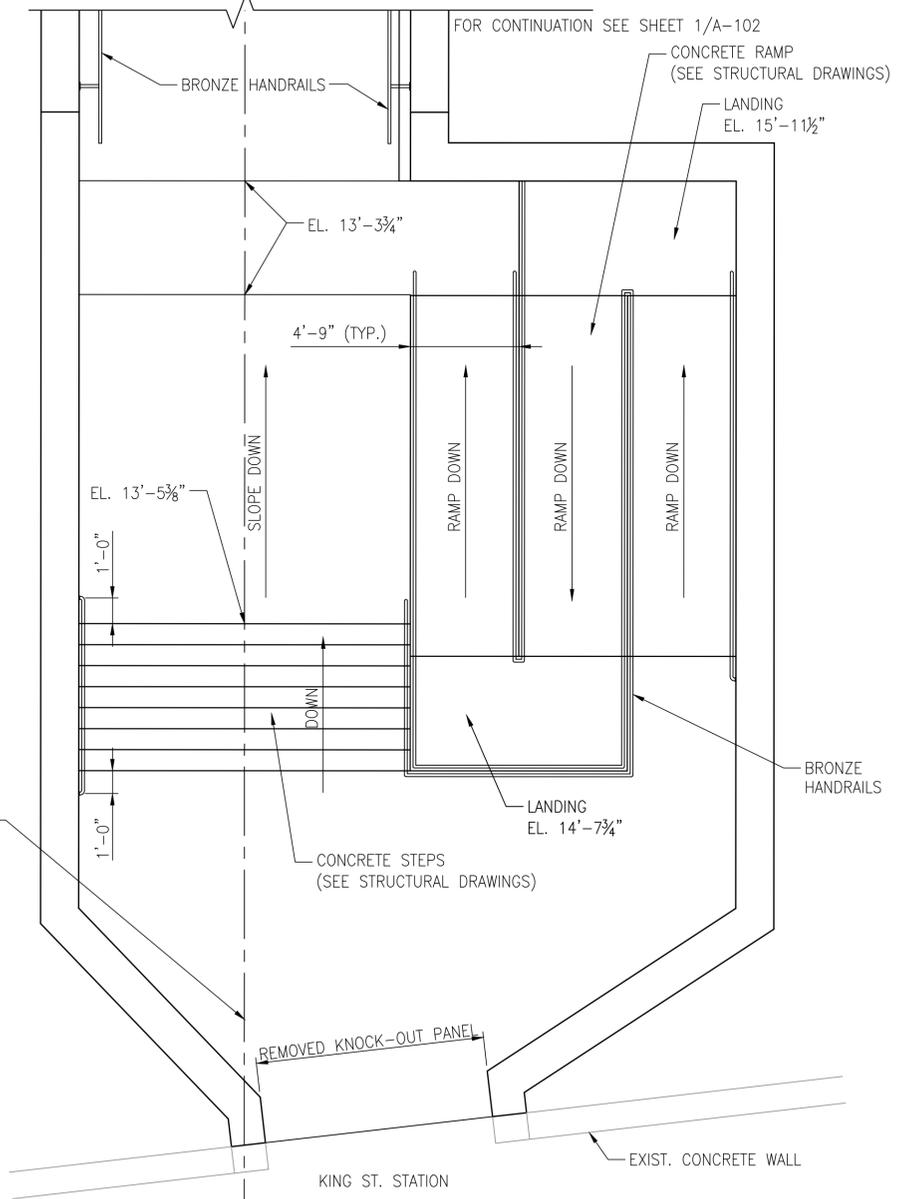


3
A-104 ENLARGED PLAN - STAIR / RAMP 108
SCALE: 1/4" = 1'-0"

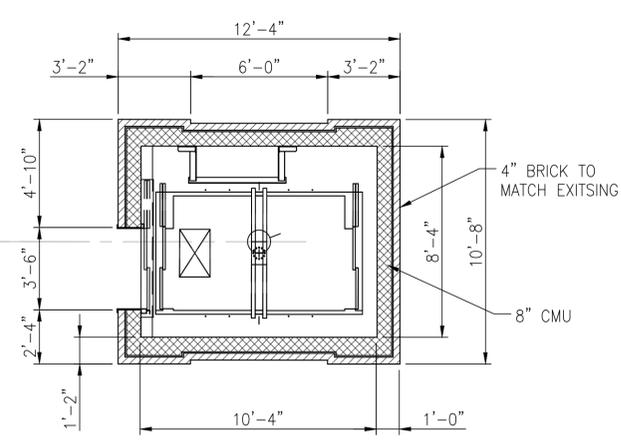

4
A-104 ENLARGED PLAN - ELEVATOR 1
SCALE: 1/4" = 1'-0"

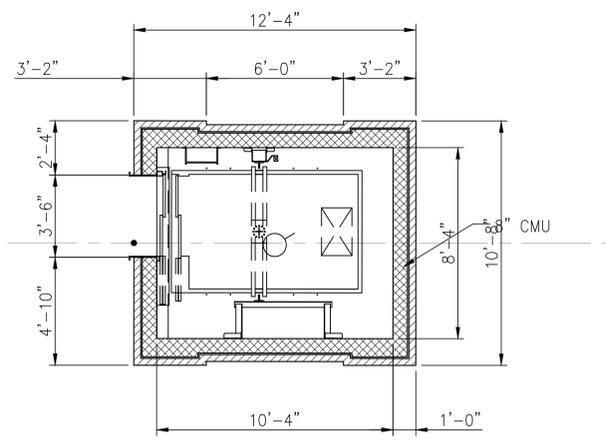

5
A-104 ENLARGED PLAN - ELEVATOR 2
SCALE: 1/4" = 1'-0"

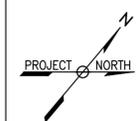


60% SUBMITTAL

CONTRACT NO:	REVISIONS			
PROJECT NO:	BY	NO	DATE	DESCRIPTION
DESIGNED:				
DRAFTED: DRE				
CHECKED:				
APPROVED:				




VIRGINIA RAILWAY EXPRESS
ALEXANDRIA
PEDESTRIAN TUNNEL

DISCIPLINE:	DRAWING NO:
ARCHITECTURAL ENLARGED PLANS	A-104
SCALE:	LIST NO:
AS SHOWN	
DATE ISSUED:	
5/25/16	

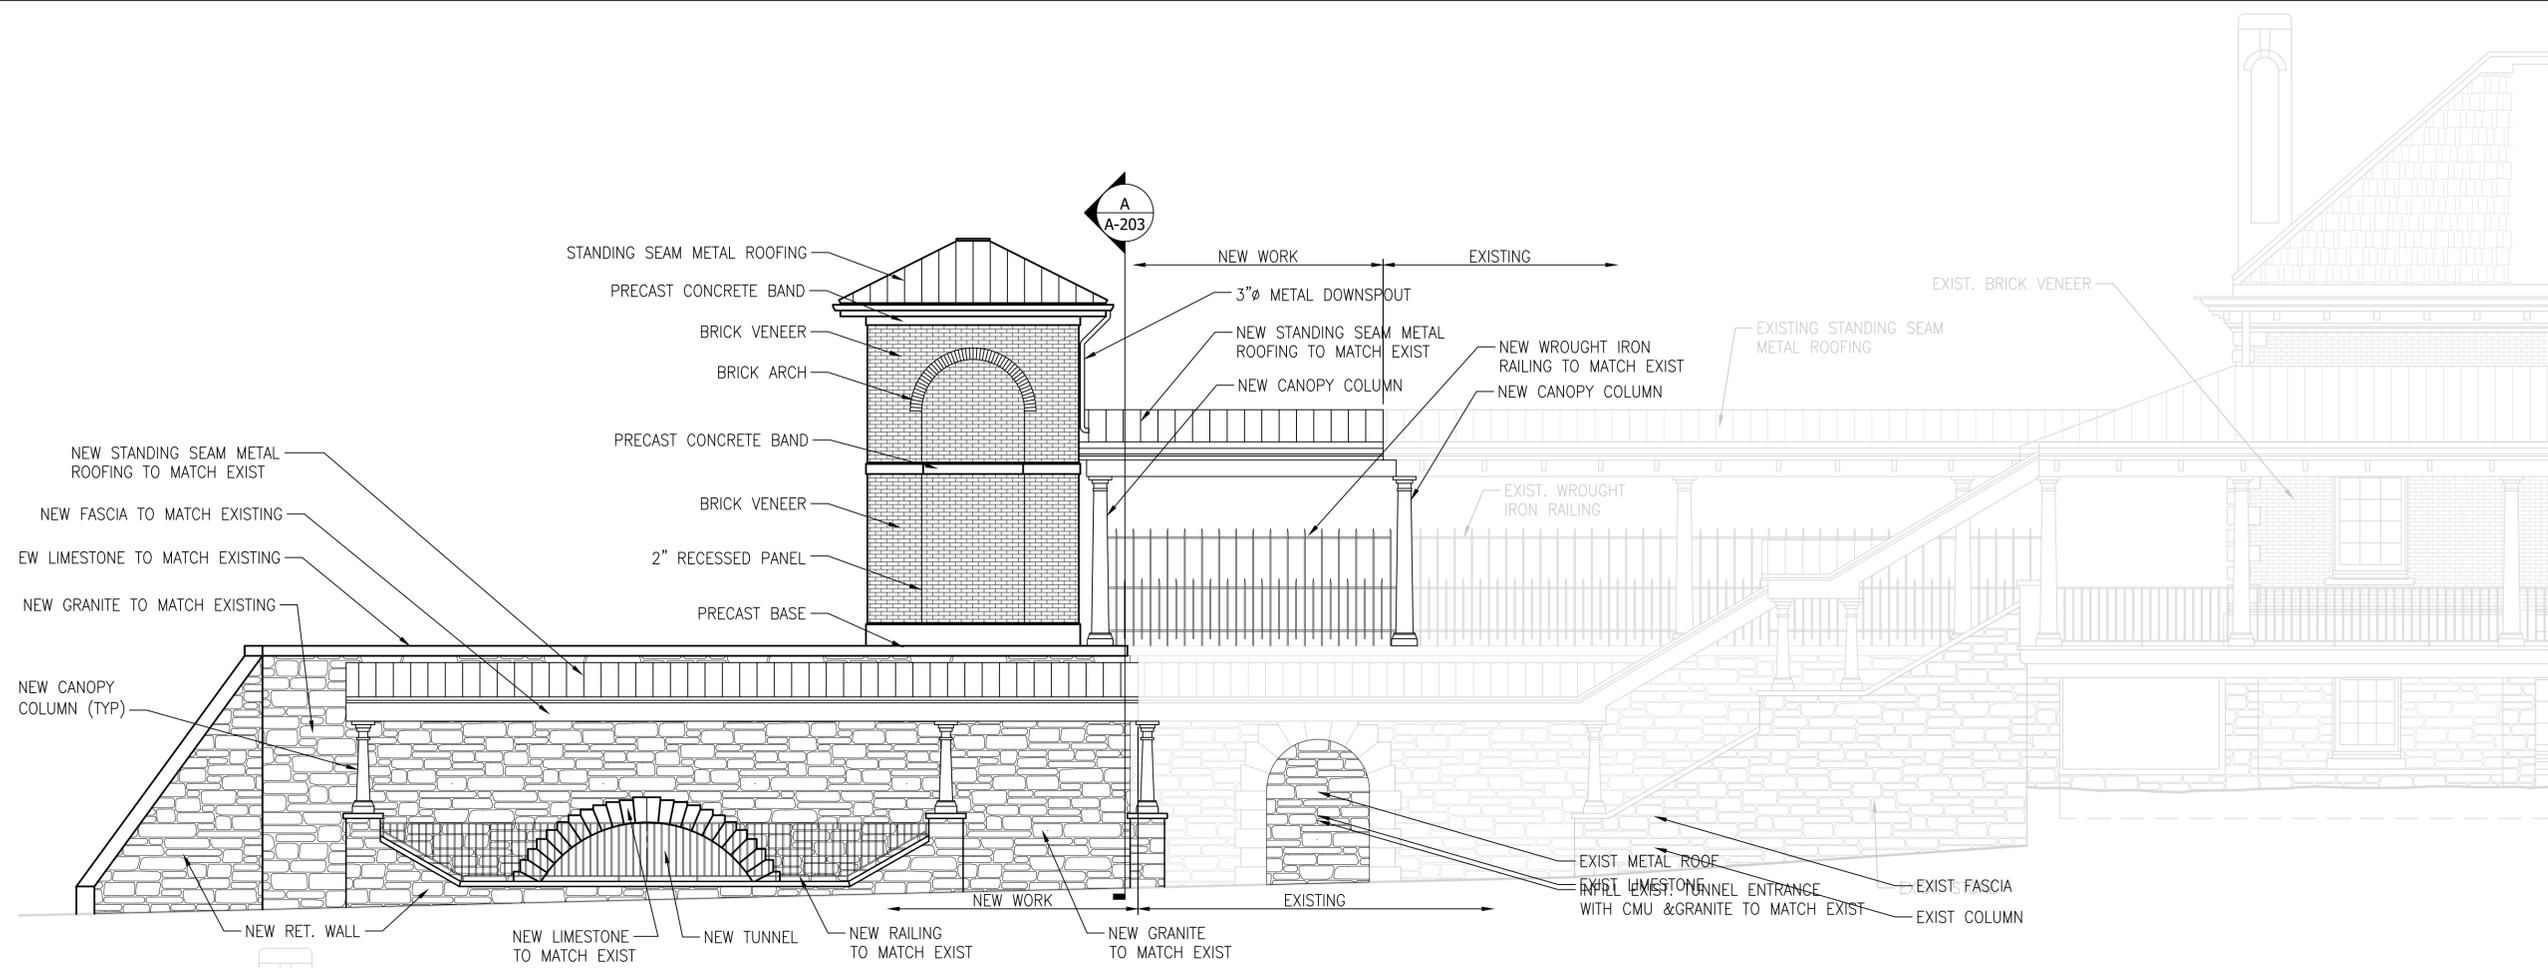

A
A-200
CANOPY ELEVATION
SCALE: 3/16" = 1'-0"

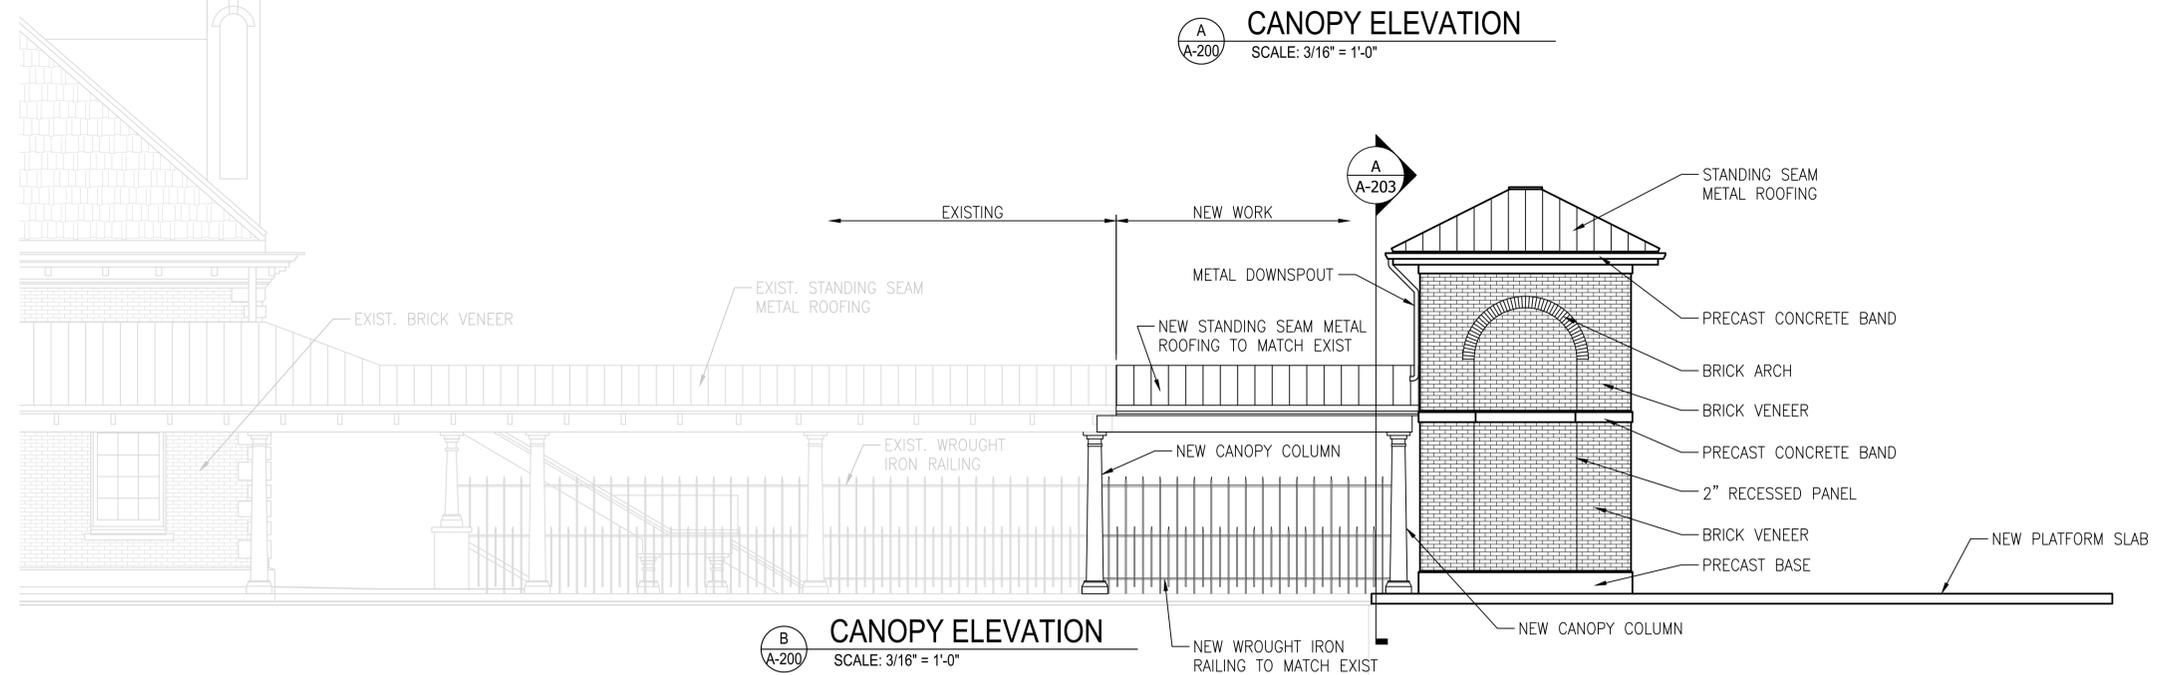

B
A-200
CANOPY ELEVATION
SCALE: 3/16" = 1'-0"

60% SUBMITTAL

CONTRACT NO:	REVISIONS			
PROJECT NO:	BY	NO	DATE	DESCRIPTION
DESIGNED:				
DRAFTED: LTN				
CHECKED:				
APPROVED:				




VIRGINIA RAILWAY EXPRESS
**ALEXANDRIA
PEDESTRIAN TUNNEL**

DISCIPLINE:
**ARCHITECTURAL
CANOPY ELEVATIONS**


SCALE: 3/16" = 1'-0" DATE ISSUED: 5/25/16

DRAWING NO:
A-200

LIST NO:

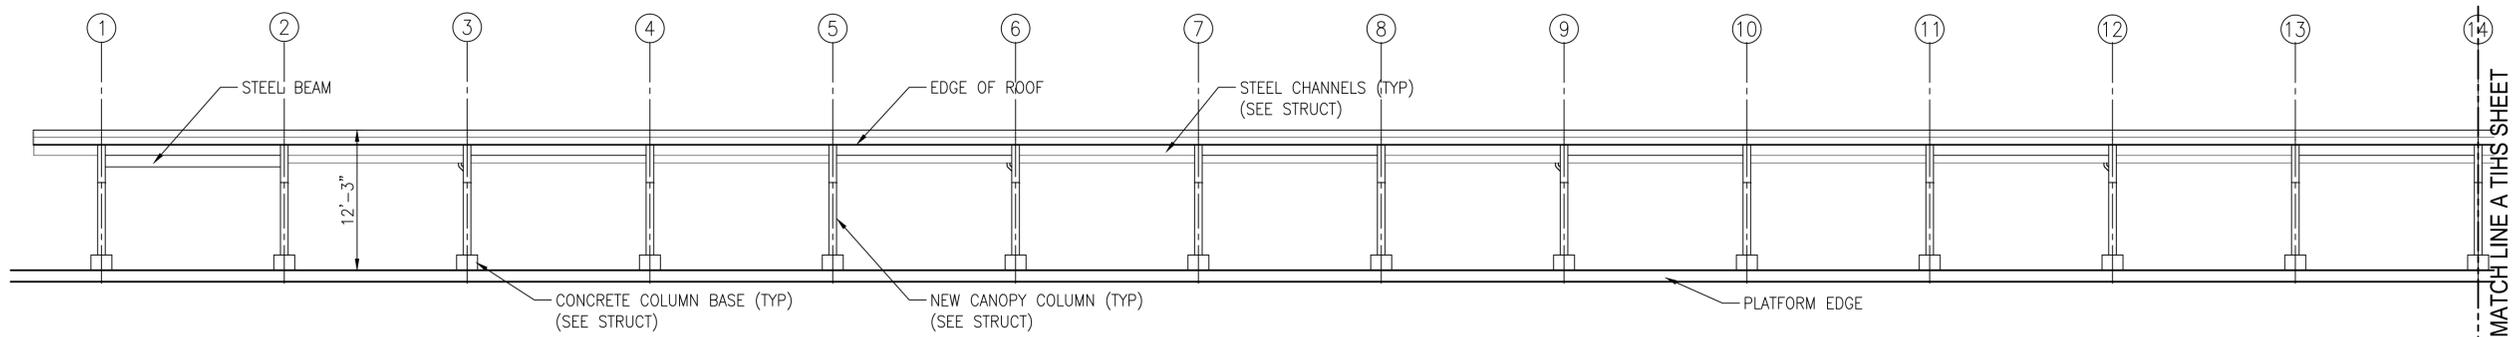

A
A-201 **EAST CANOPY ELEVATION - PART A**
SCALE: 1/8" = 1'-0"

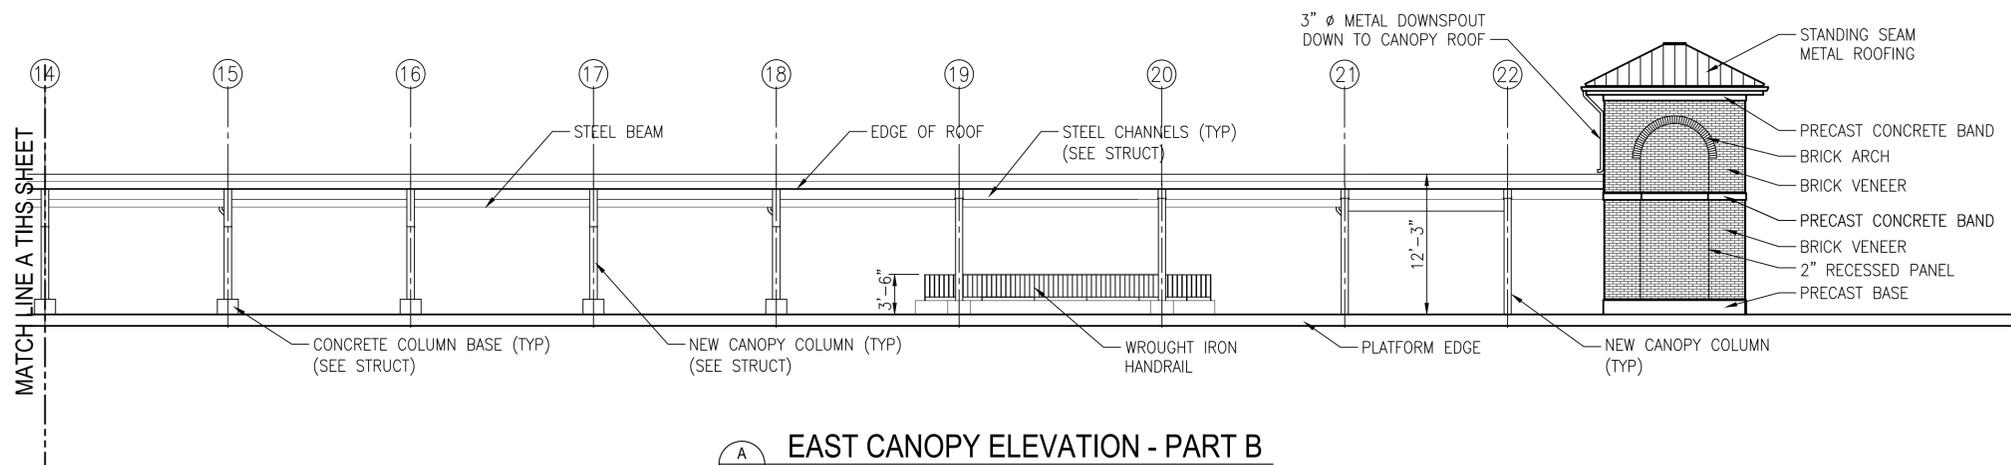

A
A-201 **EAST CANOPY ELEVATION - PART B**
SCALE: 1/8" = 1'-0"


60% SUBMITTAL

CONTRACT NO:		REVISIONS			
PROJECT NO:		BY	NO	DATE	DESCRIPTION
DESIGNED:	DATE:				
DRAFTED: LTN					
CHECKED:					
APPROVED:					




VIRGINIA RAILWAY EXPRESS
ALEXANDRIA
PEDESTRIAN TUNNEL

DISCIPLINE:		DRAWING NO:
ARCHITECTURAL EAST CANOPY ELEVATION		A-201
SCALE:	DATE ISSUED:	LIST NO:
1/8" = 1'-0"	5/25/16	

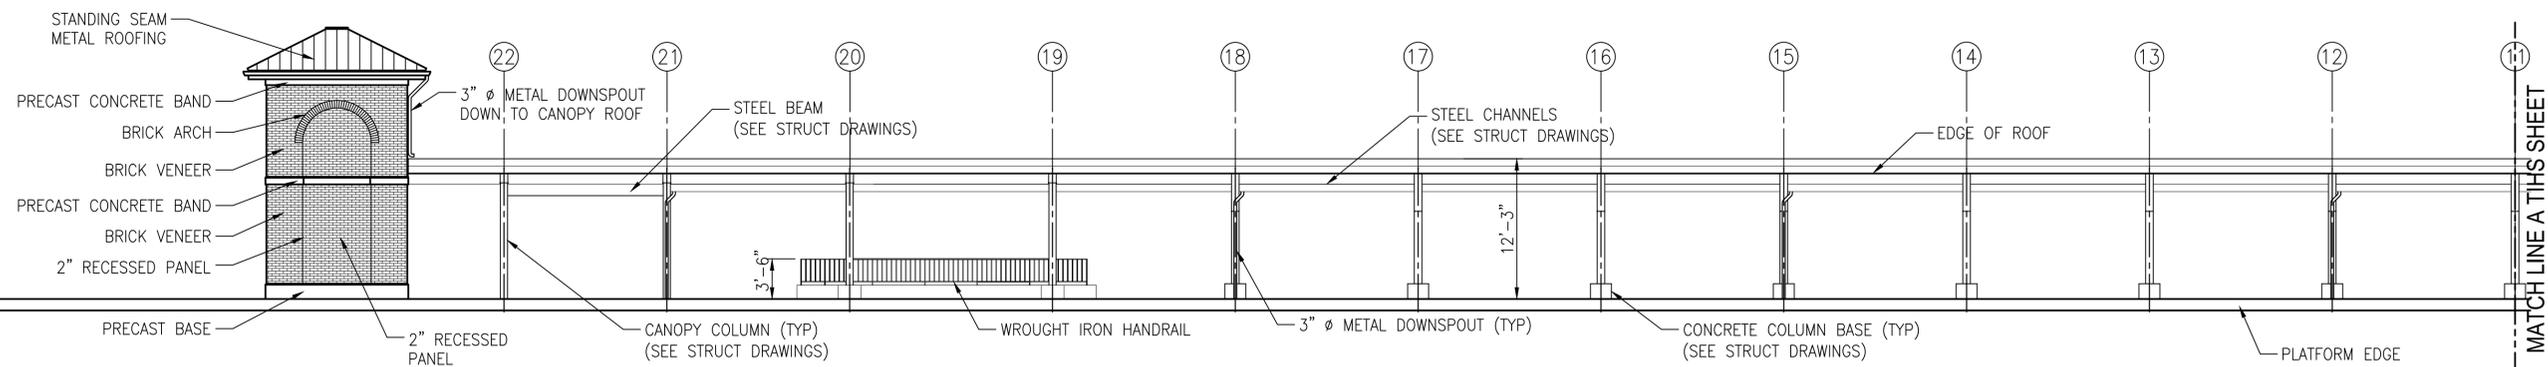

A
A-202 EAST CANOPY ELEVATION - PART A
SCALE: 1/8" = 1'-0"

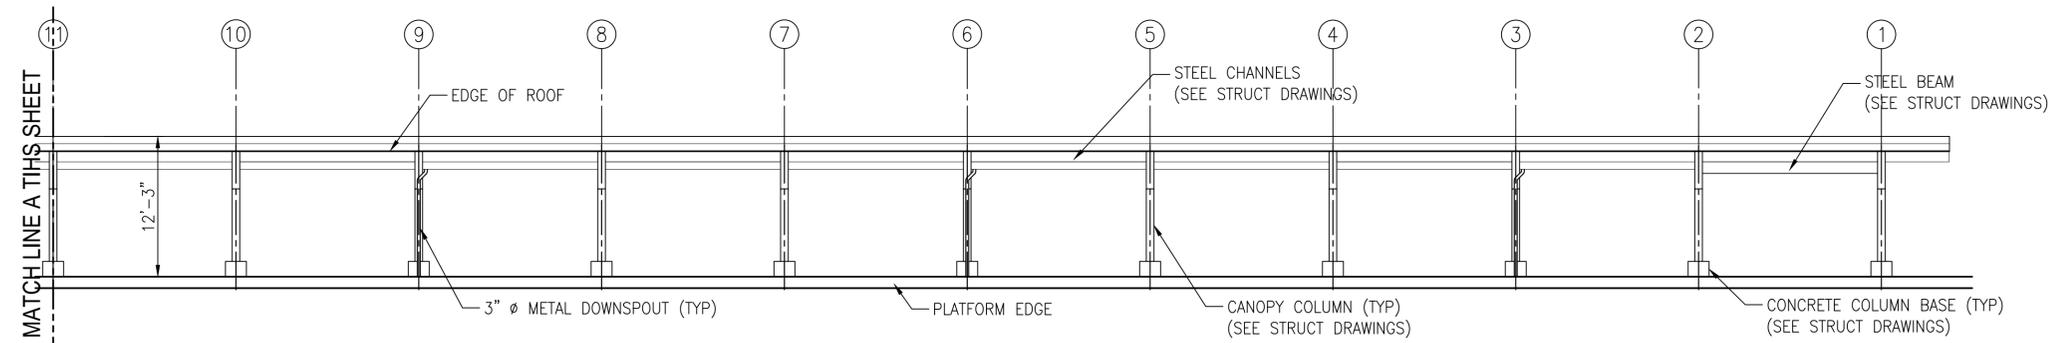

A
A-202 EAST CANOPY ELEVATION - PART B
SCALE: 1/8" = 1'-0"


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CONTRACT NO:		REVISIONS			
PROJECT NO:		BY	NO	DATE	DESCRIPTION
DESIGNED:	DATE:				
DRAFTED: LTN					
CHECKED:					
APPROVED:					



VIRGINIA RAILWAY EXPRESS
ALEXANDRIA
PEDESTRIAN TUNNEL

DISCIPLINE:		DRAWING NO:
ARCHITECTURAL EAST CANOPY ELEVATION		A-202
SCALE:	DATE ISSUED:	LIST NO:
1/8" = 1'-0"	5/25/16	

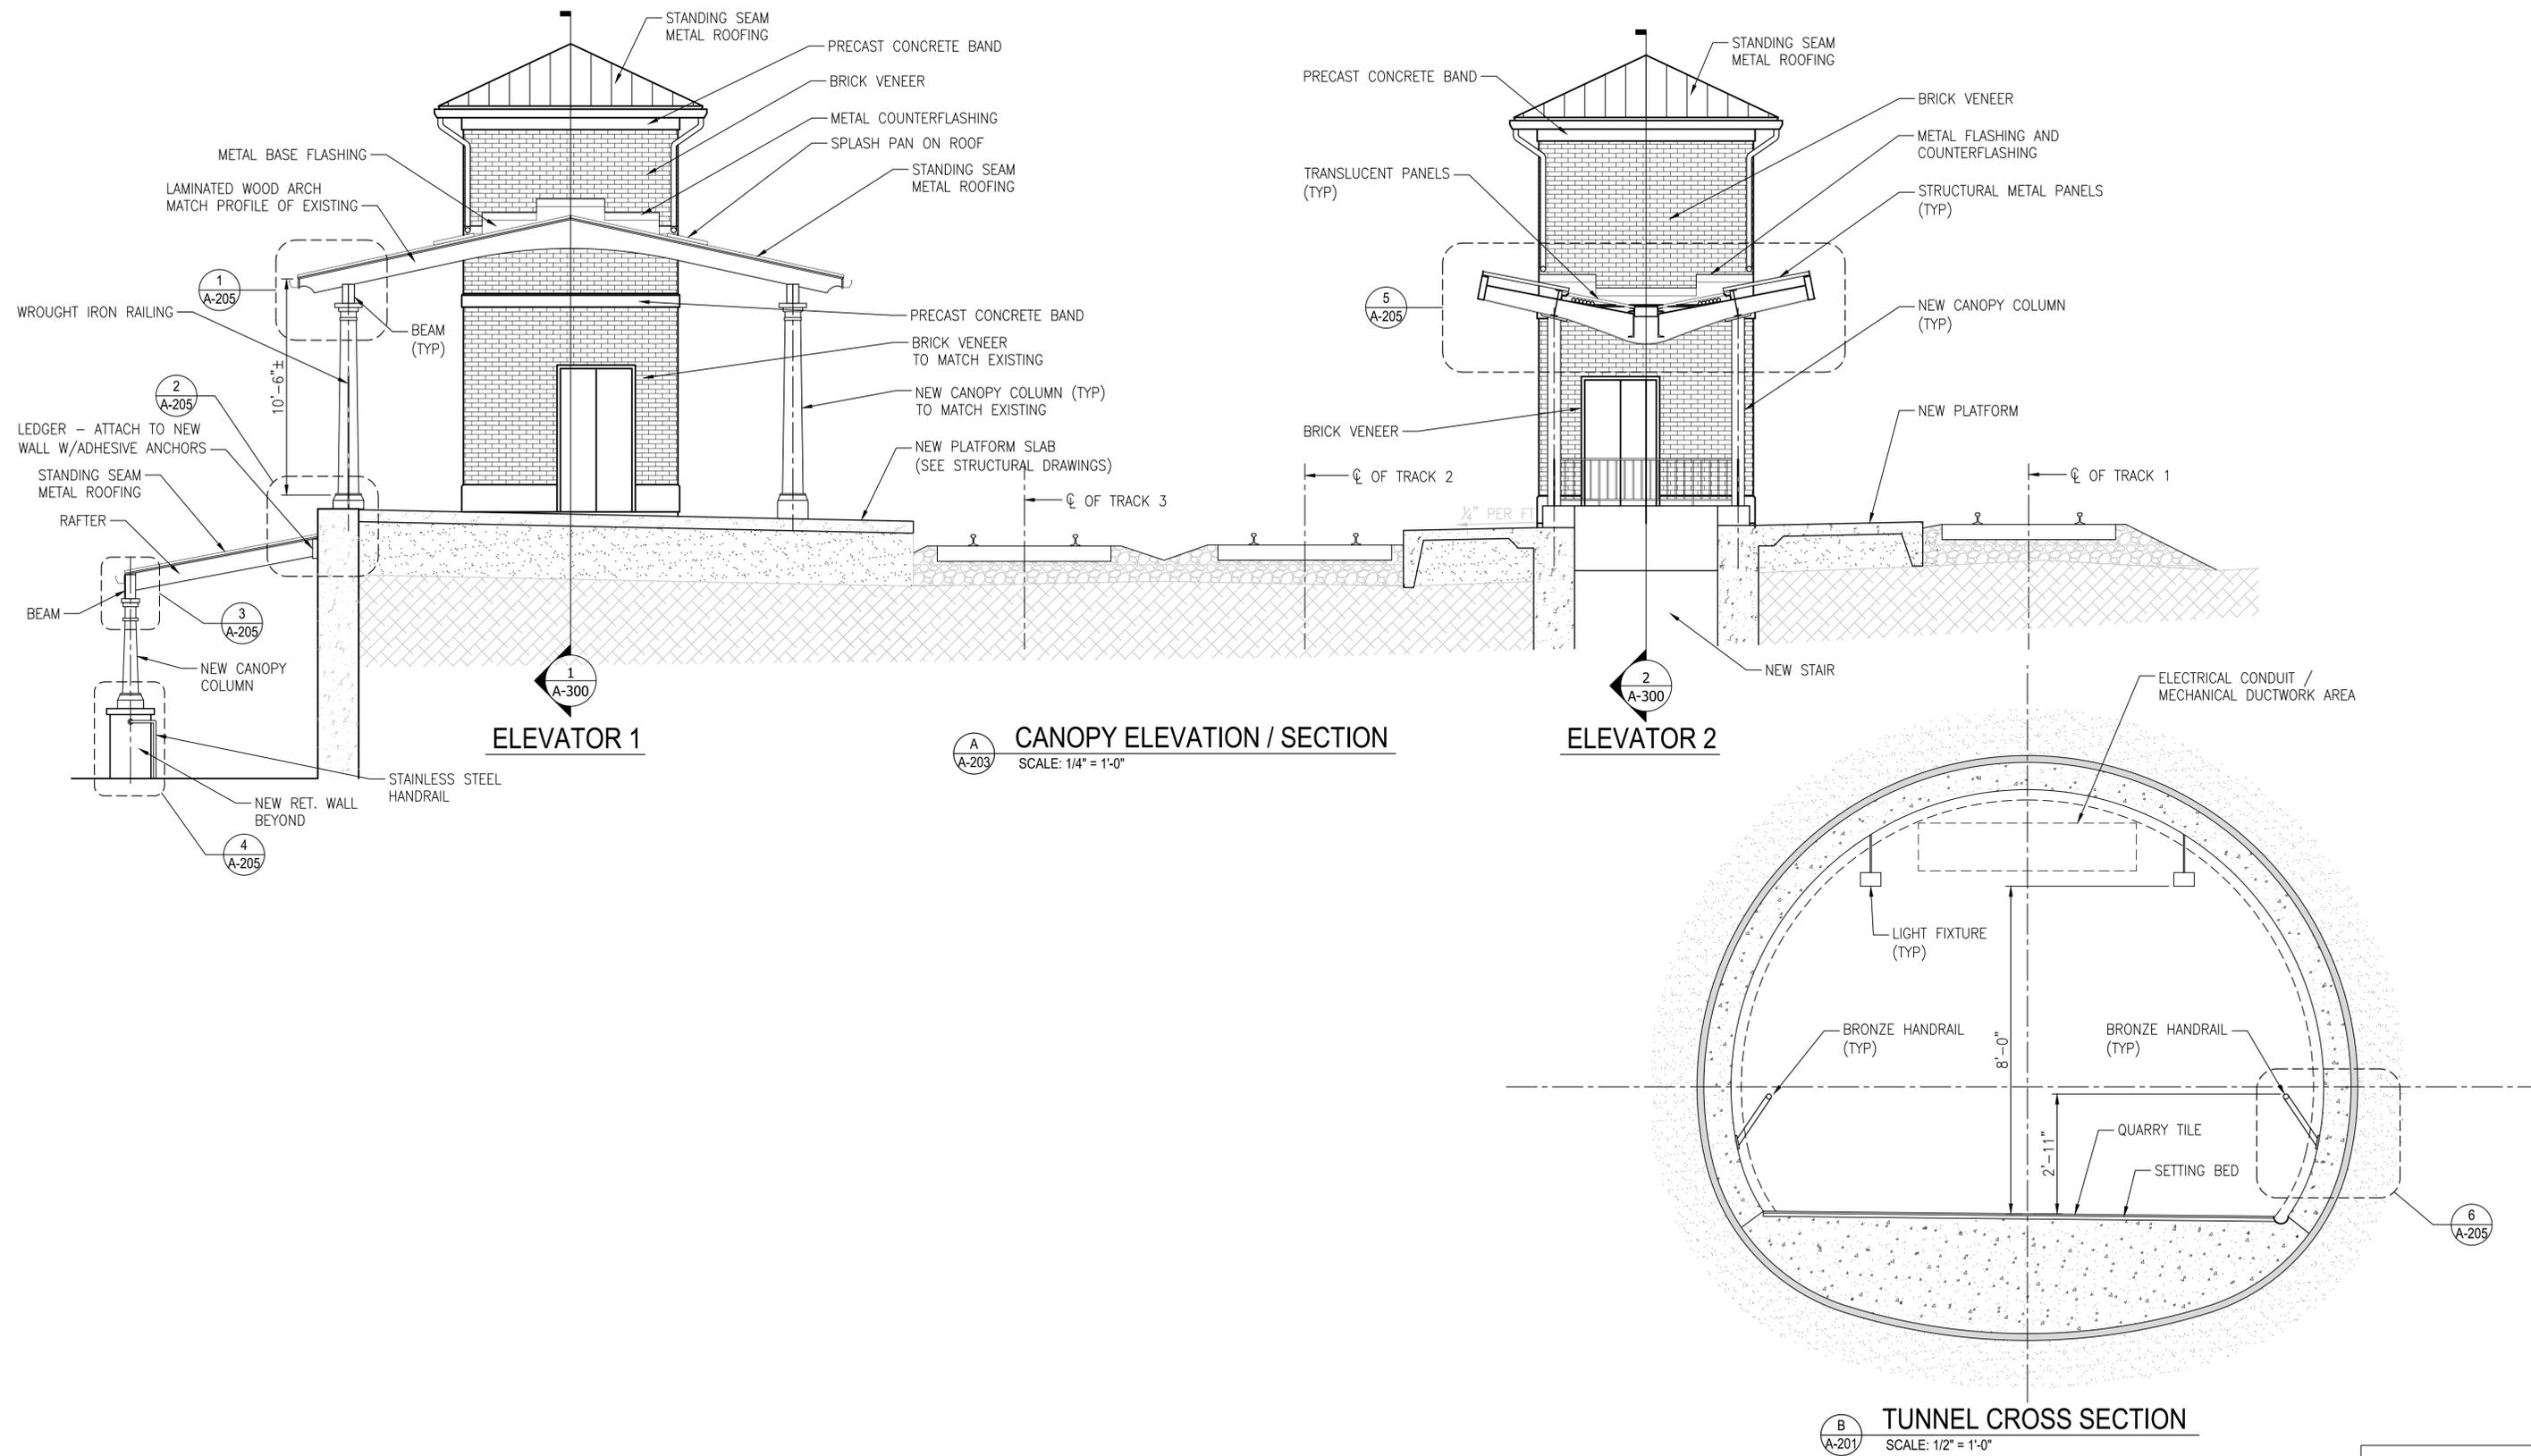


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CONTRACT NO:	REVISIONS			
PROJECT NO:	BY	NO	DATE	DESCRIPTION
DESIGNED: IA				
DRAFTED: LTN				
CHECKED:				
APPROVED:				




VIRGINIA RAILWAY EXPRESS
 ALEXANDRIA
 PEDESTRIAN TUNNEL


DISCIPLINE:	DRAWING NO:
ARCHITECTURAL ELEVATION / SECTIONS	A-203
SCALE: 1/4" = 1'-0"	LIST NO:
DATE ISSUED: 5/25/16	

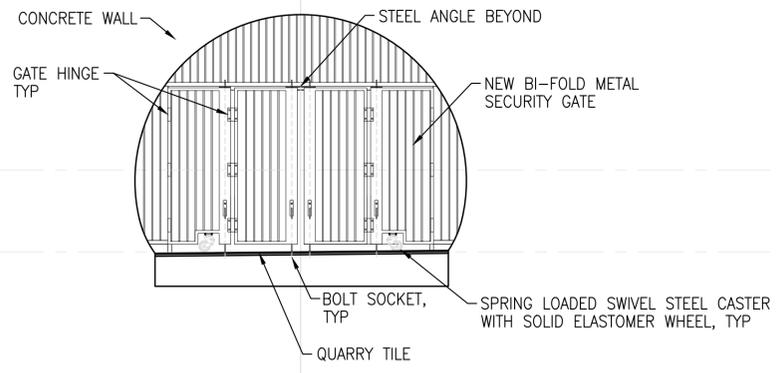

1 SECURITY GATE ELEVATION
A-204 SCALE: 1/4" = 1'-0"

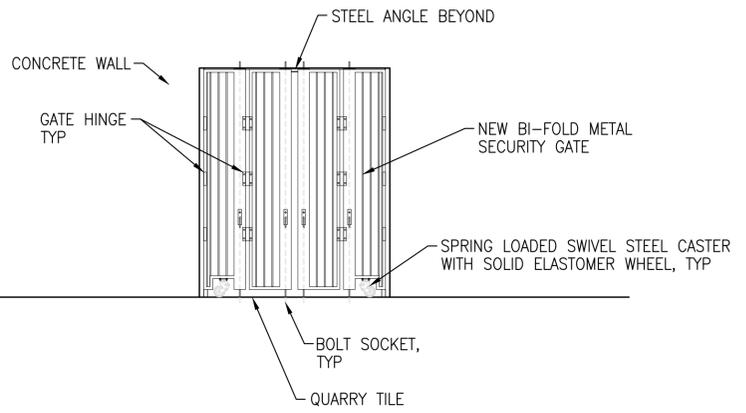

2 SECURITY GATE ELEVATION
A-204 SCALE: 1/4" = 1'-0"

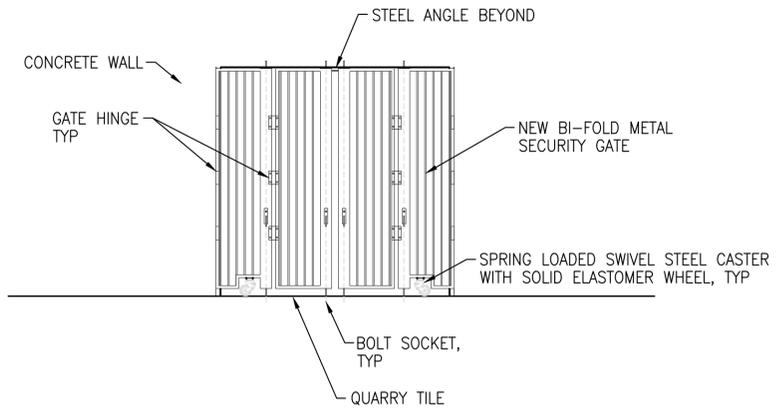

3 SECURITY GATE ELEVATION
A-204 SCALE: 1/4" = 1'-0"


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CONTRACT NO:		REVISIONS			
PROJECT NO:		BY	NO	DATE	DESCRIPTION
DESIGNED:	DATE:				
DRAFTED: DRE					
CHECKED:					
APPROVED:					




VIRGINIA RAILWAY EXPRESS
ALEXANDRIA
PEDESTRIAN TUNNEL


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ARCHITECTURAL SECURITY GATE PLAN, ELEVATIONS AND DETAILS		A-204
SCALE: 3/32" = 1'-0"	DATE ISSUED: 5/25/16	LIST NO:

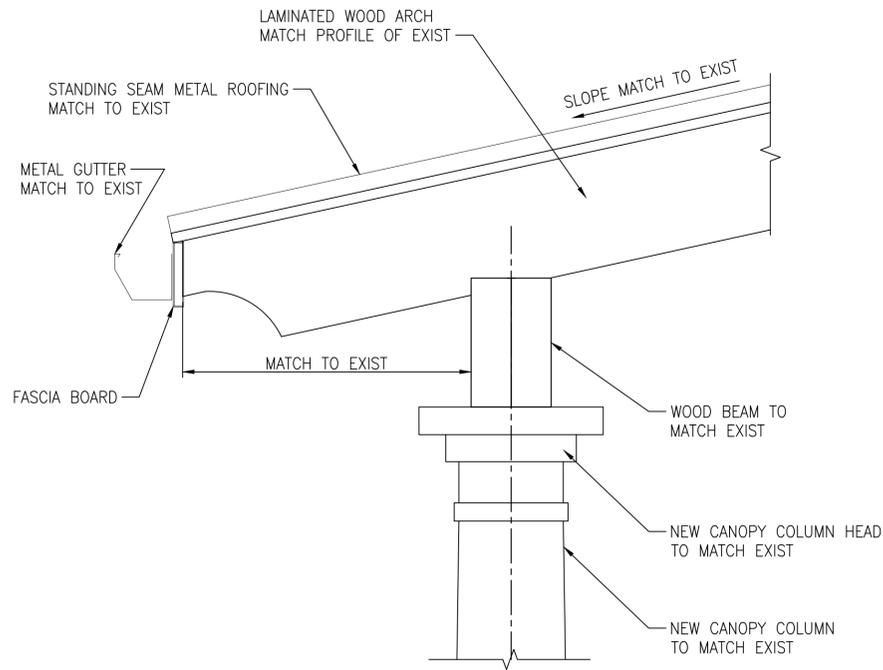


1
A-205
TYPICAL CANOPY DETAIL
SCALE: 1 1/2" = 1'-0"

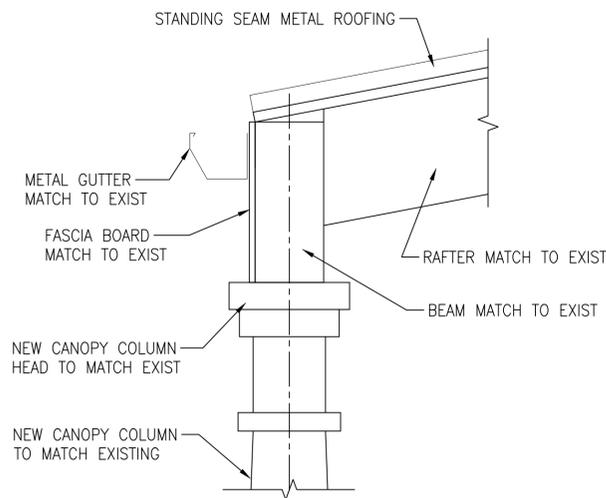


3
A-205
TYPICAL CANOPY DETAIL
SCALE: 1 1/2" = 1'-0"

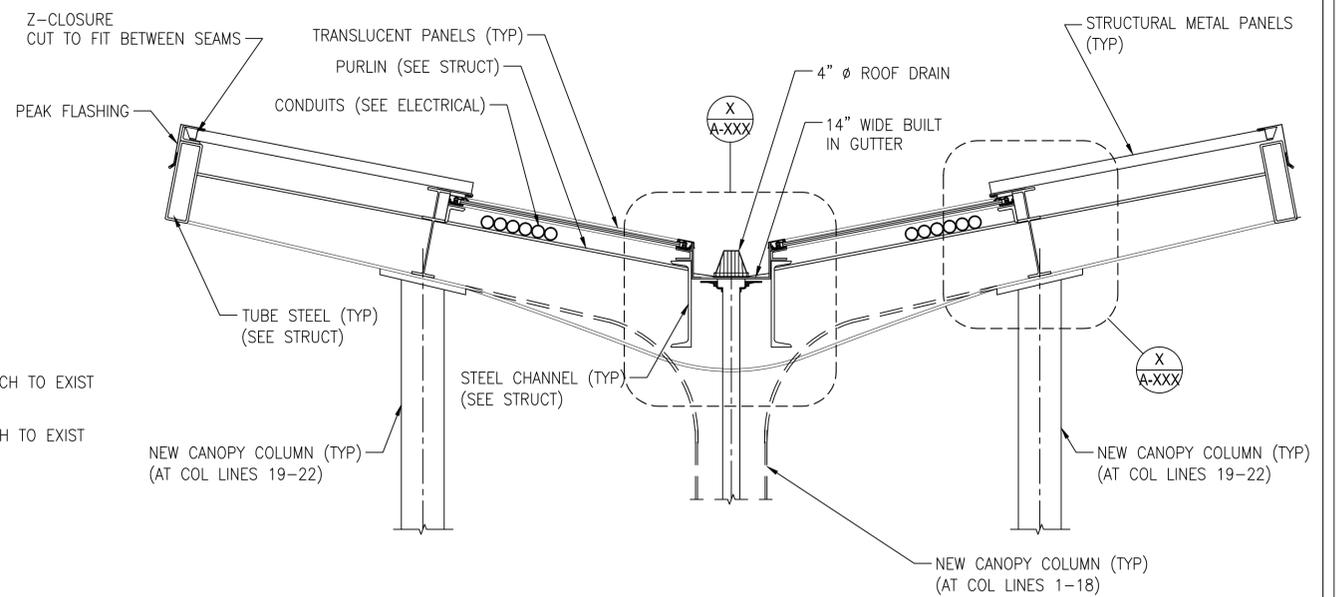


5
A-205
TYPICAL CANOPY SECTION
SCALE: 3/4" = 1'-0"

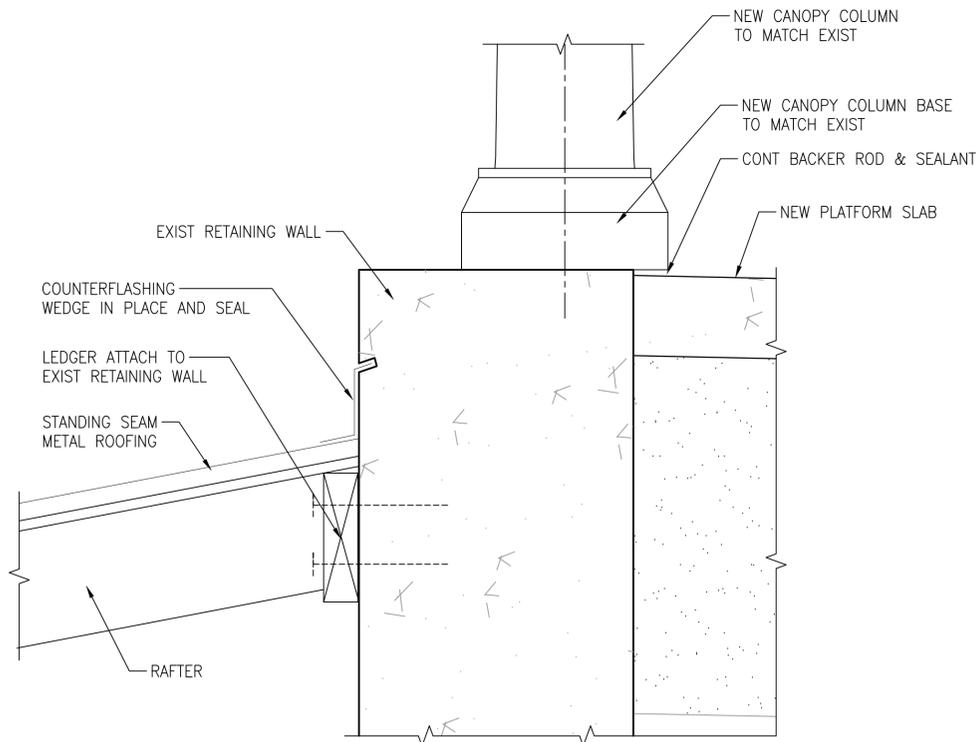

2
A-205
TYPICAL CANOPY DETAIL
SCALE: 1 1/2" = 1'-0"

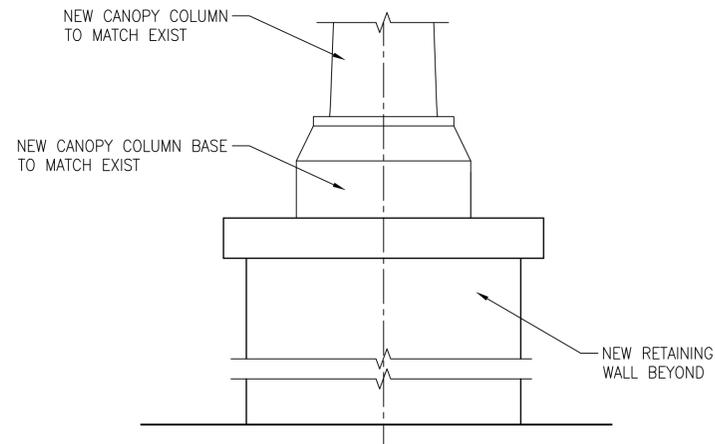

4
A-205
TYPICAL CANOPY DETAIL
SCALE: 1 1/2" = 1'-0"

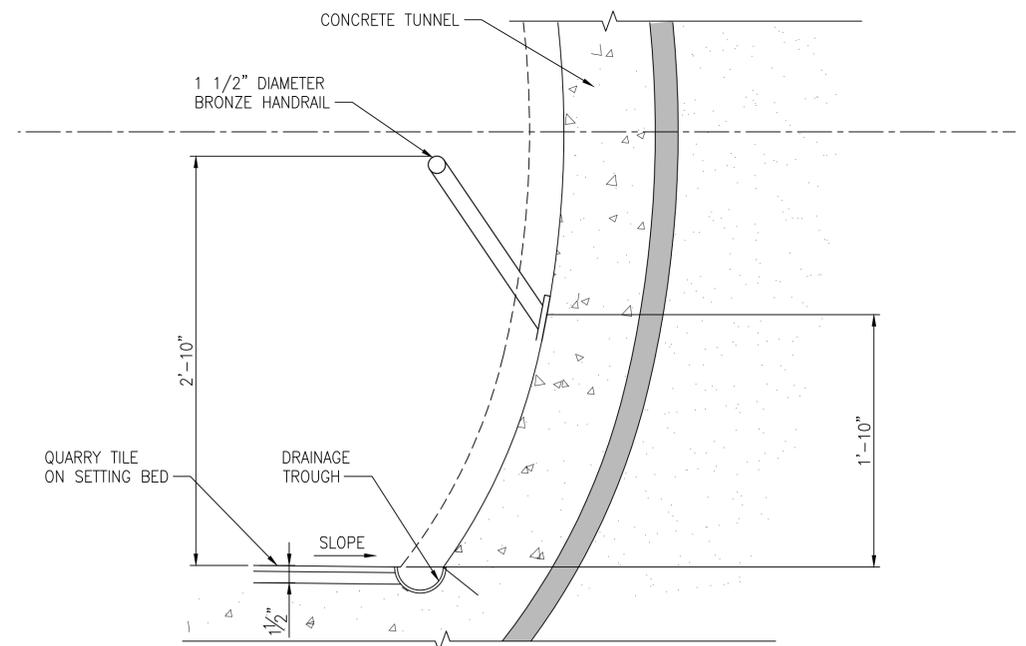

6
A-205
TYPICAL CANOPY DETAIL
SCALE: 1 1/2" = 1'-0"


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CONTRACT NO:	REVISIONS			
PROJECT NO:	BY	NO	DATE	DESCRIPTION
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DRAFTED: LTN				
CHECKED:				
APPROVED:				




VIRGINIA RAILWAY EXPRESS
ALEXANDRIA
PEDESTRIAN TUNNEL

DISCIPLINE:	DRAWING NO:
ARCHITECTURAL CANOPY AND TUNNEL DETAILS	A-205
SCALE:	LIST NO:
AS SHOWN	
DATE ISSUED:	
5/25/16	

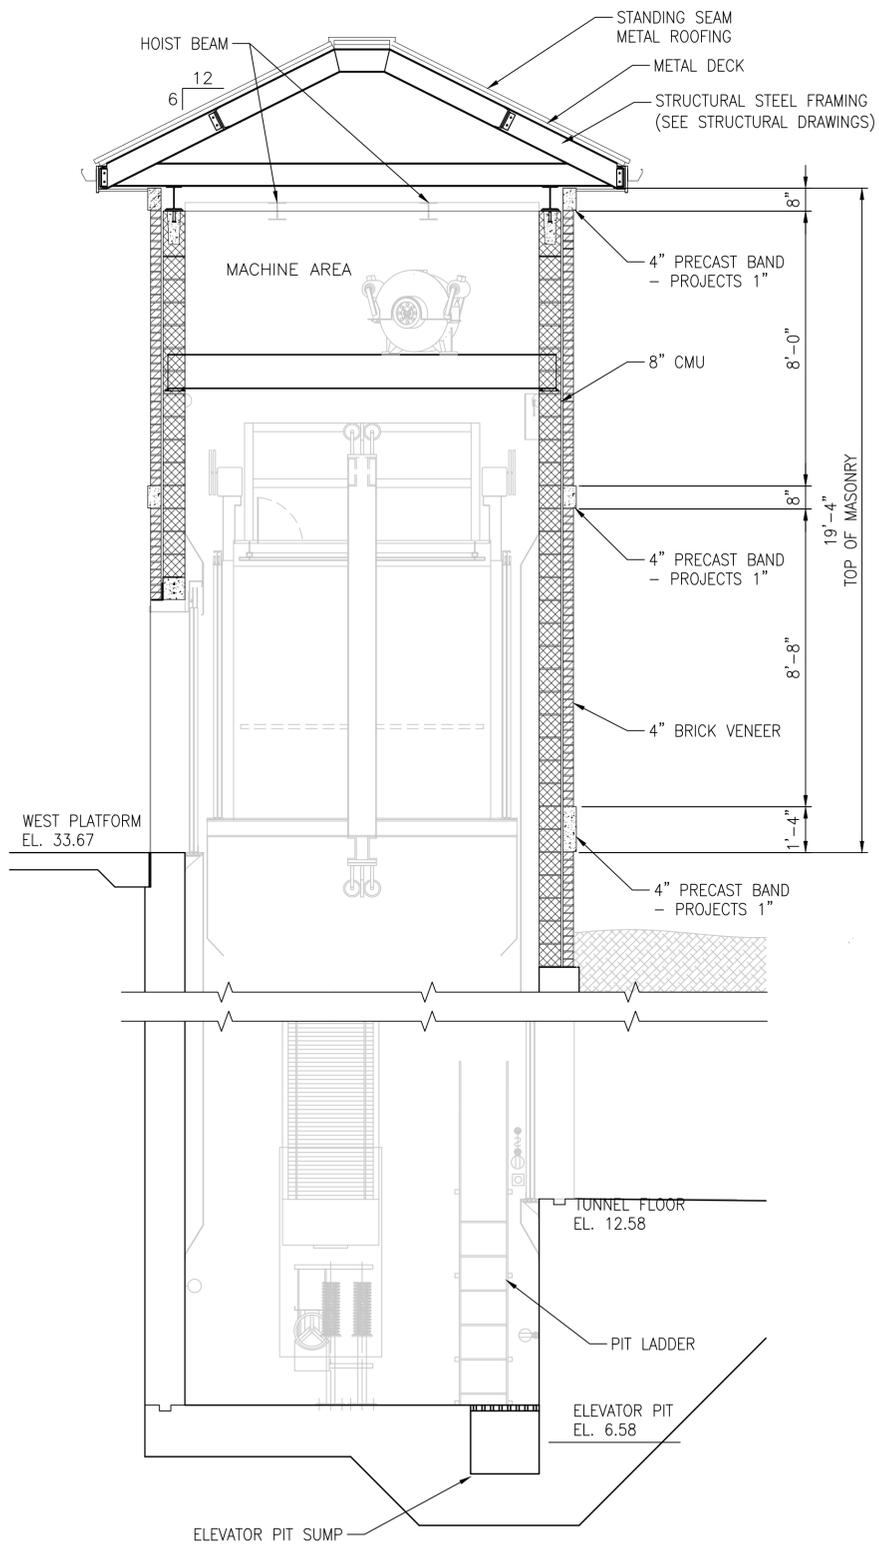

1 WEST PLATFORM ELEVATOR SECTION
A-300 SCALE: 3/8" = 1'-0"

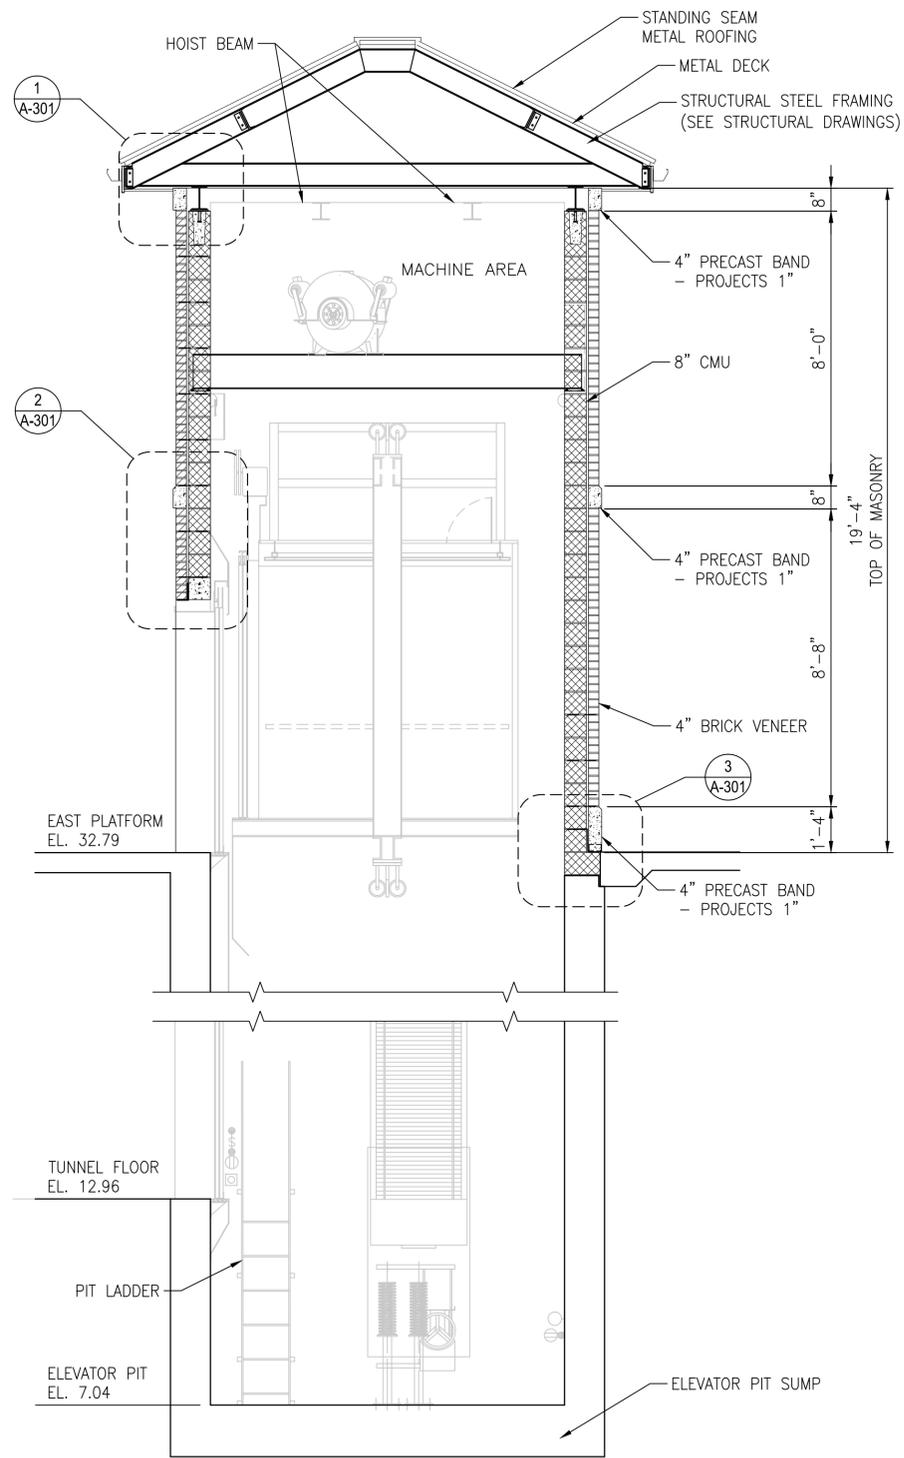

2 EAST PLATFORM ELEVATOR SECTION
A-300 SCALE: 3/8" = 1'-0"


60% SUBMITTAL

CONTRACT NO:		REVISIONS			
PROJECT NO:		BY	NO	DATE	DESCRIPTION
DESIGNED:	DRE			04/22/16	
DRAFTED:	DRE			04/25/16	
CHECKED:					
APPROVED:					




VIRGINIA RAILWAY EXPRESS
ALEXANDRIA
PEDESTRIAN TUNNEL


DISCIPLINE:		DRAWING NO:
ARCHITECTURAL		A-300
ELEVATOR 1		LIST NO:
SECTION		
SCALE:	DATE ISSUED:	
3/8" = 1'-0"	5/25/16	

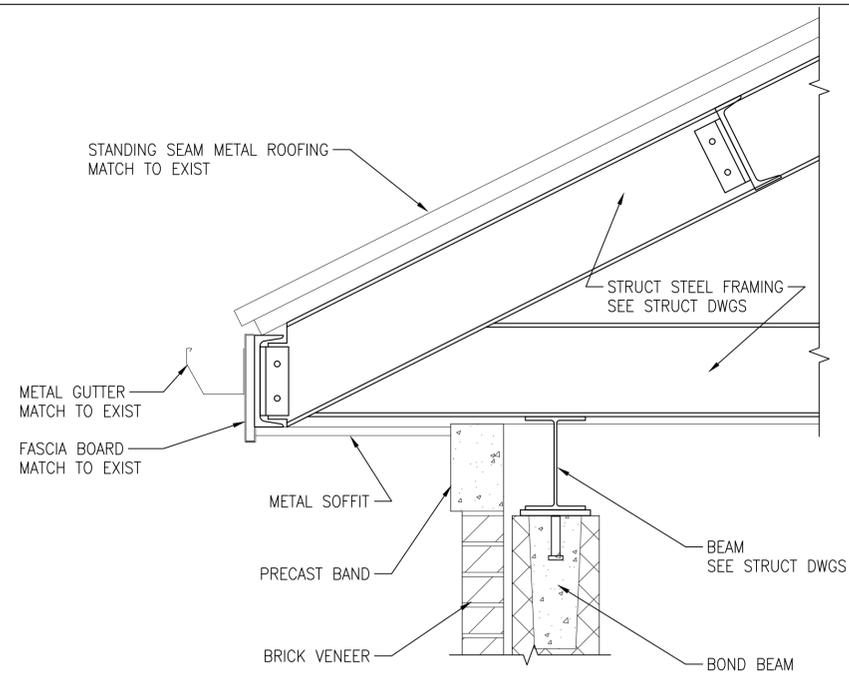

1
A-301 TYPICAL WALL DETAIL
SCALE: 1 1/2" = 1'-0"

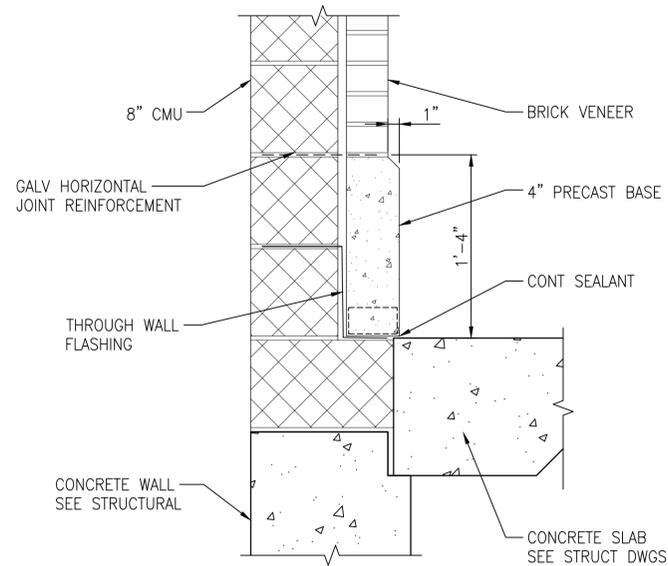

3
A-301 TYPICAL WALL DETAIL
SCALE: 1 1/2" = 1'-0"

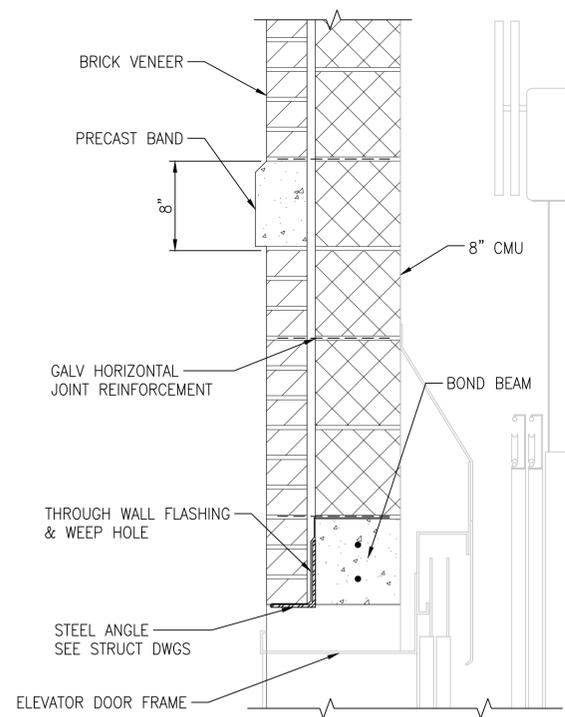

2
A-301 TYPICAL WALL DETAIL
SCALE: 1 1/2" = 1'-0"


60% SUBMITTAL

CONTRACT NO:		REVISIONS			
PROJECT NO:		BY	NO	DATE	DESCRIPTION
DESIGNED:	DRE 04/22/16				
DRAFTED:	DRE 04/25/16				
CHECKED:					
APPROVED:					



VIRGINIA RAILWAY EXPRESS
ALEXANDRIA
PEDESTRIAN TUNNEL

DISCIPLINE: ARCHITECTURAL WALL DETAILS		DRAWING NO: A-301
SCALE: 1 1/2" = 1'-0"	DATE ISSUED: 5/25/16	LIST NO:

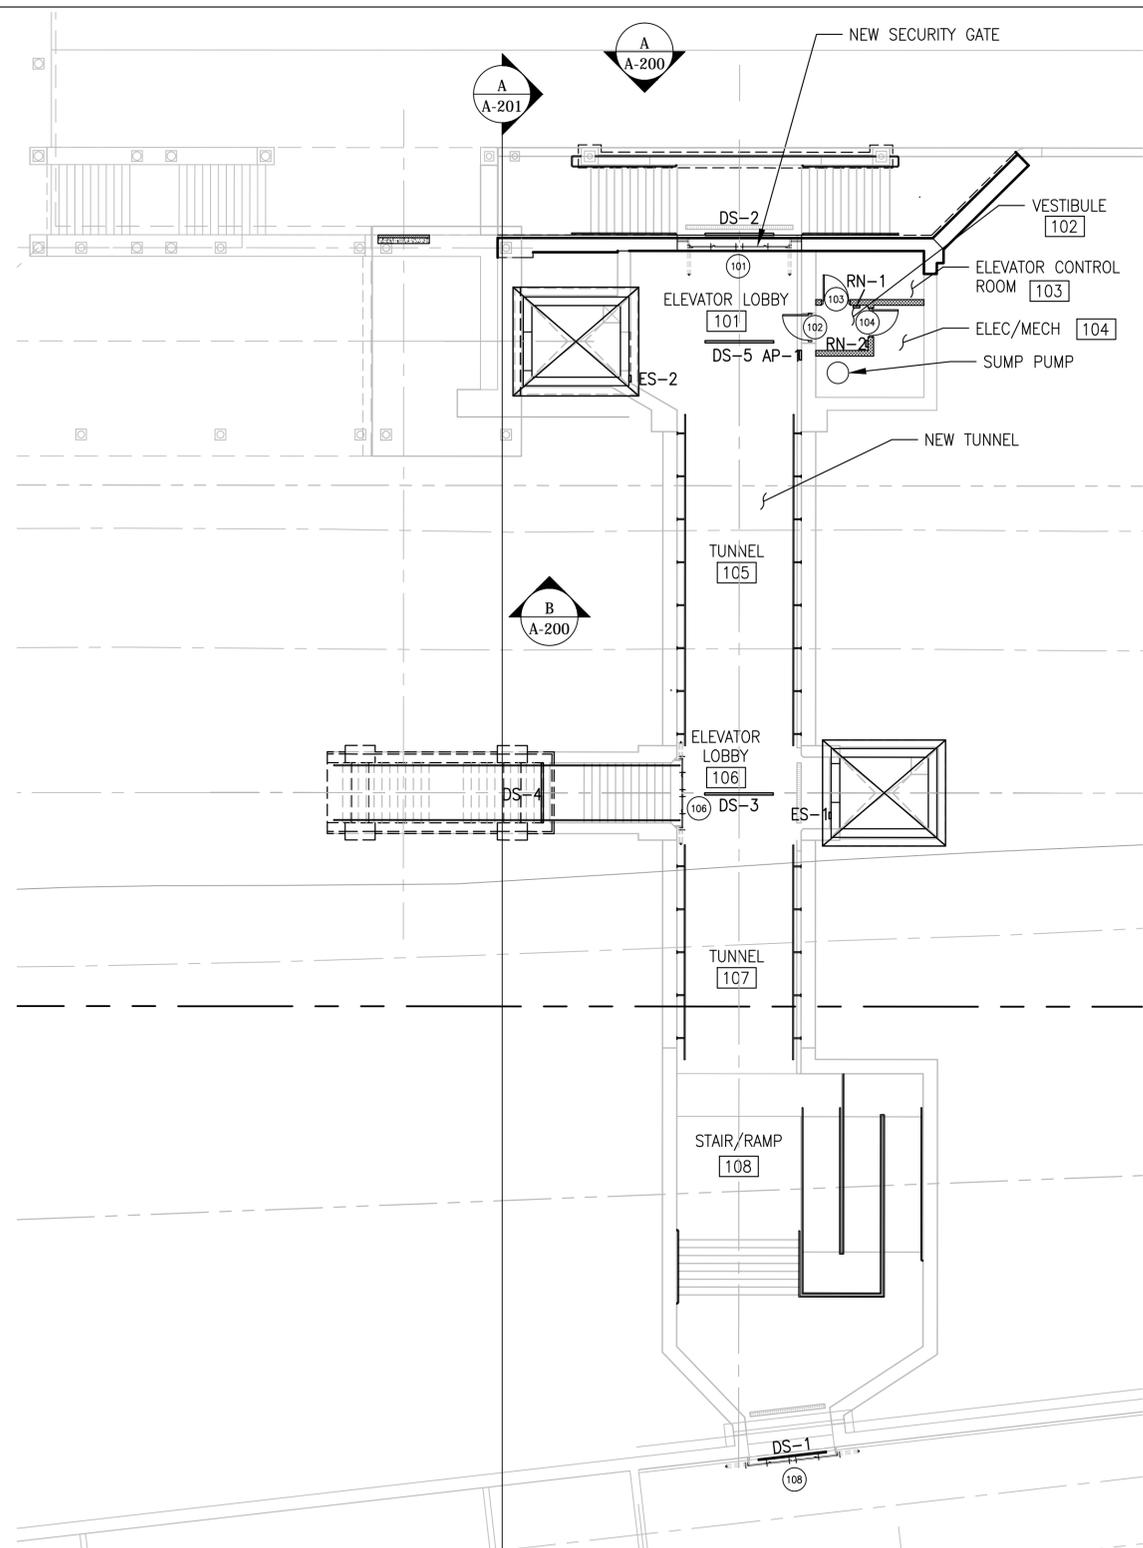


1 PARTIAL PLAN - SIGNAGE (TUNNEL LEVEL)
SCALE: 3/32" = 1'-0"


SIGN SCHEDULE

SEE DRAWINGS A-500 AND A-501 FOR SIGNAGE GRAPHIC DETAILS

SIGN	DESCRIPTION	MATERIALS	MOUNTING	REMARKS
DS-1	TO VRE-ALEXANDRIA STATION	ALUMINUM	WALL MOUNTED	WMATA SIGN
DS-2	TO VRE TRAINS / TO KING ST-OLD TOWN STATION	ALUMINUM	WALL MOUNTED	-
DS-3	TO VRE TRAINS EAST PLATFORM	VINYL	PENDANT MOUNTED	DBL-SIDED
DS-4	TO VRE WEST PLATFORM / PARKING / TO KING ST-OLD TOWN STATION	ALUMINUM	WALL MOUNTED	MOUNTED TO WALL @ ELEVATOR DOOR
DS-5	TO VRE TRAINS WEST PLATFORM	VINYL	WALL MOUNTED	MOUNTED TO WALL @ ELEVATOR DOOR
ES-1	ELEVATOR TO EAST PLATFORM / IN CASE OF FIRE	VINYL	PENDANT MOUNTED	-
ES-2	ELEVATOR TO WEST PLATFORM / IN CASE OF FIRE	VINYL	PENDANT MOUNTED	-
AP-1	AUTHORIZED PERSONNEL ONLY	ALUMINUM	WALL MOUNTED	-
RN-1	ROOM 103	ALUMINUM	WALL MOUNTED	-
RN-2	ROOM 104	ALUMINUM	WALL MOUNTED	-
AB-1	ASSISTED BOARDING AREA SIGN (WEST FACE)	VINYL	PENDANT MOUNTED	-
AB-2	ASSISTED BOARDING AREA SIGN (EAST FACE)	VINYL	PENDANT MOUNTED	-
AB-3	ASSISTED BOARDING AREA SIGN	ALUMINUM	POLE MOUNTED	-
EX-1	EXIT SIGN	VINYL	PENDANT MOUNTED	-
EX-2	EXIT SIGN	ALUMINUM	WALL MOUNTED	-
FN-1	FAIR NOTICE SIGN	VINYL	PENDANT MOUNTED	-
FN-3	THANK YOU FOR RIDING	VINYL	PENDANT MOUNTED	-
NT-1	NO TRESPASSING SIGN	ALUMINUM	WALL MOUNTED	-
PN-1	PLATFORM NOTICE SIGN	VINYL	PENDANT MOUNTED	-
PR-1	PROHIBITIONS SIGN	ALUMINUM	POLE MOUNTED	-
SC-1	SECURITY NOTICE SIGN	ALUMINUM	WALL MOUNTED	-
SM-1	SYSTEM MAP	-	-	-
SN-1	STATION NAME SIGN	ALUMINUM	POLE MOUNTED	-
SN-2	STATION NAME SIGN	VINYL	PENDANT MOUNTED	-

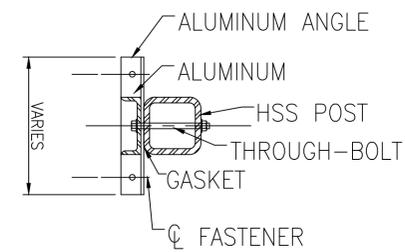

3 SECTION THROUGH POST
SCALE: 1 1/2" = 1'-0"

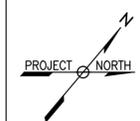


60% SUBMITTAL

CONTRACT NO:	REVISIONS			
PROJECT NO:	BY	NO	DATE	DESCRIPTION
DESIGNED:				
DRAFTED: DRE				
CHECKED:				
APPROVED:				





VIRGINIA RAILWAY EXPRESS
ALEXANDRIA
PEDESTRIAN TUNNEL

DISCIPLINE:	DRAWING NO:
ARCHITECTURAL SIGNAGE PLAN & SCHEDULE	A-400
SCALE: 3/32" = 1'-0"	LIST NO:
DATE ISSUED: 5/25/16	

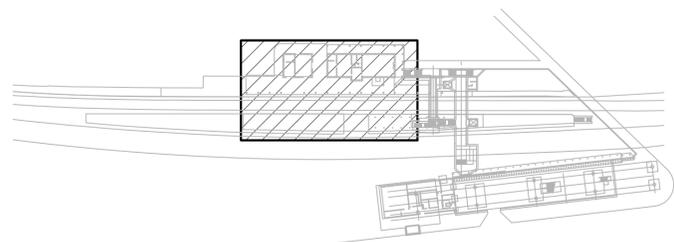

KEY PLAN
SCALE: 1/128" = 1'-0"

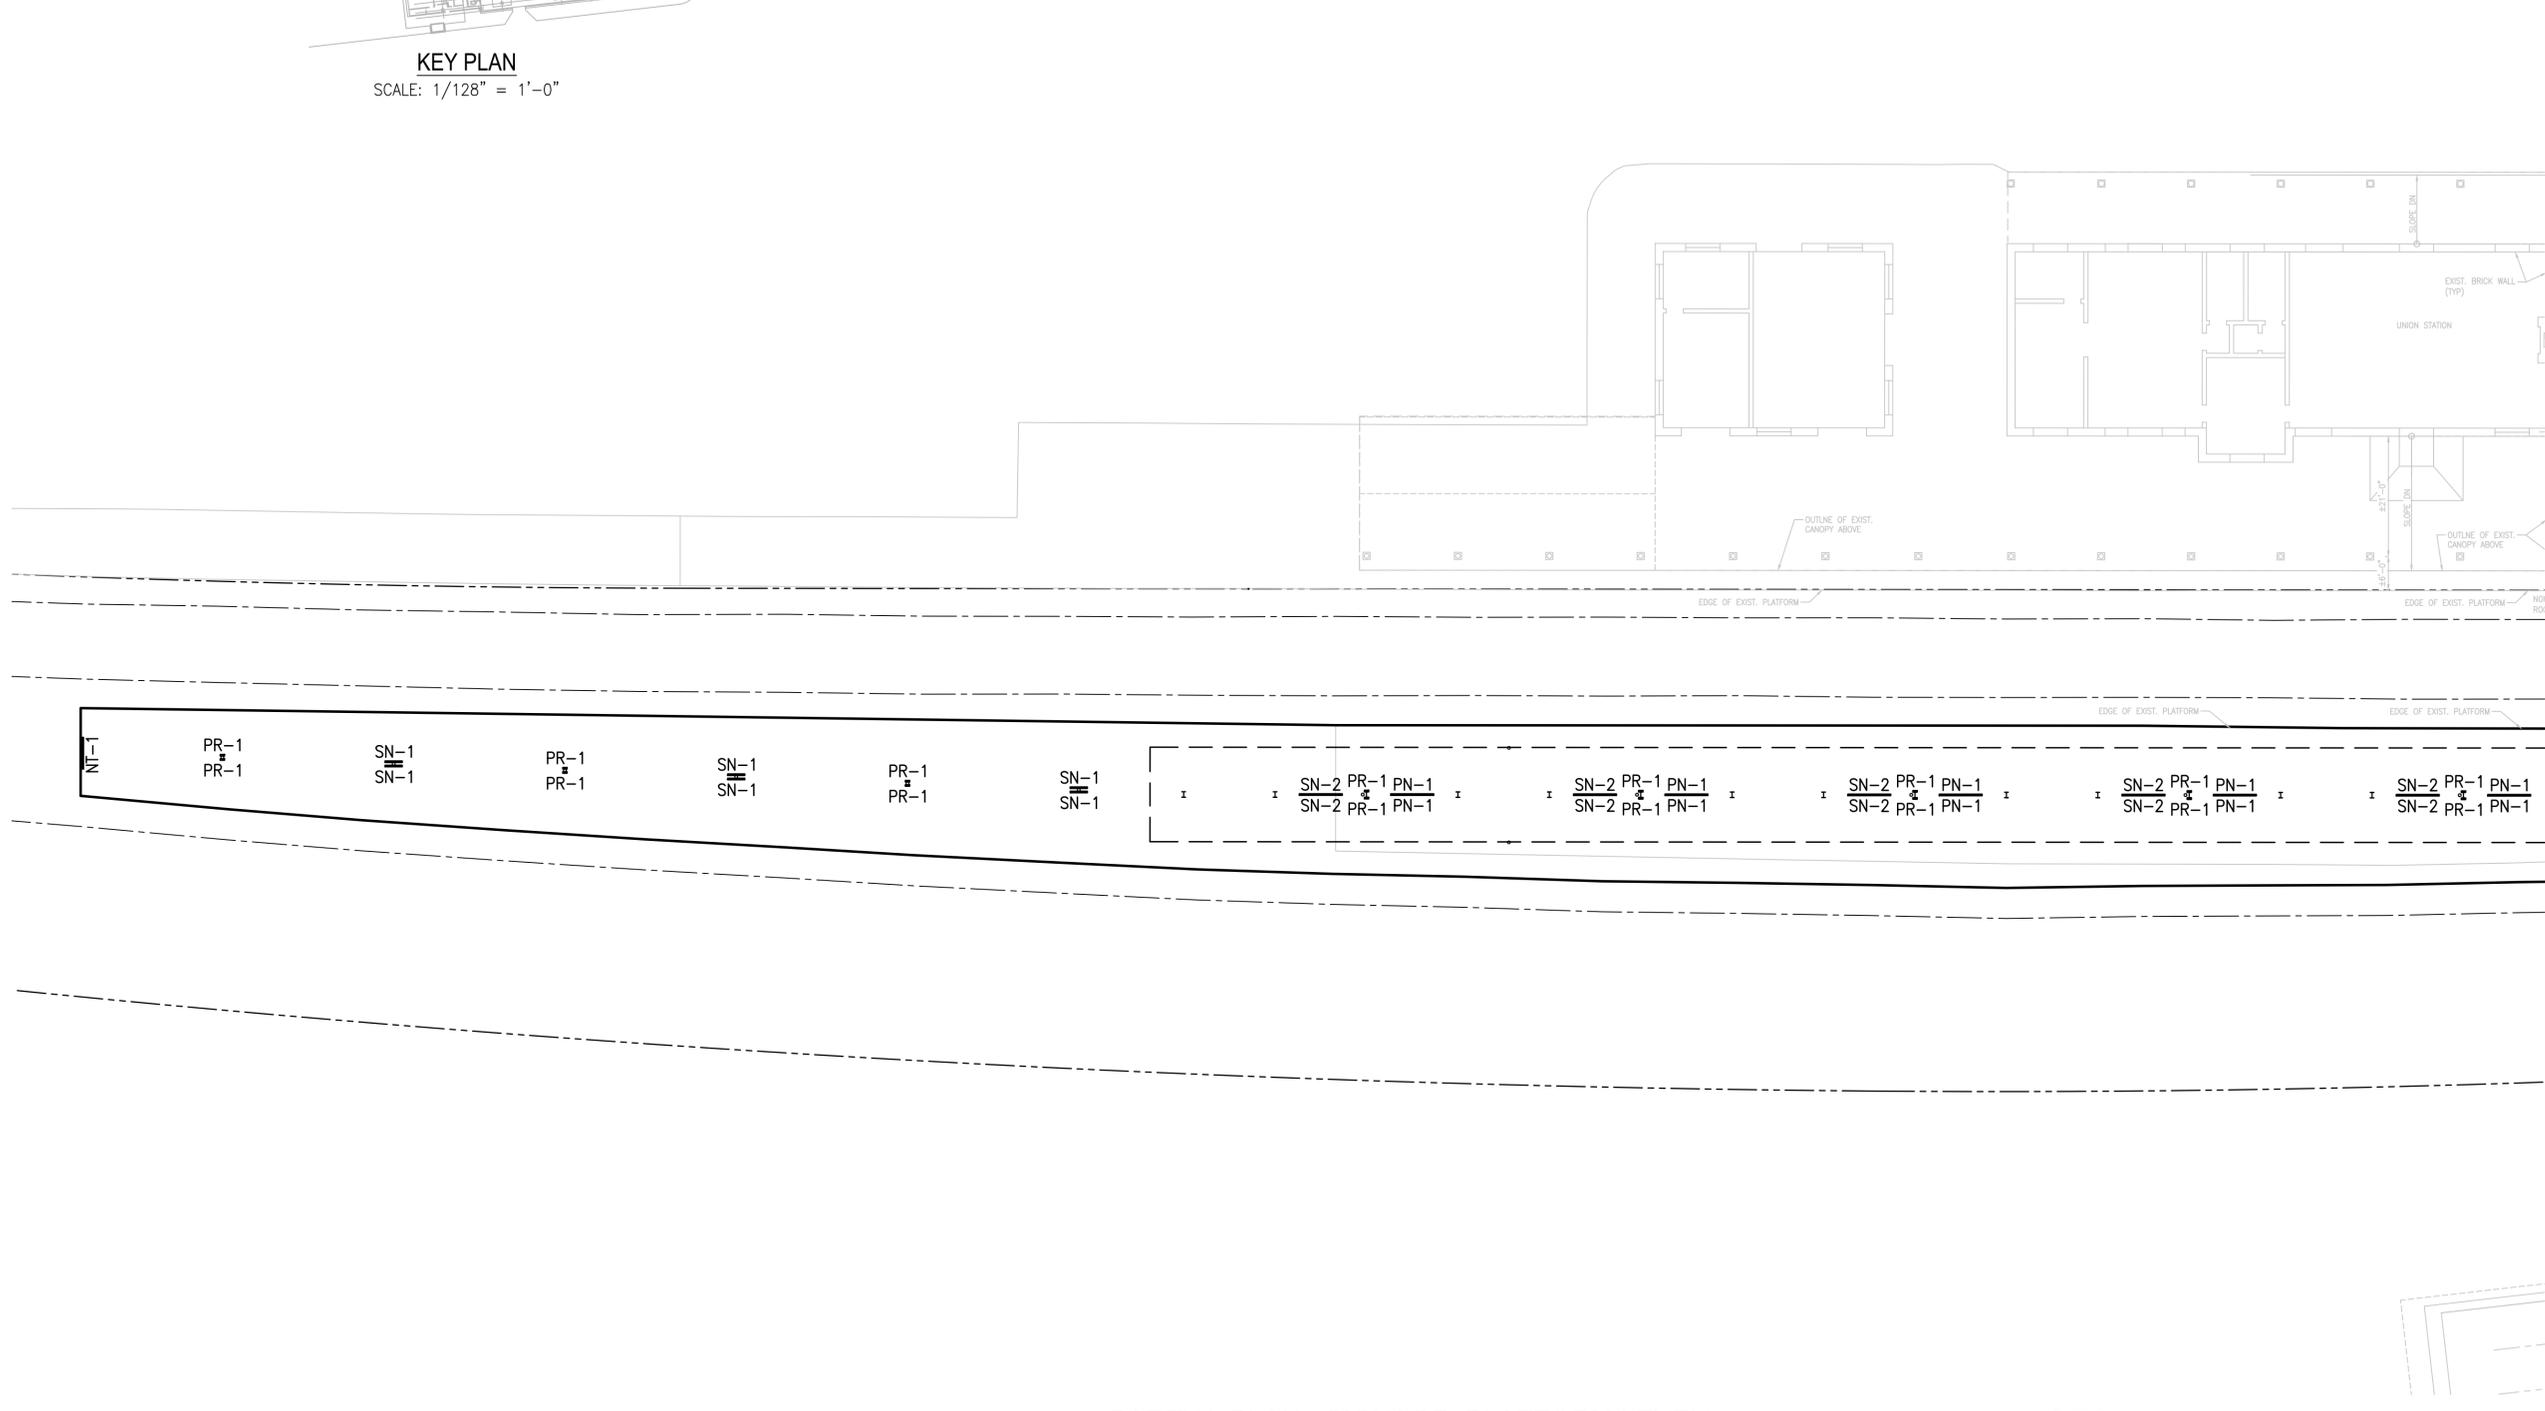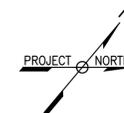

PR-1 PR-1	SN-1 SN-1	PR-1 PR-1	SN-1 SN-1	PR-1 PR-1	SN-1 SN-1	SN-2 PR-1 PN-1 SN-2 PR-1 PN-1				
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1
A-401 PARTIAL PLAN - SIGNAGE (PLATFORM LEVEL)
SCALE: 1/16" = 1'-0"

NOTES:

- FOR GENERAL NOTES, REFER TO DRAWINGS A-001.



60% SUBMITTAL

CONTRACT NO:		REVISIONS			
PROJECT NO:		BY	NO	DATE	DESCRIPTION
DESIGNED:	IA				
DRAFTED:	LTN				
CHECKED:	MA/DB				
APPROVED:					




VIRGINIA RAILWAY EXPRESS
ALEXANDRIA
PEDESTRIAN TUNNEL

DISCIPLINE:		DRAWING NO:
ARCHITECTURAL PLATFORM SIGNAGE/CANOPY PLAN		A-401
SCALE:	DATE ISSUED:	LIST NO:
1/16" = 1'-0"	5/25/16	

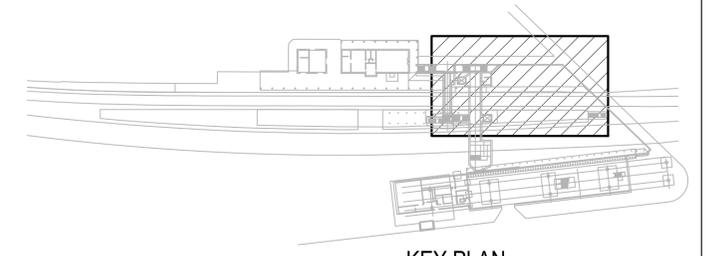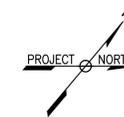

KEY PLAN
SCALE: 1/128" = 1'-0"

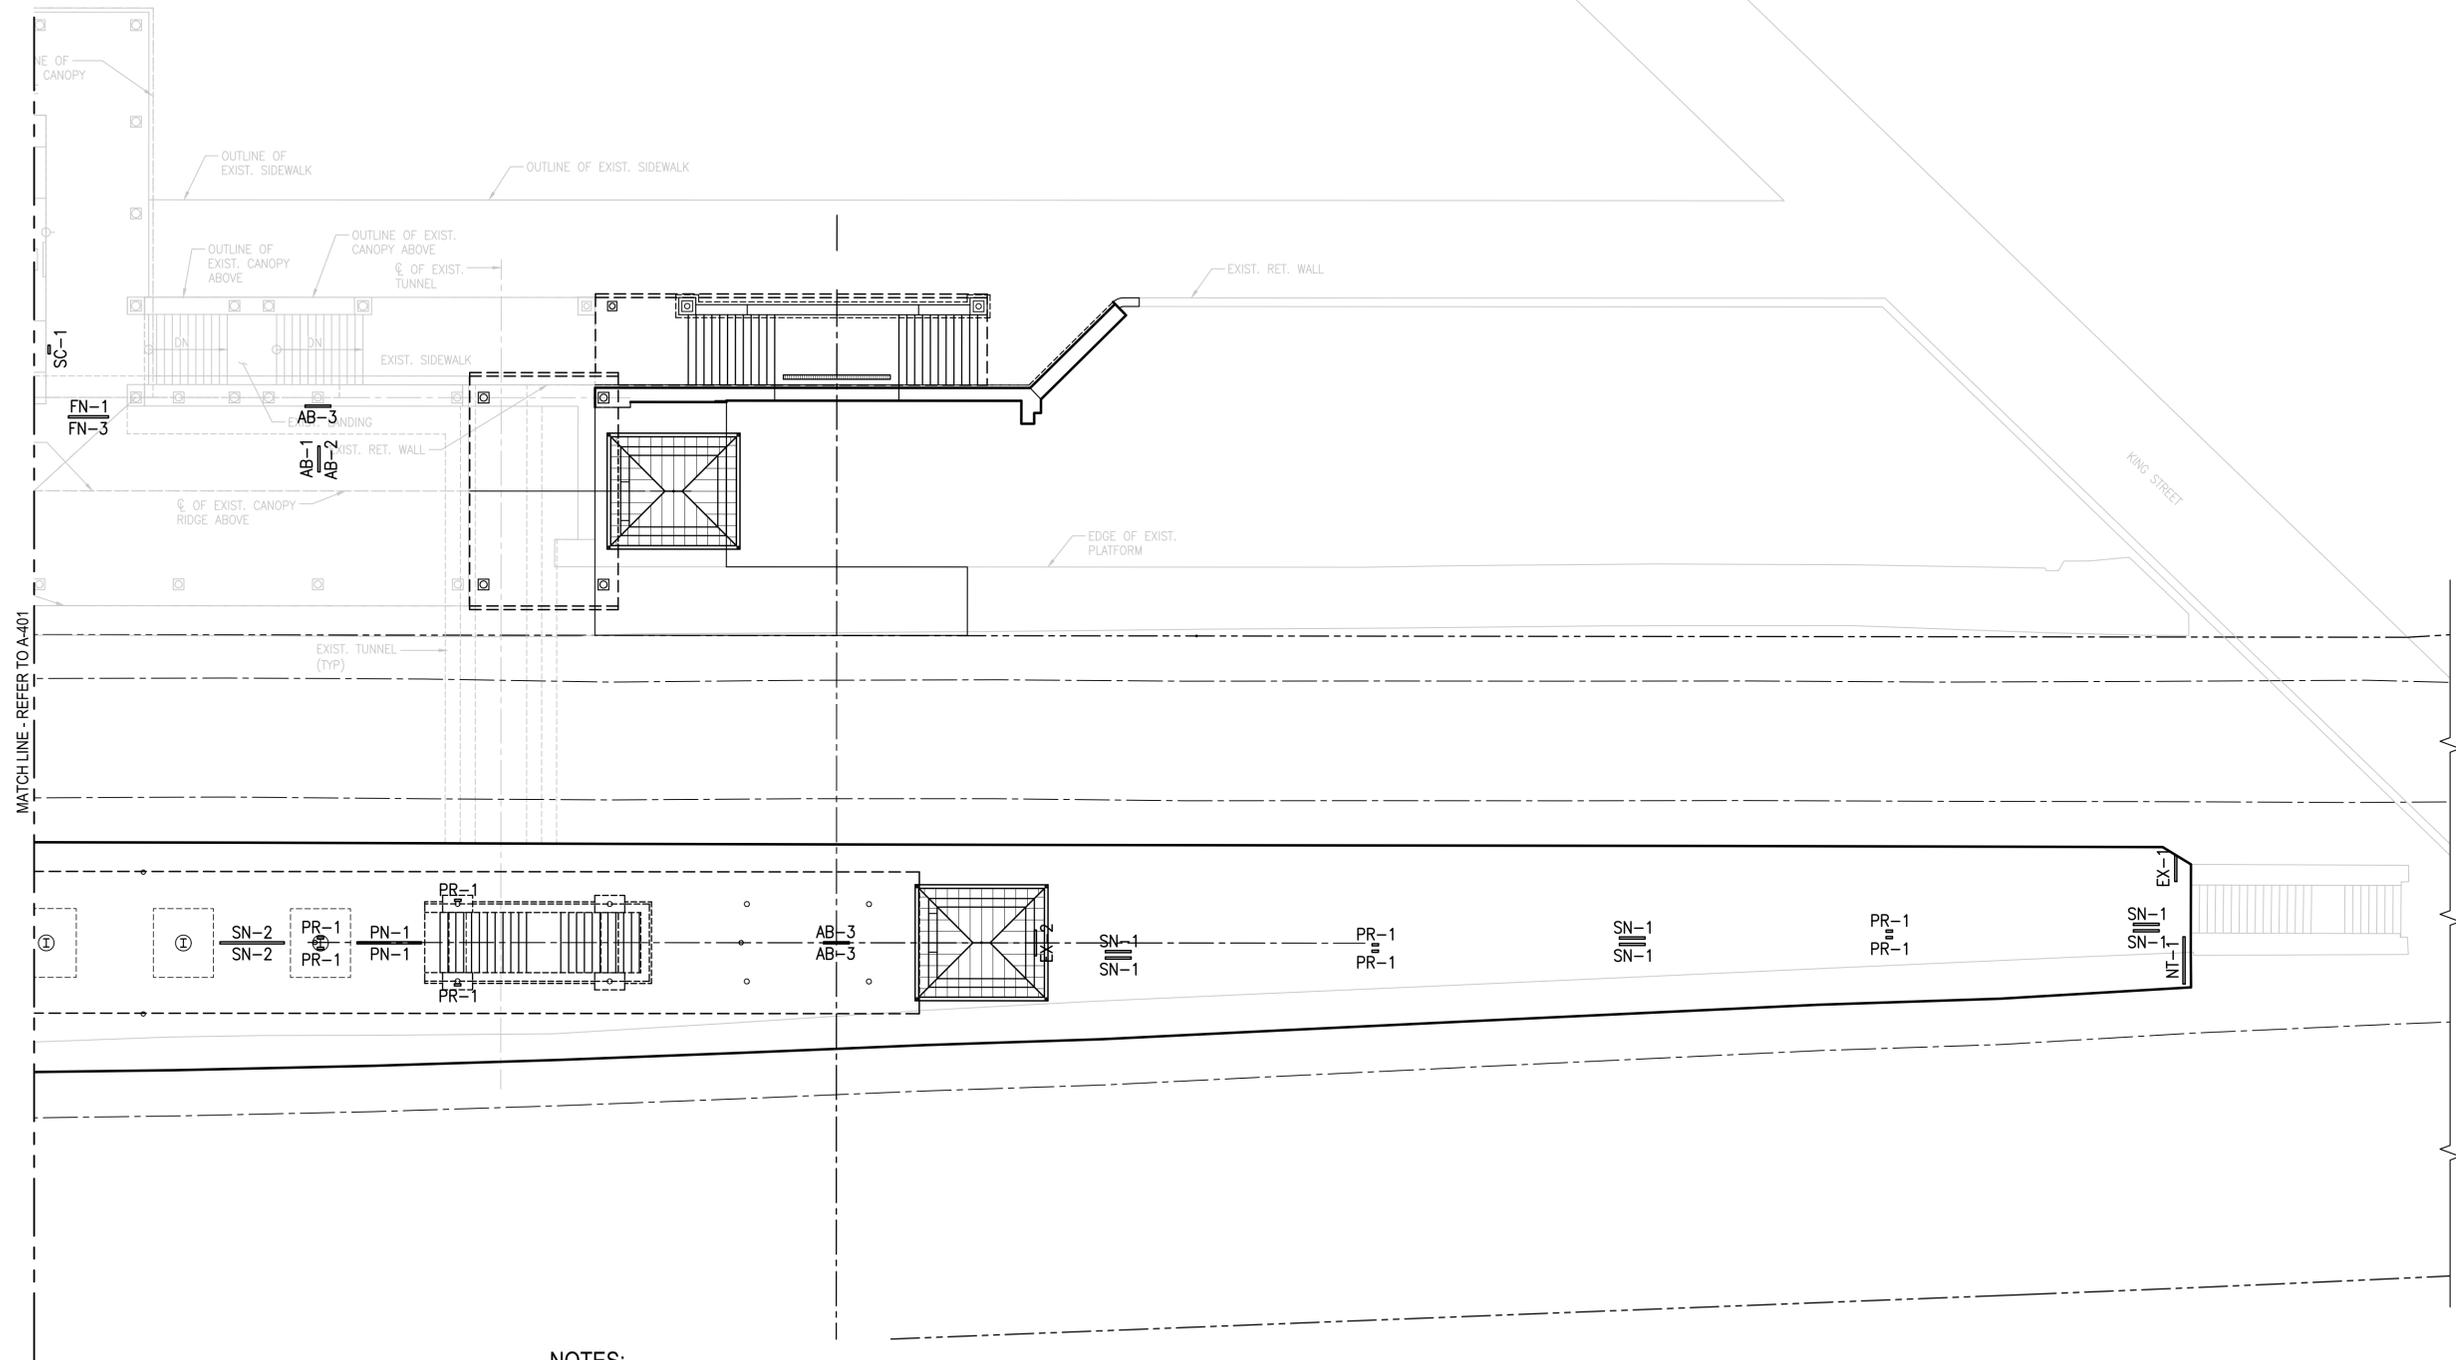

NOTES:
1. FOR GENERAL NOTES, REFER TO DRAWINGS A-001.

1
A-103 **PARTIAL PLAN - SIGNAGE (PLATFORM LEVEL)**
SCALE: 3/32" = 1'-0"

60% SUBMITTAL

CONTRACT NO:		REVISIONS			
PROJECT NO:		BY	NO	DATE	DESCRIPTION
DESIGNED:	IA				
DRAFTED:	LTN				
CHECKED:	MA/DB				
APPROVED:					



VIRGINIA RAILWAY EXPRESS
**ALEXANDRIA
PEDESTRIAN TUNNEL**

DISCIPLINE:		DRAWING NO:
ARCHITECTURAL PLATFORM SIGNAGE/CANOPY PLAN		A-402
SCALE:	DATE ISSUED:	LIST NO:
3/32" = 1'-0"	5/25/16	



(WMATA SIGNAGE TYPE ONLY)

DS-1

NOTE: REFER TO WMATA METRORAIL SYSTEM SIGNAGE DESIGN MANUAL, RELEASE DATE 01/2016.



FN-3



AB-1 (WEST FACE)



AB-1 (EAST FACE)




NO TRESSPASSING SIGN (NT-1)



EX-1



EX-2

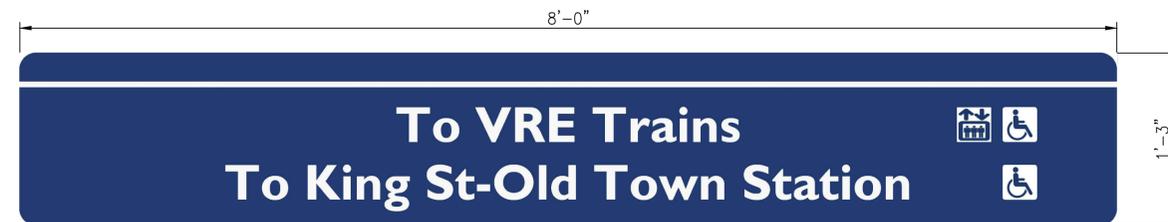


DIRECTIONAL SIGN (DS-2)

NOTES:

- REFER TO AMTRAK GRAPHIC SIGNAGE STANDARDS MANUAL FOR VRE SIGNAGE CRITERIA.
- ALL PENDANT SIGNS SHOULD BE MOUNTED TIGHT TO UTILITIES.



ASSISTED BOARDING AREA SIGN (AB-3)

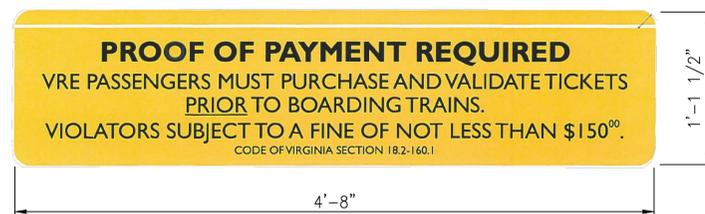

FN-1

SIGNAGE GRAPHICS
SCALE: 1 1/2" = 1'-0"

60% SUBMITTAL

CONTRACT NO:	REVISIONS			
	BY	NO	DATE	DESCRIPTION
PROJECT NO:				
DESIGNED:				
DRAFTED: CLR				
CHECKED:				
APPROVED:				



VIRGINIA RAILWAY EXPRESS
ALEXANDRIA
PEDESTRIAN TUNNEL

DISCIPLINE:	DRAWING NO:
ARCHITECTURAL SIGNAGE GRAPHICS & DETAILS	A-500
SCALE: 1 1/2" = 1'-0"	LIST NO:
DATE ISSUED: 5/25/16	




PLATFORM NOTICE SIGN (PN-1)




PROHIBITIONS SIGN (PR-1)



SECURITY NOTICE SIGN (SC-1)

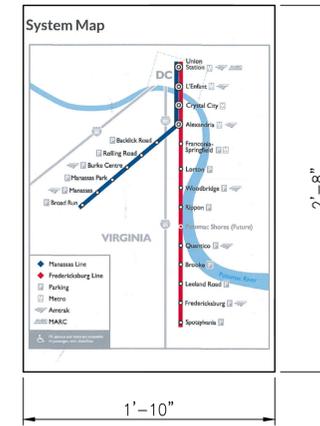

SM-1

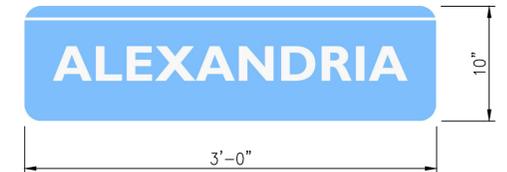

SN-1




NOTE: MIRROR GRAPHIC INFORMATION ON OTHER SIDE OF SIGN


DIRECTIONAL SIGN (DS-3)



DIRECTIONAL SIGN (DS-4)

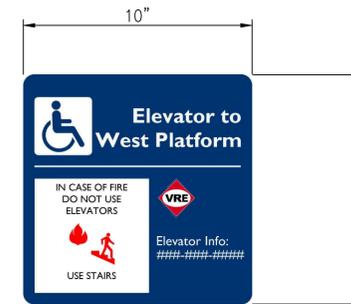

ELEVATOR SAFETY SIGN (ES-1)

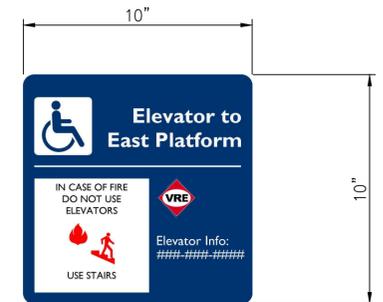

ELEVATOR SAFETY SIGN (ES-2)




NOTE: MIRROR GRAPHIC INFORMATION ON OTHER SIDE OF SIGN


DIRECTIONAL SIGN (DS-5)



AUTHORIZED PERSONNEL SIGN (AP-1)

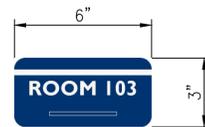

ROOM NUMBER SIGN (RN-1)

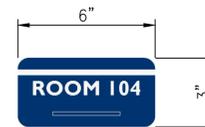

ROOM NUMBER SIGN (RN-2)

NOTES:

- REFER TO AMTRAK GRAPHIC SIGNAGE STANDARDS MANUAL FOR VRE SIGNAGE CRITERIA.
- ALL PENDANT SIGNS SHOULD BE MOUNTED TIGHT TO UTILITIES.

1 SIGNAGE GRAPHICS SCALE: 1 1/2" = 1'-0"

60% SUBMITTAL

CONTRACT NO:	REVISIONS			
	BY	NO	DATE	DESCRIPTION
PROJECT NO:				
DESIGNED:				
DRAFTED: CLR				
CHECKED:				
APPROVED:				



VIRGINIA RAILWAY EXPRESS
ALEXANDRIA
PEDESTRIAN TUNNEL

DISCIPLINE:	DRAWING NO:
ARCHITECTURAL SIGNAGE GRAPHICS & DETAILS	A-501
SCALE: 1 1/2" = 1'-0"	LIST NO:
DATE ISSUED: 5/25/16	

SYMBOL LEGEND			SYMBOL LEGEND CONTD.			ABBREVIATIONS			GENERAL NOTES (APPLICABLE TO ALL ELECTRICAL WORK)		
SYMBOL	DESCRIPTION	MOUNTING HEIGHT	SYMBOL	DESCRIPTION	MOUNTING HEIGHT						
	208/120V PANELBOARD, SURFACE MOUNTED	78" TO TOP		CCTV CAMERA	= =	A	AMPERES	KVA	KILOVOLT AMPERES	<ol style="list-style-type: none"> PROVIDE ALL LABOR, MATERIALS, TOOLS, EQUIPMENT, COORDINATION, ADDITIONAL DESIGN AND ALL INCIDENTALS NECESSARY TO PROVIDE A COMPLETE AND OPERABLE SYSTEM AS DETAILED ON PLANS TO THE SATISFACTION OF THE ENGINEER AND THE OWNER. COORDINATE ALL WORK WITH THE ENGINEER BEFORE THE START OF WORK. ALL WORK SHALL BE PERFORMED BY A QUALIFIED ELECTRICAL CONTRACTOR LICENSED IN THE STATE OF VIRGINIA THAT HAS PREVIOUSLY PERFORMED WORK OF THIS SIZE AND TYPE. PRIOR TO SUBMITTING BID, THE CONTRACTOR SHALL VISIT THE SITE AND BE THOROUGHLY FAMILIAR WITH THE EXISTING CONDITIONS AND PROPOSED CONSTRUCTION. CONTRACTOR SHALL INCLUDE IN THEIR BID ALL MATERIAL, LABOR AND ALL INCIDENTALS FOR A COMPLETE INSTALLATION WHETHER SPECIFICALLY CALLED FOR OR NOT. ALL ERRORS, DISCREPANCIES AND MISSED ITEMS SHALL BE BROUGHT TO THE ATTENTION OF THE ENGINEER DURING THE BIDDING PROCESS BY THE CONTRACTOR. THESE ITEMS SHALL BE INCLUDED IN THE BID PRICE. NO EXTRA COST WILL BE ALLOWED FOR ANY DISCREPANCY WHICH COULD HAVE BEEN NOTICED AT THE SITE VISIT BY THE CONTRACTOR. PERFORM WORK AS REQUIRED BY APPLICABLE CODES, REGULATIONS AND LAWS OF LOCAL, STATE AND FEDERAL GOVERNMENTS AND OTHER AUTHORITIES WITH LAWFUL JURISDICTION. ALL WORK SHALL BE IN ACCORDANCE WITH THE LATEST EDITION OF THE NATIONAL ELECTRICAL CODE. ALL WORK SHALL BE IN ACCORDANCE WITH REQUIREMENTS OF LOCAL AUTHORITY HAVING JURISDICTION. MATERIAL AND EQUIPMENT SHALL BE UL, NEMA, ANSI, IEEE, ADA & CBM APPROVED FOR INTENDED SERVICE. MATERIAL AND INSTALLATION SHALL MEET REQUIREMENTS OF NATIONAL AND STATE ELECTRICAL CODE. GIVE NOTICES, FILE PLANS, OBTAIN PERMITS AND LICENSES, PAY FEES AND BACK CHARGES, AND OBTAIN NECESSARY APPROVALS FROM AUTHORITIES THAT HAVE JURISDICTION. IT IS THE CONTRACTOR'S RESPONSIBILITY TO DETERMINE THE REQUIRED NOTICES, PERMITS, LICENSES, FEES, BACK CHARGES AND APPROVALS REQUIRED FOR THIS PROJECT. MAINTAIN RECORD DRAWINGS ON SITE. RECORD SET MUST BE COMPLETE AND CURRENT AND AVAILABLE FOR INSPECTION WHEN REQUISITIONS FOR PAYMENT ARE SUBMITTED. GUARANTEE WORK IN WRITING FOR TWO YEARS FROM DATE OF FINAL ACCEPTANCE. REPAIR OR REPLACE DEFECTIVE MATERIALS OR INSTALLATION AT NO COST TO OWNER DURING THE GUARANTEE PERIOD. CORRECT DAMAGE CAUSED IN MAKING NECESSARY REPAIRS AND REPLACEMENTS UNDER GUARANTEE AT NO COST TO OWNER. SUBMIT GUARANTEE TO OWNER BEFORE FINAL PAYMENT. COORDINATE ALL ELECTRICAL ITEMS WITH EXISTING FIELD CONDITIONS. LOCATIONS SHOWN ARE APPROXIMATE AND MAY REQUIRE MINOR ADJUSTMENT IN THE FIELD TO SATISFY THE DESIGN INTENT. THE LOCATIONS SHOWN ON THESE PLANS ARE APPROXIMATE AND REQUIRE COORDINATION WITH ALL OTHER TRADES AND VERIFICATION OF EXISTING CONDITIONS. ROUTING OF CONDUIT IS DIAGRAMMATIC IN NATURE AND NOT INTENDED TO SHOW ALL REQUIRED OFFSETS AND DETAILS. THE CONTRACTOR IS RESPONSIBLE FOR FIELD VERIFICATION OF ALL EXISTING ASSOCIATED EQUIPMENT AND CONDITIONS. COORDINATE THE LOCATION OF ALL EQUIPMENT WITH THE ENGINEER AND THE OWNER. CONTRACTOR IS RESPONSIBLE FOR OBTAINING ALL OTHER TRADES' DRAWINGS AND SPECIFICATIONS AND COORDINATING WITH ALL OTHER TRADES DURING BIDDING AND CONSTRUCTION. CONTRACTOR SHALL BE RESPONSIBLE FOR MAINTAINING CONTINUITY OF ALL POWER, CONTROL, AND COMMUNICATION FUNCTIONS TO ALL AREAS AFFECTED BY DEMOLITION AND/OR NEW CONSTRUCTION. CONTRACTOR SHALL NOT CUT ANY ACTIVE ELECTRICAL OR COMMUNICATIONS LINES DURING CONSTRUCTION. IF THE CONTRACTOR ACCIDENTALLY CUTS A LINE, THEN THEY SHALL CONTACT THE ENGINEER IMMEDIATELY BEFORE PROCEEDING WITH FURTHER WORK. CONTRACTOR SHALL SUBMIT FOR APPROVAL, SHOP DRAWINGS FOR ALL EQUIPMENT AND MATERIALS USED ON THE PROJECT. SUBMITTALS SHALL BE APPROVED BY THE ENGINEER BEFORE PURCHASE OF MATERIALS. ALL ELECTRICAL CURRENT CARRYING PARTS SHALL BE COPPER FOR ALL EQUIPMENT. PERMANENTLY LABEL ALL NEW ELECTRICAL EQUIPMENT, INCLUDING BUT NOT LIMITED TO, DEVICE DESIGNATION AND SUPPLY CIRCUIT DESIGNATION. UPDATE PANEL DIRECTORIES TO INCLUDE NEW CIRCUIT INFORMATION RESULTING FROM THIS PROJECT. PROVIDE TEMPORARY POWER AND LIGHTING FOR ALL TRADES AS REQUIRED TO COMPLETE THE PROJECT. ALL TEMPORARY AND INTERIM EQUIPMENT SHALL BE INSTALLED IN ACCORDANCE WITH ALL APPLICABLE CODES AND STANDARDS INCLUDING, BUT NOT LIMITED TO, NFPA 110 AND NFPA 70. THE CONTRACTOR IS RESPONSIBLE FOR COORDINATING THIS REQUIREMENT WITH ALL OTHER TRADES AND INCLUDING ALL ASSOCIATED COST IN BID PRICE. REFER TO SPECIFICATIONS FOR ADDITIONAL INFORMATION THAT IS NOT SHOWN ON THE DRAWINGS. ENGAGE A QUALIFIED ELECTRICAL TESTING COMPANY TO LOCATE ALL UNDERGROUND UTILITIES IN PROPOSED CONSTRUCTION AREAS FOR ALL TRADES BEFORE DIGGING. THE CONTRACTOR IS RESPONSIBLE FOR CONTACTING THIS ORGANIZATION AND INCLUDING ALL ASSOCIATED COSTS IN THE BID PRICE. PROVIDE CONCRETE HOUSEKEEPING PADS FOR ALL FLOOR MOUNTED EQUIPMENT. ALL ELECTRICAL EQUIPMENT INSTALLED OUTDOOR AND/OR IN WET LOCATIONS SHALL BE IN NEMA 4X ENCLOSURE TYPE 316 STAINLESS STEEL. ALL ELECTRICAL EQUIPMENT INCLUDING, BUT NOT LIMITED TO, SWITCHBOARDS, PANEL BOARDS, MOTOR STARTERS, ENCLOSED CIRCUIT BREAKERS, DISCONNECT SWITCHES, TRANSFORMERS, ENCLOSURES, AND WIRING DEVICES SHALL BE UL LISTED FOR ITS INTENDED USE. ALL RECEPTACLE OUTLETS INSTALLED OUTDOORS AND/OR IN WET LOCATIONS SHALL BE LISTED WEATHER-RESISTANT TYPE WITH A WEATHERPROOF WHILE-IN-USE COVER THAT IS LISTED AND IDENTIFIED AS "EXTRA-DUTY". 	
	CONTROL PANEL/CABINET, SURFACE MOUNTED	78" TO TOP		PUBLIC INFORMATION DISPLAY (PID) MONITOR	= =	ADA	AMERICANS WITH DISABILITIES ACT	KW	KILOWATTS		
	POWER TRANSFORMER, WITH GROUND	= =		SPEAKER	= =	AFF	ABOVE FINISH FLOOR	LED	LIGHT EMITTING DIODE		
	SYSTEM GROUND OR EQUIPMENT GROUND	= =		PHOTOCELL	= =	AFG	ABOVE FINISH GRADE	LE	LEVEL ELEMENT		
	CIRCUIT BREAKER ATTRIBUTES: AF = FRAME SIZE AT = TRIP SIZE 3P = QTY. OF POLES L2 = MISC. INFO. LSGI = LONG, SHORT TIME, INSTANTANEOUS, GROUND FAULT TRIP FUNCTIONS	= =	ELECTRICAL CONVENTIONS			AHJ	AUTHORITY HAVING JURISDICTION	LIT	LEVEL INDICATOR TRANSMITTER		
	NON-FUSED DISCONNECT SWITCH, SIZE AS INDICATED WHERE: "AF" - INDICATES AMPERE SWITCH SIZE "NF" - DENOTES NON-FUSED "P" - DENOTES POLE "3R" - DENOTES NEMA TYPE ENCLOSURE	60" TO TOP	LIGHTING			AHU	AIR HANDLING UNIT	LTG	LIGHTING		
	FUSED DISCONNECT SWITCH, SIZE AS INDICATED WHERE: "AF" - INDICATES AMPERE SWITCH SIZE "AT" - INDICATES AMPERE FUSE SIZE "P" - DENOTES POLE "3R" - DENOTES NEMA TYPE ENCLOSURE	60" TO TOP	LUMINAIRE TYPE - SEE LUMINAIRE SCHEDULE			AIC	AMPERE INTERRUPTING CAPACITY	LFMC	LIQUID TIGHT FLEXIBLE METAL CONDUIT		
	COMBINATION MOTOR STARTER AND DISCONNECT SWITCH	60" TO TOP	CIRCUIT NUMBER			AL	ALUMINUM	MC	METAL CLAD CABLE		
	MOTOR STARTER	60" TO TOP	CONTROL POINT DESIGNATION			ANSI	AMERICAN NATIONAL STANDARDS INSTITUTE	MCC	MOTOR CONTROL CENTER		
	MANUAL MOTOR STARTER WITH MOTOR OVERLOAD PROTECTION.	48" AFF	SYMBOL			ARCH	ARCHITECT	MCP	MOTOR CIRCUIT PROTECTOR		
	MOTOR TERMINATION	= =	DESCRIPTION			ATS	AUTOMATIC TRANSFER SWITCH	MISC	MISCELLANEOUS		
	SURGE PROTECTION DEVICE	= =	LP2A-1			ATC	AUTOMATIC TEMPERATURE CONTROL	MLO	MAIN LUGS ONLY		
	SWITCH, TOGGLE "b" DENOTES SWITCH CONTROL "x=2" DENOTES TWO POLE SWITCH "x=3" DENOTES THREE POLE SWITCH "x=4" DENOTES FOUR POLE SWITCH "WP" DENOTES WEATHER PROOF	48" AFF	HOMERUN TO PANEL "LP2A". CIRCUIT #1 (VIA 20A-1P CIRCUIT BREAKER). PROVIDE INSULATED GROUND CONDUCTOR IN ACCORDANCE WITH SPECIFICATIONS. THE USE OF DASHED LINE IN THIS SYMBOL INDICATES A BELOW GRADE HOMERUN.			AWG	AMERICAN WIRE GAUGE	MMS	MANUAL MOTOR STARTER SWITCH		
	125 VOLT, 2 POLE, 3 WIRE, 20 AMP RECEPTACLE. "2" DENOTES CIRCUIT NUMBER.	18" AFF	EXPOSED OR CONCEALED CONDUIT AND/OR WIRING.			BFG	BELOW FINISH GRADE	MS	MOTOR STARTER		
	125 VOLT, 2 POLE, 3 WIRE, 20 AMP DUPLEX RECEPTACLE GFI DENOTES EQUIPPED WITH INTEGRAL GROUND FAULT INTERRUPTER WP DENOTES WEATHER PROOF RECEPTACLE WITH WEATHER PROOF WHILE-IN-USE COVER	18" AFF	BELOW GRADE CONDUIT AND/OR WIRING.			BLDG	BUILDING	NC	NORMALLY CLOSED		
	WALL MOUNTED LIGHT FIXTURE	AS INDICATED				C	CONDUIT	NEC	NATIONAL ELECTRIC CODE		
	1' X 4' LIGHT FIXTURE	= =									
	JUNCTION BOX	AS INDICATED				CAT	CATALOG	NEMA	NATIONAL ELECTRICAL MANUFACTURES ASSOCIATION		
	SMOKE DETECTOR - ELEVATOR	= =									
	HEAT DETECTOR	= =									



NOTE: SOME SYMBOLS MAY NOT BE USED ON THIS PROJECT.

60% SUBMITTAL

CONTRACT NO:		REVISIONS				VIRGINIA RAILWAY EXPRESS	DISCIPLINE:	DRAWING NO:
PROJECT NO:		BY	NO					
DESIGNED:	JER 05/06/16						SCALE:	DATE ISSUED:
DRAFTED:	JLH 05/06/16						NONE	5/25/16
CHECKED:	QAM 05/06/16							
APPROVED:								

NOTES:



1. INFORMATION SHOWN ON THIS DRAWING PERTAINING TO EXISTING CONDITIONS HAS BEEN OBTAINED FROM AVAILABLE BUILDING DRAWINGS OR GENERAL FIELD OBSERVATIONS AND MAY NOT INDICATE ACTUAL EXISTING CONDITIONS. PRIOR TO FABRICATION OR PERFORMANCE OF ANY WORK, SHOULD CONDITIONS BE DISCOVERED THAT PREVENT EXECUTION OF THE WORK AS INDICATED, THE CONTRACTOR SHALL IMMEDIATELY NOTIFY THE ENGINEER IN WRITING AND AWAIT DIRECTION BEFORE PROCEEDING.
2. REFER TO DRAWING E-001 FOR ELECTRICAL LEGEND, ABBREVIATIONS, AND GENERAL NOTES.
3. REFER TO DRAWING E-601 FOR ONE-LINE DIAGRAM.
4. REFER TO DRAWING E-101 FOR TUNNEL DEMOLITION PLAN.
5. ALL WORK SHALL BE PERFORMED IN ACCORDANCE WITH THE PHASING PLAN. REFER TO PHASING DRAWINGS FOR ADDITIONAL INFORMATION.
6. DURING ALL PHASES OF CONSTRUCTION, CONTRACTOR SHALL PROVIDE TEMPORARY POWER AND LIGHTING TO ALL AREAS THAT ARE TO REMAIN OPERATIONAL.

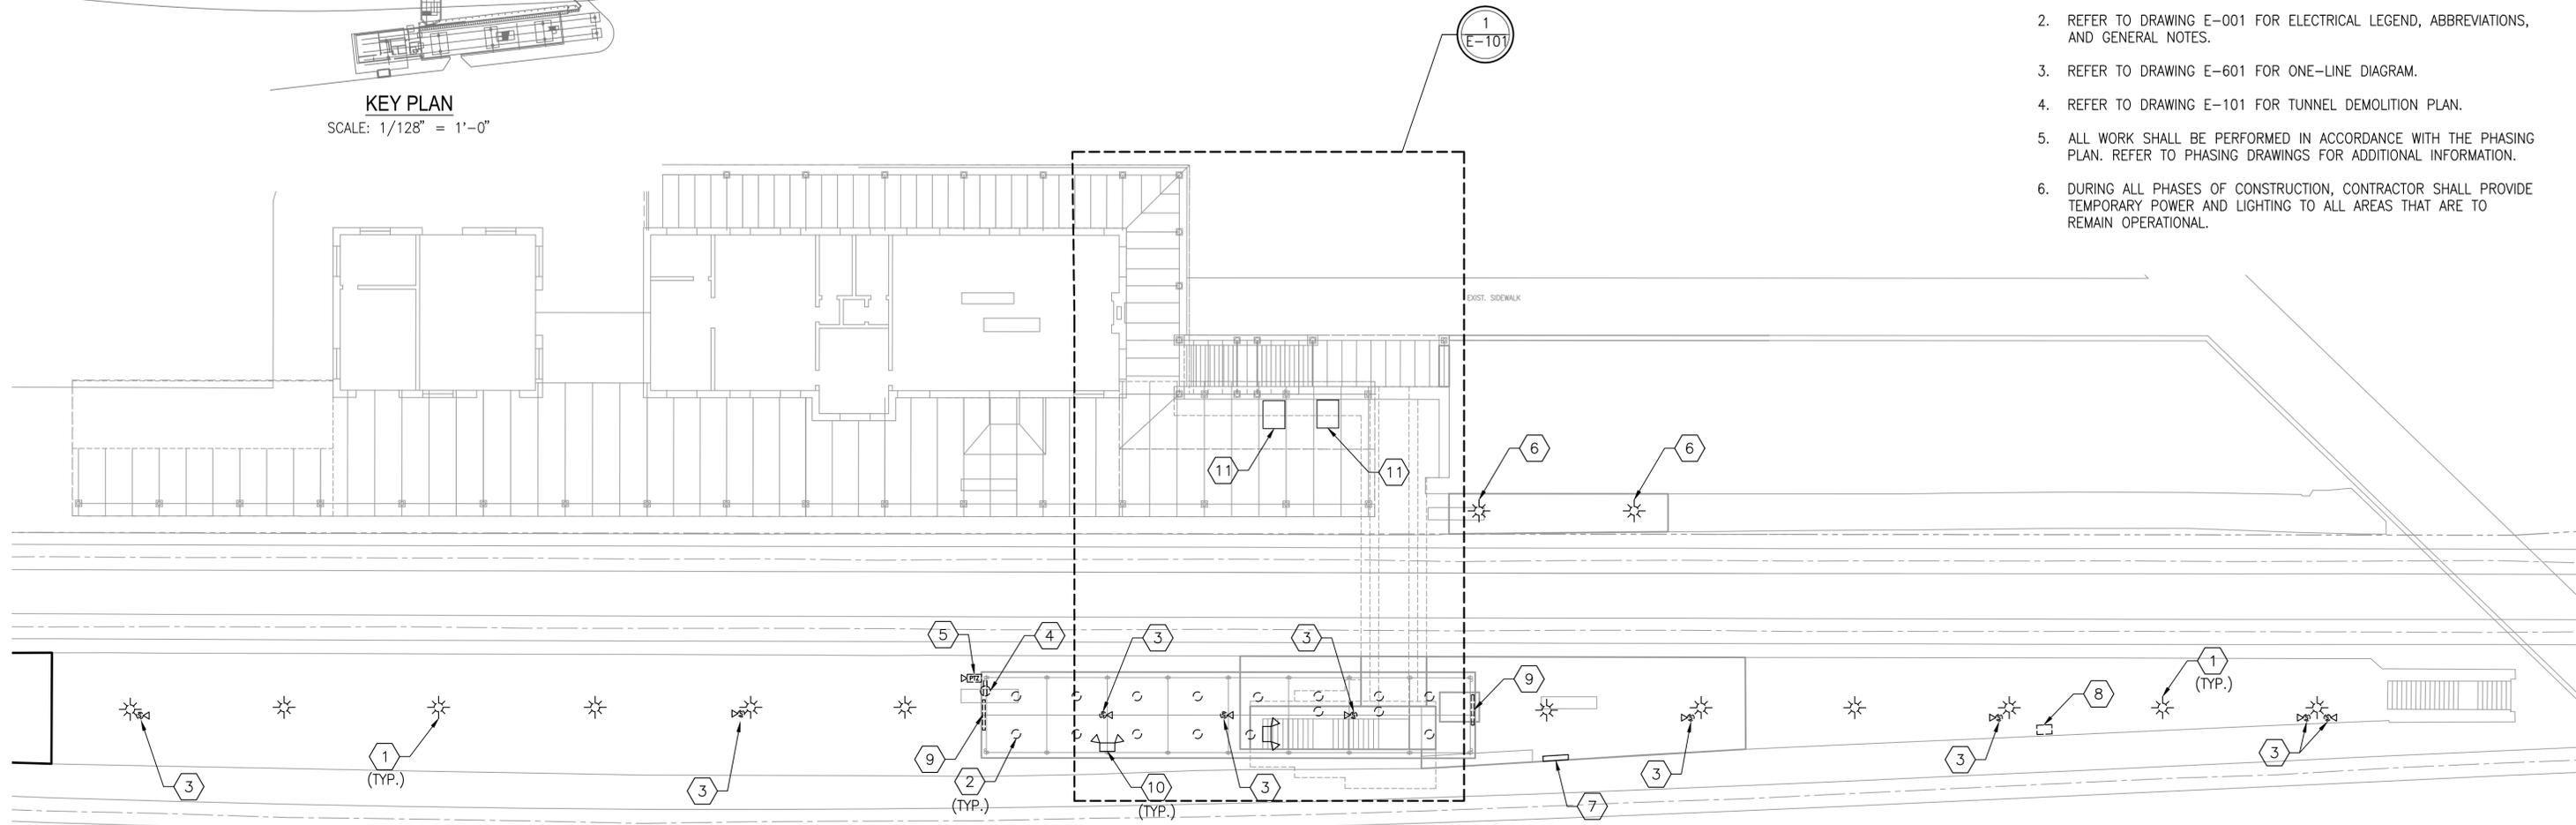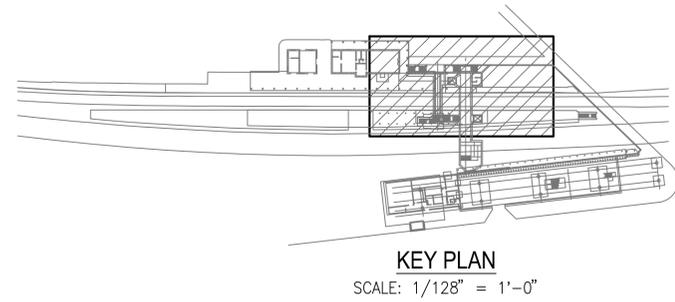

1
E-100
ELECTRICAL SITE PLAN - DEMOLITION
SCALE: 1/16" = 1'-0"

DEMOLITION NOTES:

- | | | |
|---|--|---|
| <p>1 REMOVE EXISTING POLE, LIGHT FIXTURE, ASSOCIATED WIRING AND CONDUITS BACK TO SOURCE.</p> <p>2 REMOVE EXISTING CANOPY LIGHT FIXTURE, ASSOCIATED WIRING AND CONDUITS BACK TO SOURCE.</p> <p>3 REMOVE EXISTING SPEAKER, ASSOCIATED WIRING AND CONDUITS BACK TO SOURCE.</p> <p>4 REMOVE EXISTING RECEPTACLE, ASSOCIATED WIRING AND CONDUITS BACK TO SOURCE.</p> | <p>5 REMOVE EXISTING CAMERA, ASSOCIATED WIRING AND CONDUITS BACK TO SOURCE.</p> <p>6 REMOVE EXISTING LIGHT POLE AND FIXTURE. EXTEND EXISTING WIRING AND CONDUIT TO MAINTAIN CONTINUITY OF EXISTING CIRCUITS.</p> <p>7 REMOVE EXISTING ELECTRICAL CABINET WITH PANELBOARD, TIME CLOCK, AND LIGHTING CONTACTOR. REMOVE ASSOCIATED CONDUIT AND WIRING BACK TO SOURCE.</p> <p>8 EXISTING ELECTRICAL CABINET TO REMAIN.</p> | <p>9 REMOVE EXISTING ELECTRONIC INFORMATION DISPLAY, ASSOCIATED WIRING AND CONDUIT BACK TO SOURCE.</p> <p>10 REMOVE EXISTING EMERGENCY LIGHT FIXTURE, ASSOCIATED WIRING AND CONDUITS BACK TO SOURCE.</p> <p>11 EXISTING TICKET BOOTH TO BE RELOCATED. PROTECT AND RETAIN EXISTING WIRING AND CONDUITS FOR RECONNECTION.</p> |
|---|--|---|

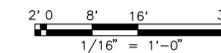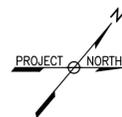

60% SUBMITTAL

CONTRACT NO:		REVISIONS	
PROJECT NO:	DATE:	BY	NO DATE DESCRIPTION
DESIGNED: JER	05/06/16		
DRAFTED: JLH	05/06/16		
CHECKED: QAM	05/06/16		
APPROVED:			



VIRGINIA RAILWAY EXPRESS
**ALEXANDRIA
PEDESTRIAN TUNNEL**


DISCIPLINE:		DRAWING NO:
ELECTRICAL SITE PLAN - DEMOLITION		E-100
SCALE:	DATE ISSUED:	LIST NO:
1/16" = 1'-0"	5/25/16	

NOTES:



1. INFORMATION SHOWN ON THIS DRAWING PERTAINING TO EXISTING CONDITIONS HAS BEEN OBTAINED FROM AVAILABLE BUILDING DRAWINGS OR GENERAL FIELD OBSERVATIONS AND MAY NOT INDICATE ACTUAL EXISTING CONDITIONS. PRIOR TO FABRICATION OR PERFORMANCE OF ANY WORK, SHOULD CONDITIONS BE DISCOVERED THAT PREVENT EXECUTION OF THE WORK AS INDICATED, THE CONTRACTOR SHALL IMMEDIATELY NOTIFY THE ENGINEER IN WRITING AND AWAIT DIRECTION BEFORE PROCEEDING.
2. REFER TO DRAWING E-001 FOR ELECTRICAL LEGEND, ABBREVIATIONS, AND GENERAL NOTES.
3. ALL WORK SHALL BE PERFORMED IN ACCORDANCE WITH THE PHASING PLAN. REFER TO PHASING DRAWINGS FOR ADDITIONAL INFORMATION.
4. DURING ALL PHASES OF CONSTRUCTION, CONTRACTOR SHALL PROVIDE TEMPORARY POWER AND LIGHTING TO ALL AREAS THAT ARE TO REMAIN OPERATIONAL.

DEMOLITION NOTES:

- ① REMOVE EXISTING LIGHT FIXTURE, ASSOCIATED WIRING AND CONDUIT BACK TO SOURCE.
- ② REMOVE EXISTING CAMERA, ASSOCIATED WIRING AND CONDUIT BACK TO SOURCE.

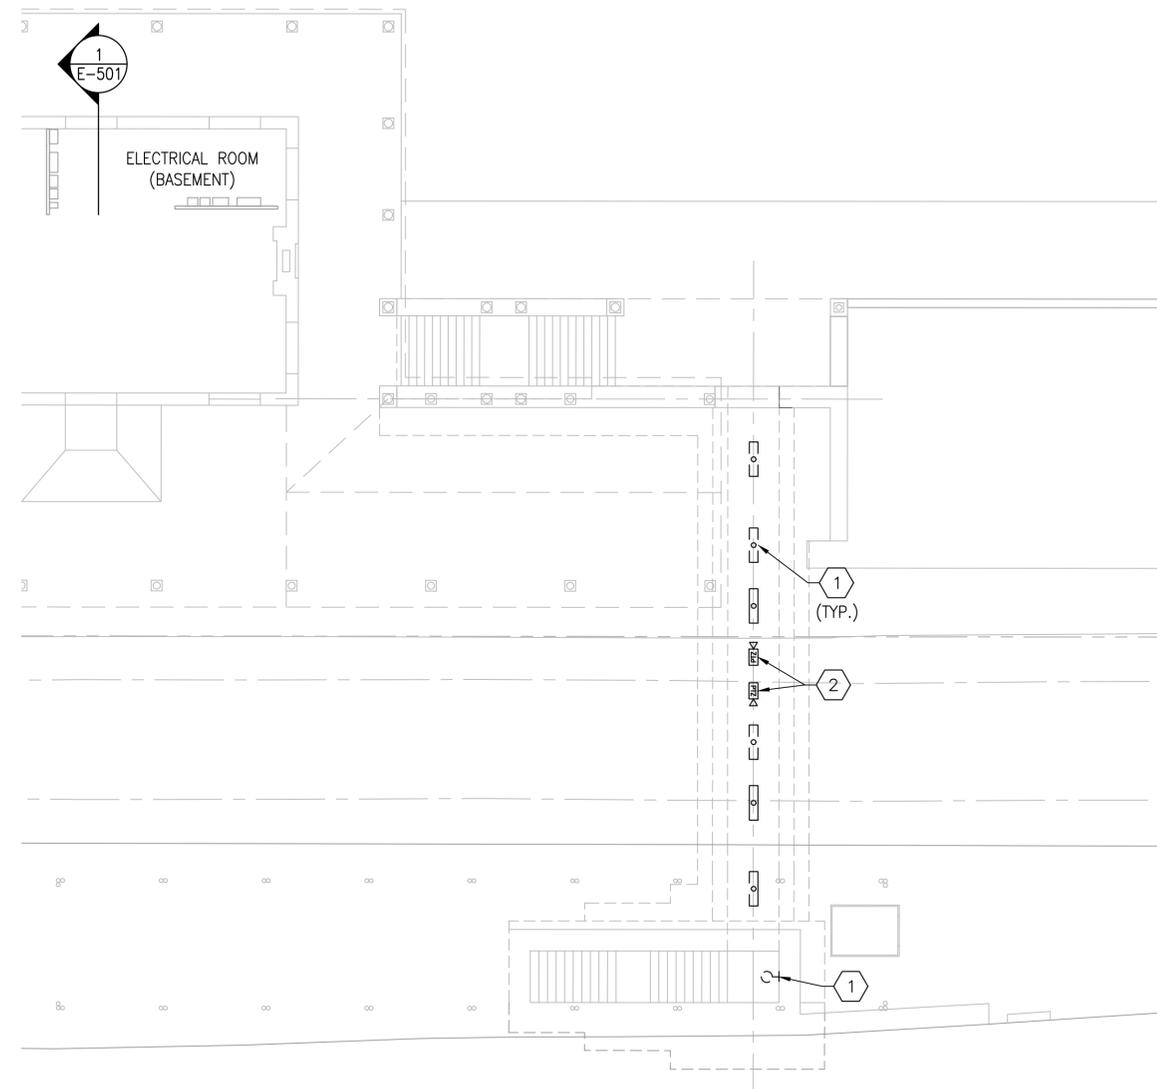

①
E-101
ELECTRICAL DEMOLITION PLAN - TUNNEL
SCALE: 3/32" = 1'-0"

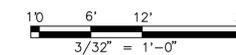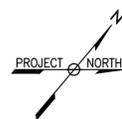

60% SUBMITTAL

CONTRACT NO:		REVISIONS			
PROJECT NO:		BY	NO	DATE	DESCRIPTION
DESIGNED:	JER 05/06/16				
DRAFTED:	JLH 05/06/16				
CHECKED:	QAM 05/06/16				
APPROVED:					





VIRGINIA RAILWAY EXPRESS
ALEXANDRIA
PEDESTRIAN TUNNEL


DISCIPLINE:		DRAWING NO:
ELECTRICAL DEMOLITION PLAN - TUNNEL		E-101
SCALE:	DATE ISSUED:	LIST NO:
3/32" = 1'-0"	5/25/16	

NOTES:

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2. REFER TO DRAWING E-001 FOR ELECTRICAL LEGEND, ABBREVIATIONS, AND GENERAL NOTES.
3. REFER TO DRAWING E-601 FOR ONE-LINE DIAGRAM.

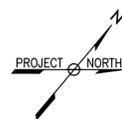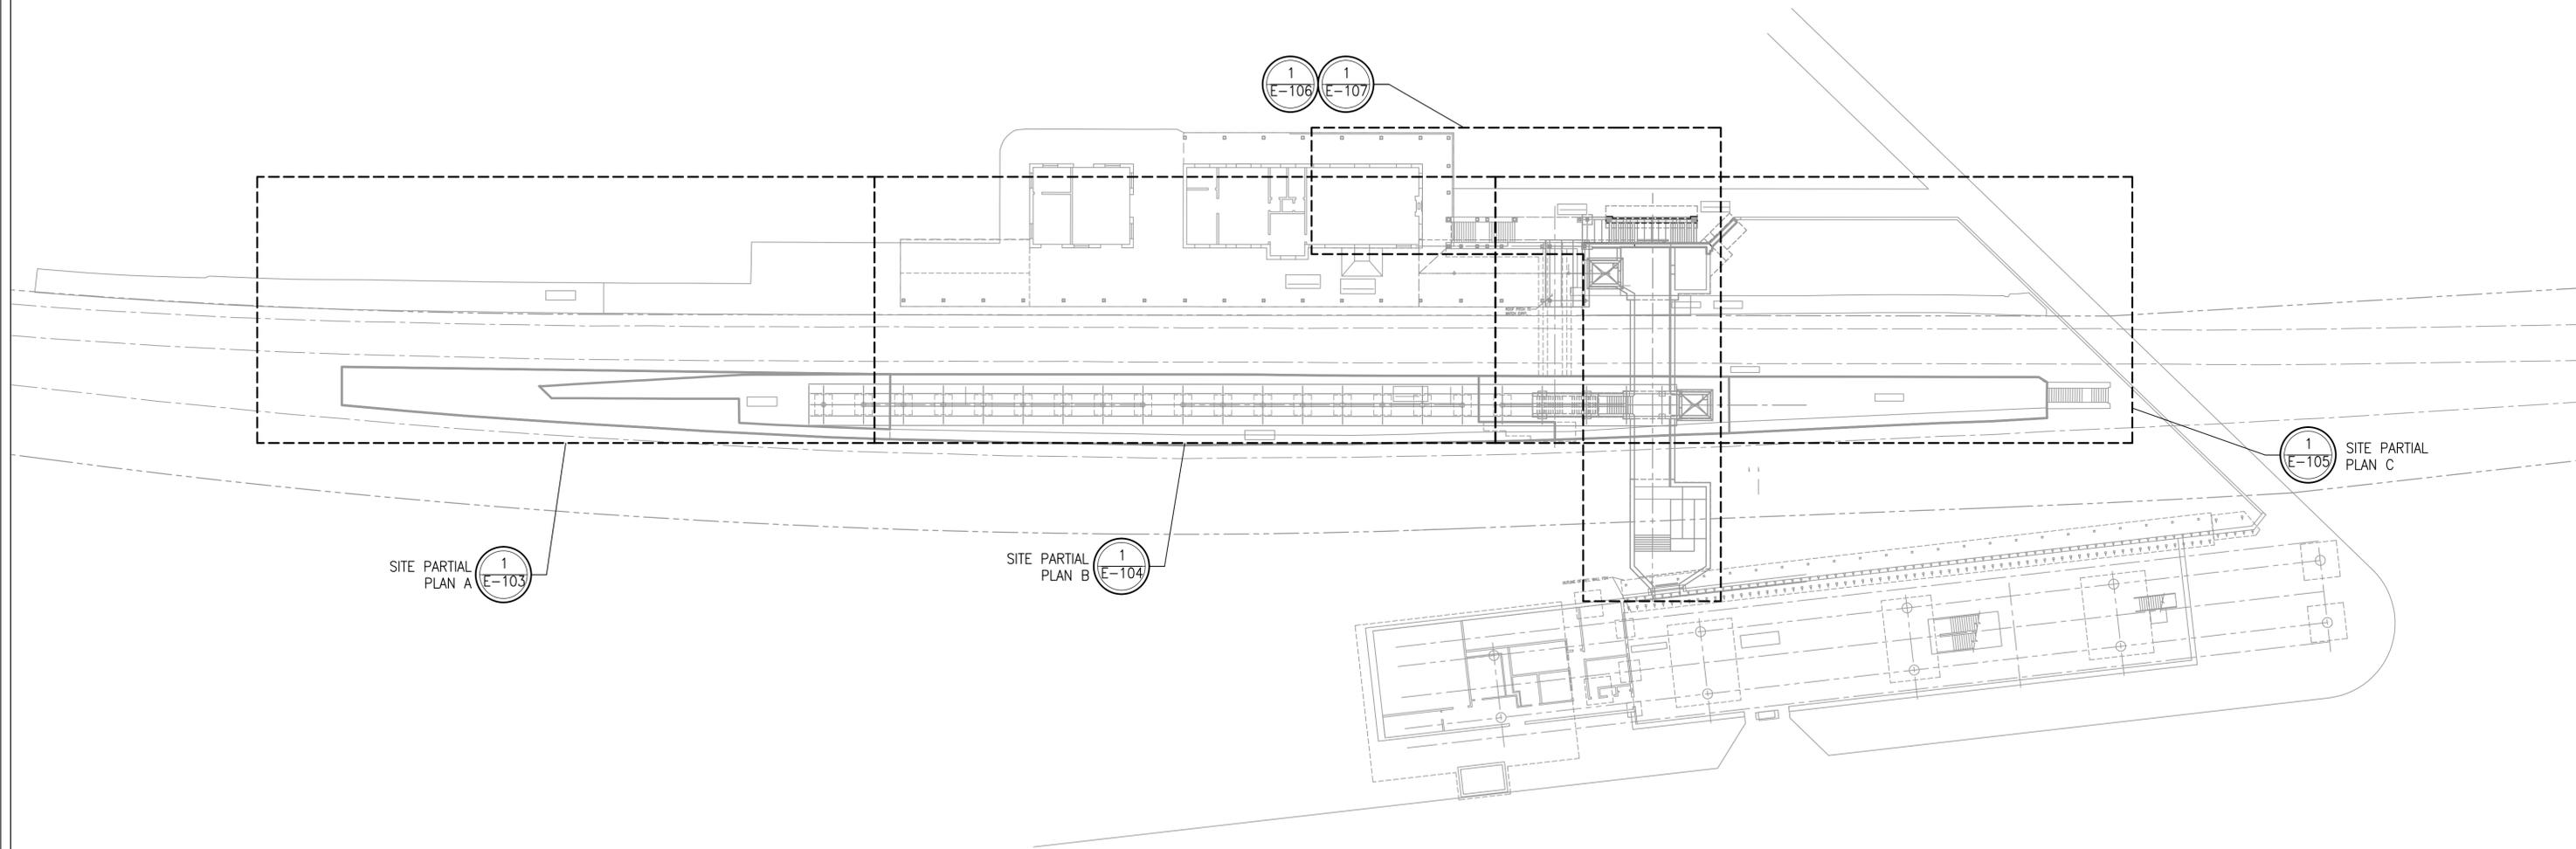

ELECTRICAL OVERALL SITE PLAN
SCALE: 1/32" = 1'-0"

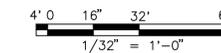

60% SUBMITTAL

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DESIGNED:	JER 05/06/16				
DRAFTED:	JLH 05/06/16				
CHECKED:	QAM 05/06/16				
APPROVED:					




VIRGINIA RAILWAY EXPRESS
ALEXANDRIA
PEDESTRIAN TUNNEL

DISCIPLINE:		DRAWING NO:
ELECTRICAL OVERALL SITE PLAN		E-102
SCALE:	DATE ISSUED:	LIST NO:
1/32" = 1'-0"	5/25/16	


NOTES:

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2. REFER TO DRAWING E-001 FOR ELECTRICAL LEGEND, ABBREVIATIONS, AND GENERAL NOTES.
3. REFER TO DRAWING E-602 FOR LIGHTING FIXTURE AND PANEL SCHEDULES.
4. REFER TO DRAWING E-601 FOR ONE-LINE DIAGRAM.
5. ALL WORK SHALL BE PERFORMED IN ACCORDANCE WITH THE PHASING PLAN. REFER TO PHASING DRAWINGS FOR ADDITIONAL INFORMATION.
6. DURING ALL PHASES OF CONSTRUCTION, CONTRACTOR SHALL PROVIDE TEMPORARY POWER AND LIGHTING TO ALL AREAS THAT ARE TO REMAIN OPERATIONAL.

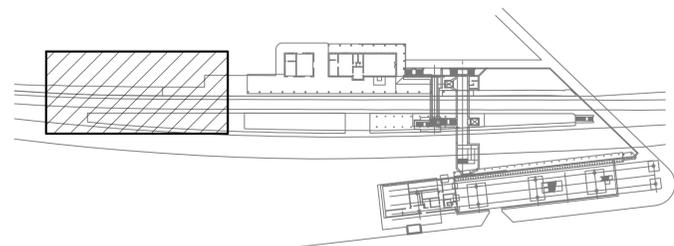


KEY PLAN

SCALE: 1/128" = 1'-0"

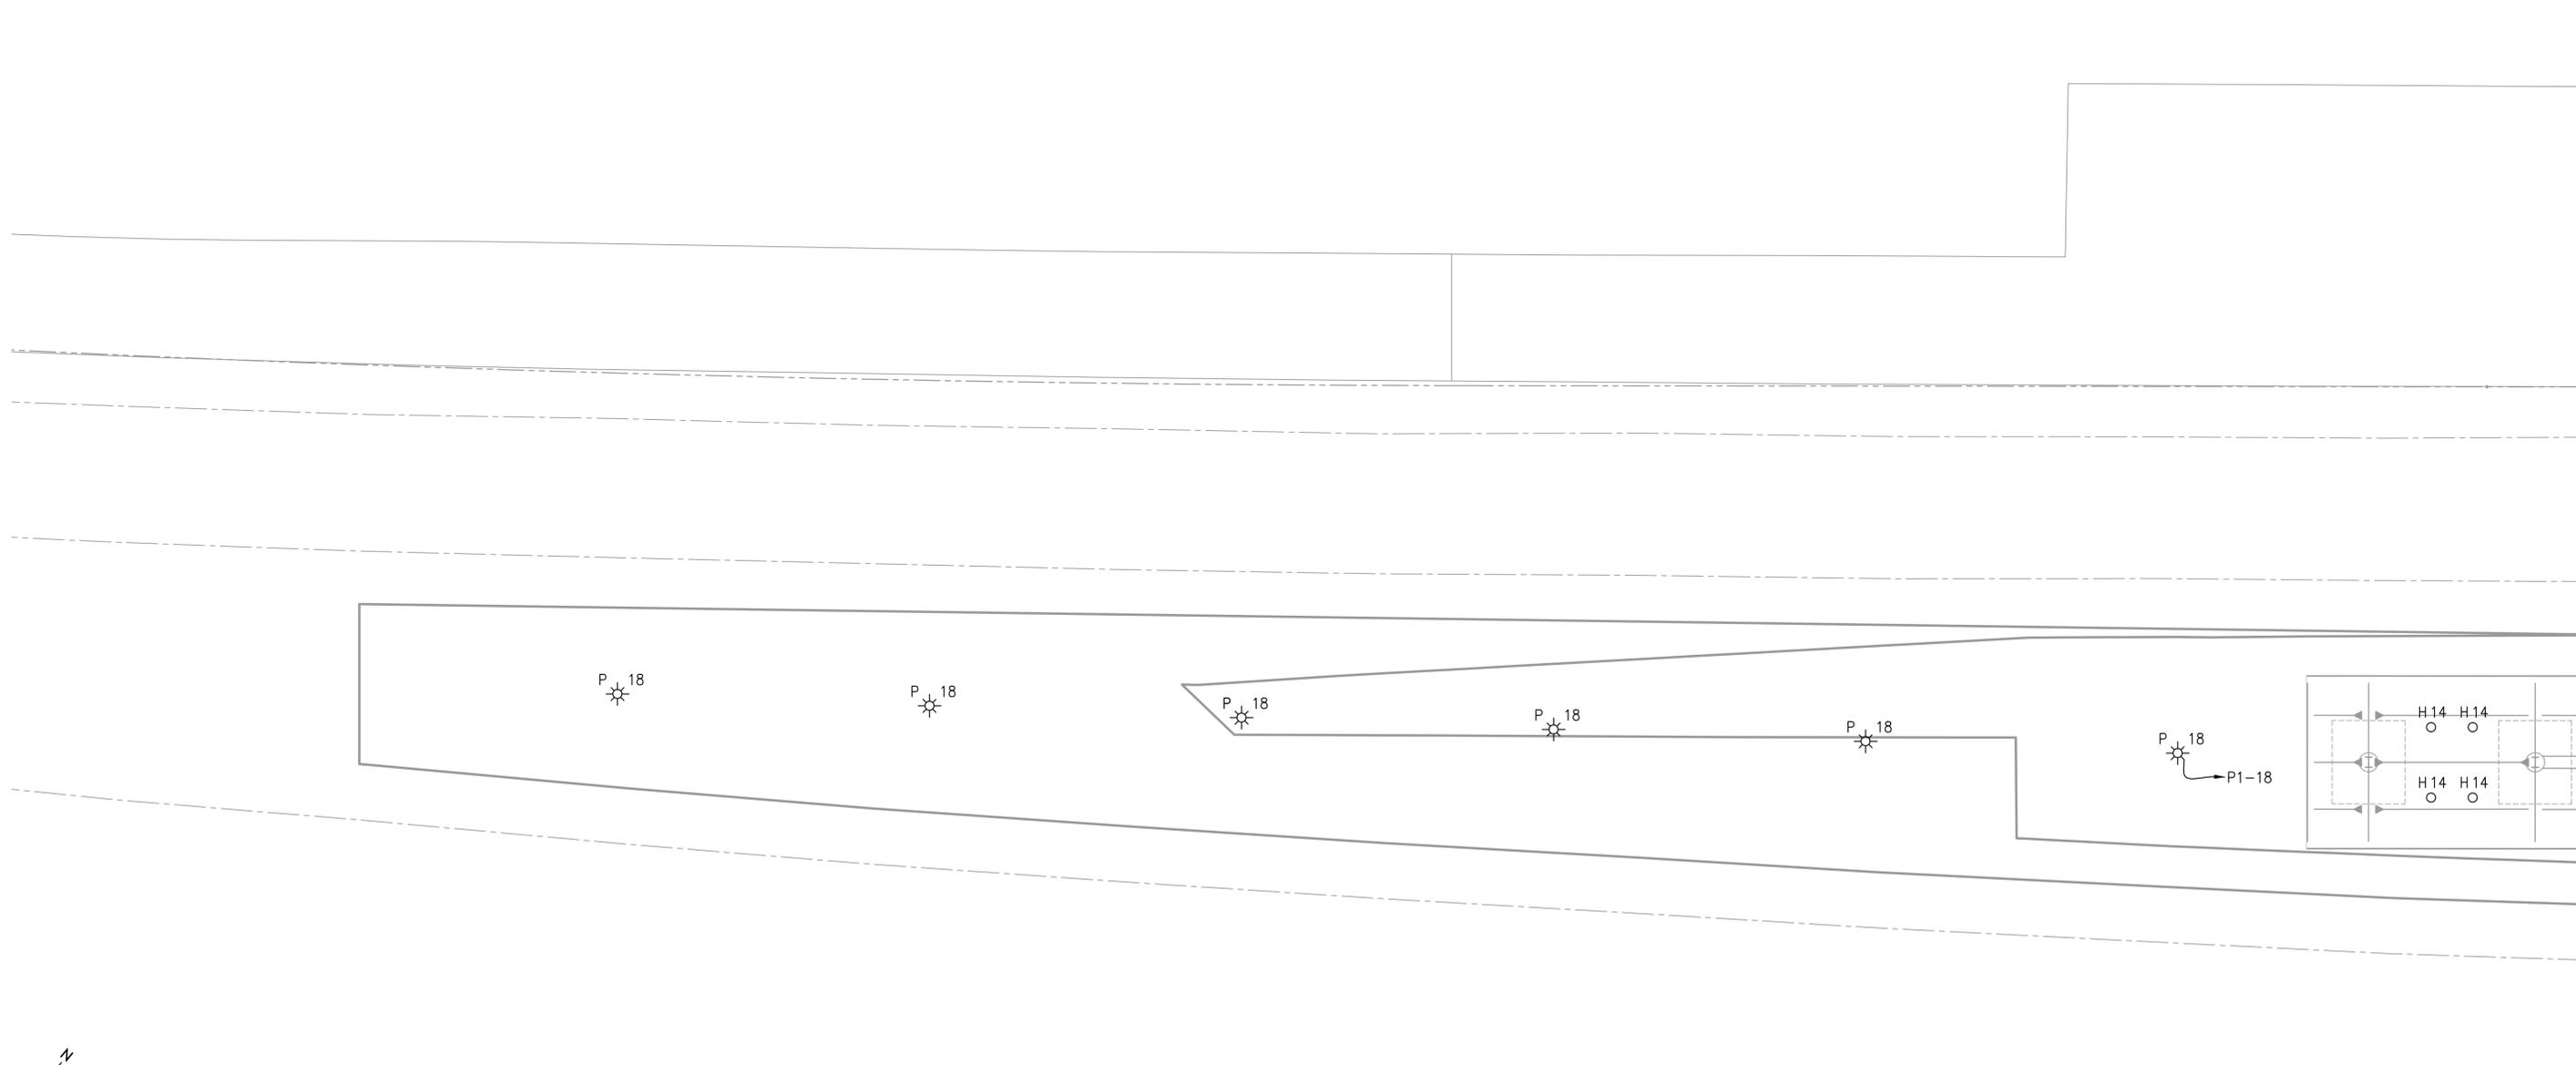


MATCH LINE - REFER TO PLAN B ON E-104

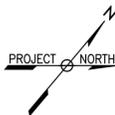

1
E-103

ELECTRICAL SITE PARTIAL PLAN A

SCALE: 1/8" = 1'-0"

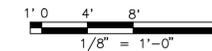


60% SUBMITTAL

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PROJECT NO:		BY	NO	DATE	DESCRIPTION
DESIGNED:	JER 05/06/16				
DRAFTED:	JLH 05/06/16				
CHECKED:	QAM 05/06/16				
APPROVED:					



VIRGINIA RAILWAY EXPRESS
ALEXANDRIA
PEDESTRIAN TUNNEL


DISCIPLINE:		DRAWING NO:
ELECTRICAL SITE PARTIAL PLAN A		E-103
SCALE:	DATE ISSUED:	LIST NO:
1/8" = 1'-0"	5/25/16	

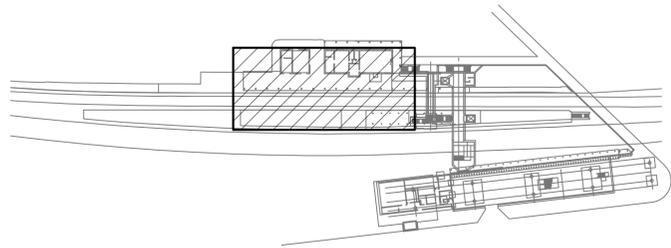

KEY PLAN
SCALE: 1/128" = 1'-0"


NOTES:

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2. REFER TO DRAWING E-001 FOR ELECTRICAL LEGEND, ABBREVIATIONS, AND GENERAL NOTES.
3. REFER TO DRAWING E-602 FOR LIGHTING FIXTURE SCHEDULE AND PANEL SCHEDULES.
4. REFER TO DRAWING E-601 FOR ONE-LINE DIAGRAM.
5. ALL WORK SHALL BE PERFORMED IN ACCORDANCE WITH THE PHASING PLAN. REFER TO PHASING DRAWINGS FOR ADDITIONAL INFORMATION.
6. DURING ALL PHASES OF CONSTRUCTION, CONTRACTOR SHALL PROVIDE TEMPORARY POWER AND LIGHTING TO ALL AREAS THAT ARE TO REMAIN OPERATIONAL.

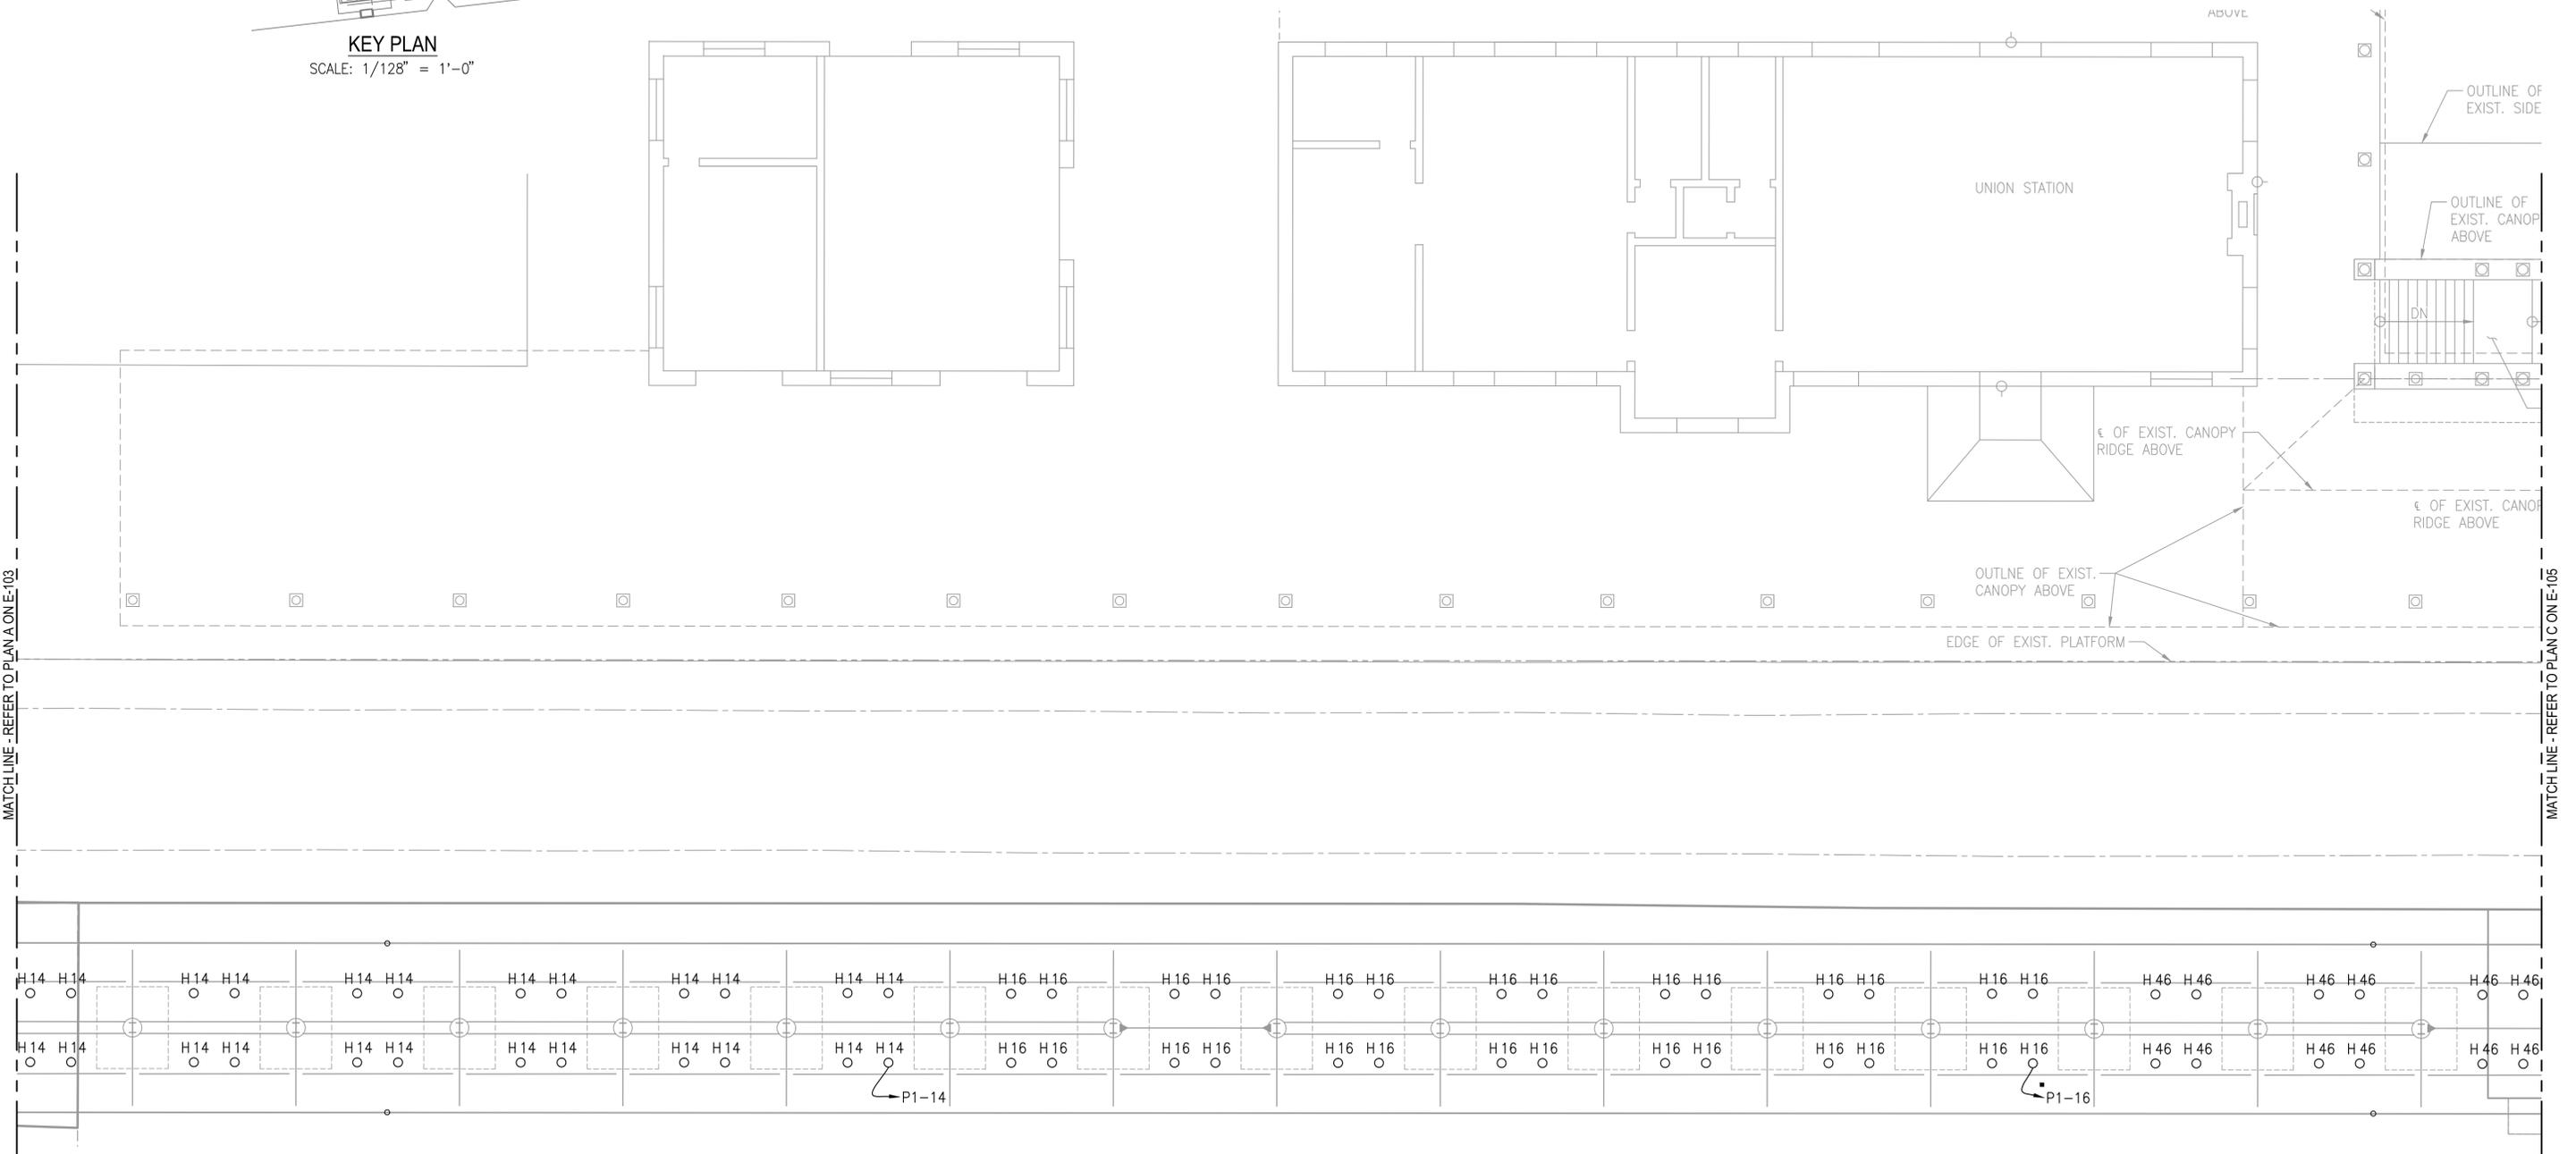

MATCHLINE - REFER TO PLAN A ON E-103


MATCHLINE - REFER TO PLAN C ON E-105

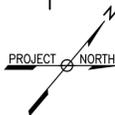

1
E-104

ELECTRICAL SITE PARTIAL PLAN B

SCALE: 1/8" = 1'-0"

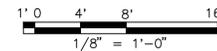


60% SUBMITTAL

CONTRACT NO:		REVISIONS	
PROJECT NO:	DATE:	BY	NO DATE DESCRIPTION
DESIGNED: JER	05/06/16		
DRAFTED: JLH	05/06/16		
CHECKED: QAM	05/06/16		
APPROVED:			



VIRGINIA RAILWAY EXPRESS
ALEXANDRIA
PEDESTRIAN TUNNEL

DISCIPLINE:		DRAWING NO:
ELECTRICAL SITE PARTIAL PLAN B		E-104
SCALE:	DATE ISSUED:	LIST NO:
1/8" = 1'-0"	5/25/16	

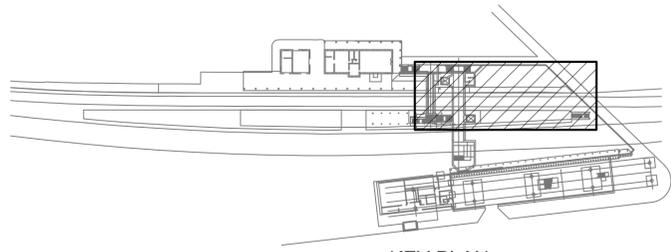


KEY PLAN
SCALE: 1/128" = 1'-0"

KEYED NOTES:


- ① INSTALL PHOTOCELL ON LIGHT POLE, FREE OF ANY OBSTRUCTION BY EQUIPMENT OR OTHER ELEMENTS, FOR ACCESS TO AMBIENT LIGHTING. COORDINATE EXACT LOCATION IN FIELD.
- ② CONNECT NEW LIGHT FIXTURES TO EXISTING LIGHTING CIRCUIT FOR EXISTING WEST PLATFORM CANOPY LIGHTING.
- ③ PROVIDE SMOKE DETECTOR FOR ELEVATOR RECALL FUNCTION. PROVIDE CONTROL CIRCUITS TO ELEVATOR CONTROLLER THROUGH RELAYS FOR ELEVATOR RECALL.
- ④ PROVIDE 208V, 2-POLE, 30A FUSED DISCONNECT SWITCH IN NEMA 4X SS ENCLOSURE WITH 20A FUSES.
- ⑤ PROVIDE UNISTRUT SUPPORT ON CONCRETE PAD.

NOTES:


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2. REFER TO DRAWING E-001 FOR ELECTRICAL LEGEND, ABBREVIATIONS, AND GENERAL NOTES.
3. REFER TO DRAWING E-602 FOR LIGHTING FIXTURE SCHEDULE AND PANEL SCHEDULES.
4. REFER TO DRAWING E-601 FOR ONE-LINE DIAGRAM.
5. REFER TO E-107 FOR TUNNEL LIGHTING PLAN.
6. ALL WORK SHALL BE PERFORMED IN ACCORDANCE WITH THE PHASING PLAN. REFER TO PHASING DRAWINGS FOR ADDITIONAL INFORMATION.
7. DURING ALL PHASES OF CONSTRUCTION, CONTRACTOR SHALL PROVIDE TEMPORARY POWER AND LIGHTING TO ALL AREAS THAT ARE TO REMAIN OPERATIONAL.

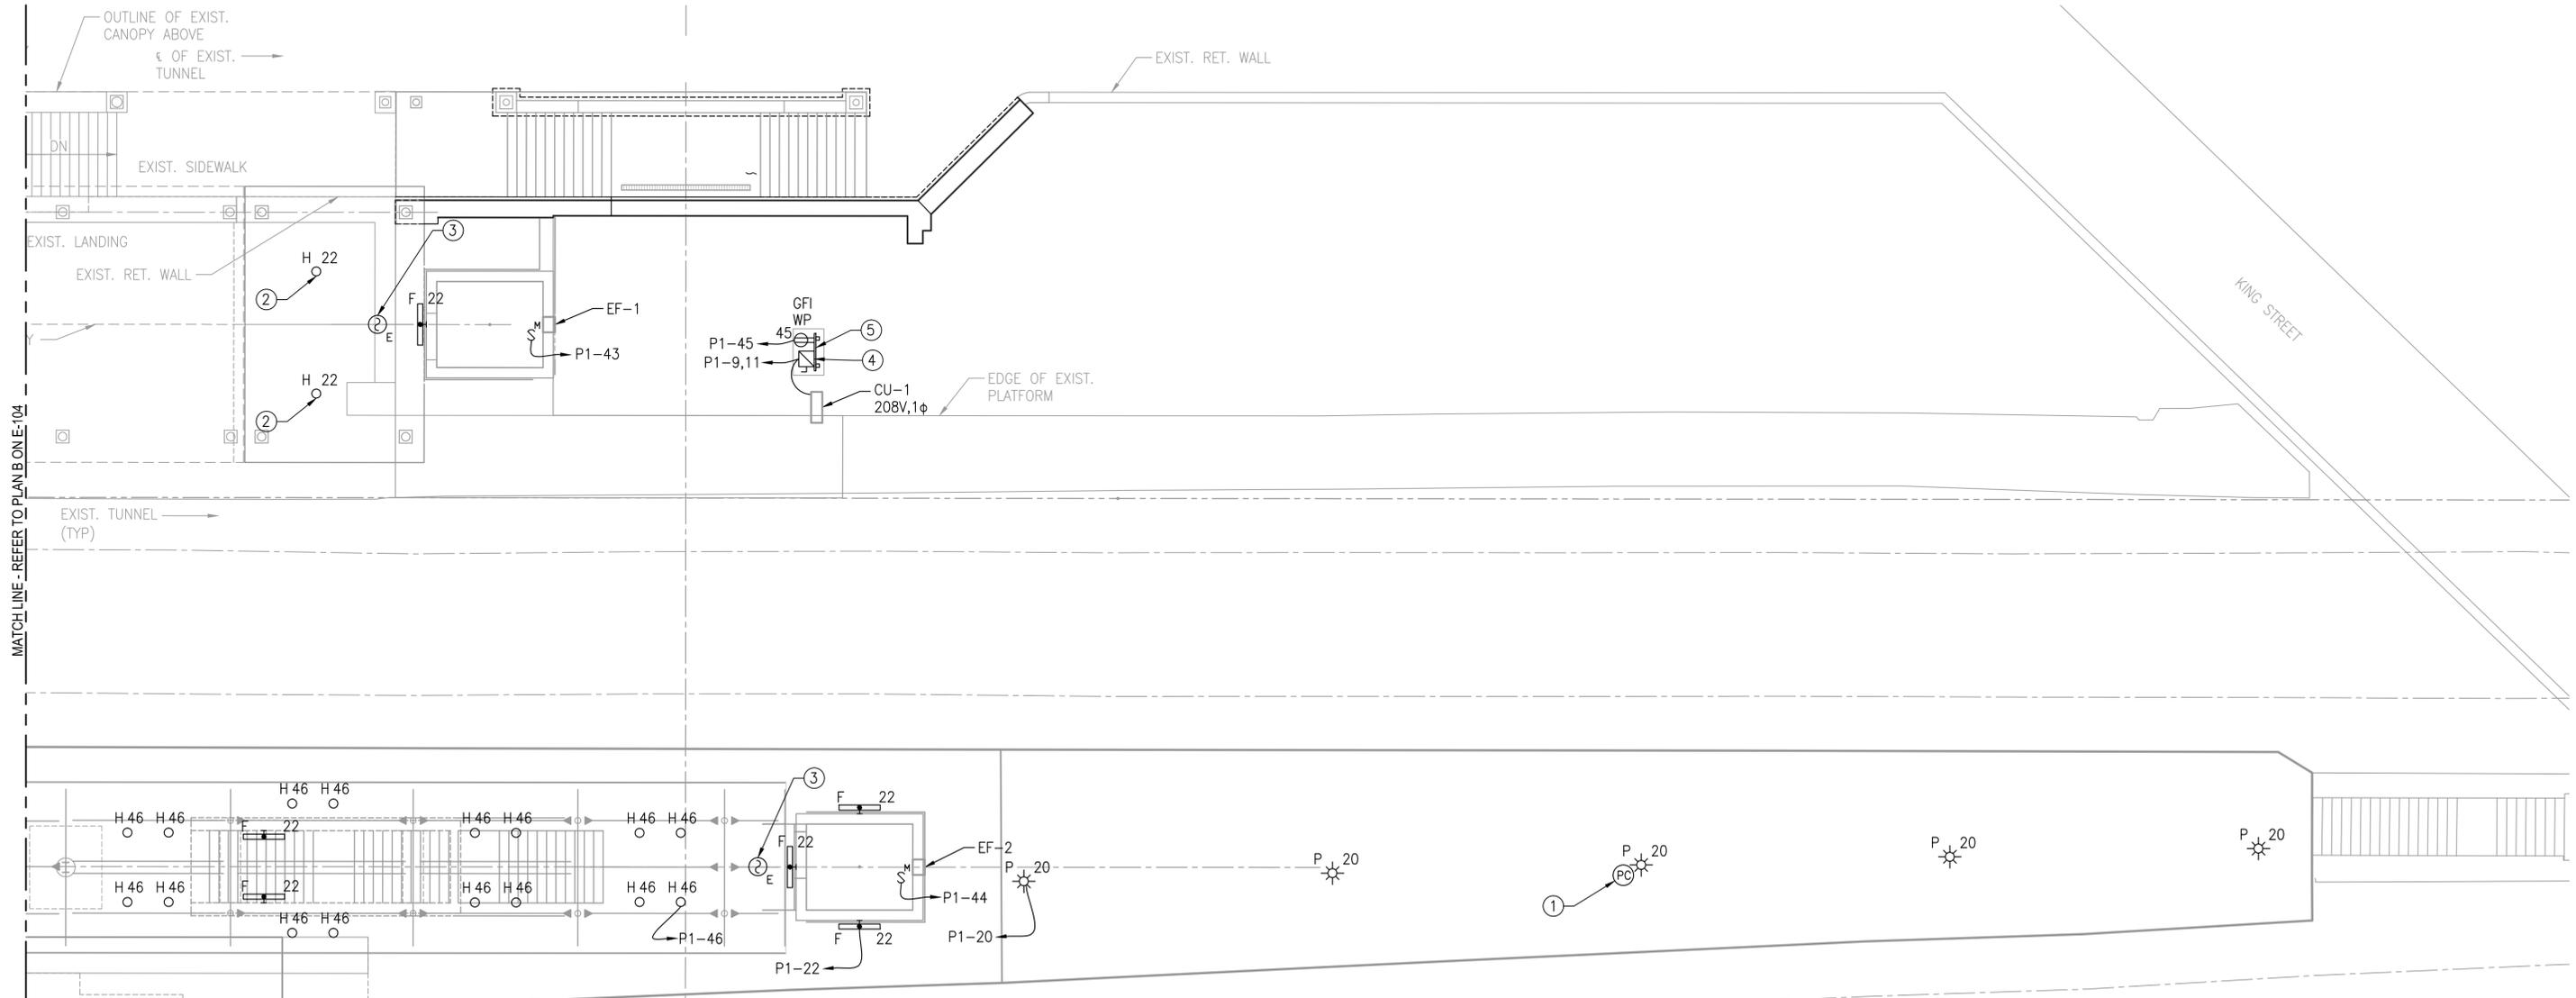

MATCH LINE - REFER TO PLAN B ON E-104

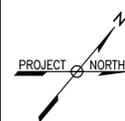

1
E-105 **ELECTRICAL SITE PARTIAL PLAN C**
SCALE: 1/8" = 1'-0"

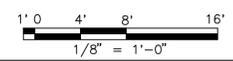


60% SUBMITTAL

CONTRACT NO:		REVISIONS	
PROJECT NO:	DATE:	BY	NO DATE DESCRIPTION
DESIGNED: JER	05/06/16		
DRAFTED: JLH	05/06/16		
CHECKED: QAM	05/06/16		
APPROVED:			



VIRGINIA RAILWAY EXPRESS
**ALEXANDRIA
PEDESTRIAN TUNNEL**


DISCIPLINE:		DRAWING NO:
ELECTRICAL SITE PARTIAL PLAN C		E-105
SCALE:	DATE ISSUED:	LIST NO:
1/8" = 1'-0"	5/25/16	

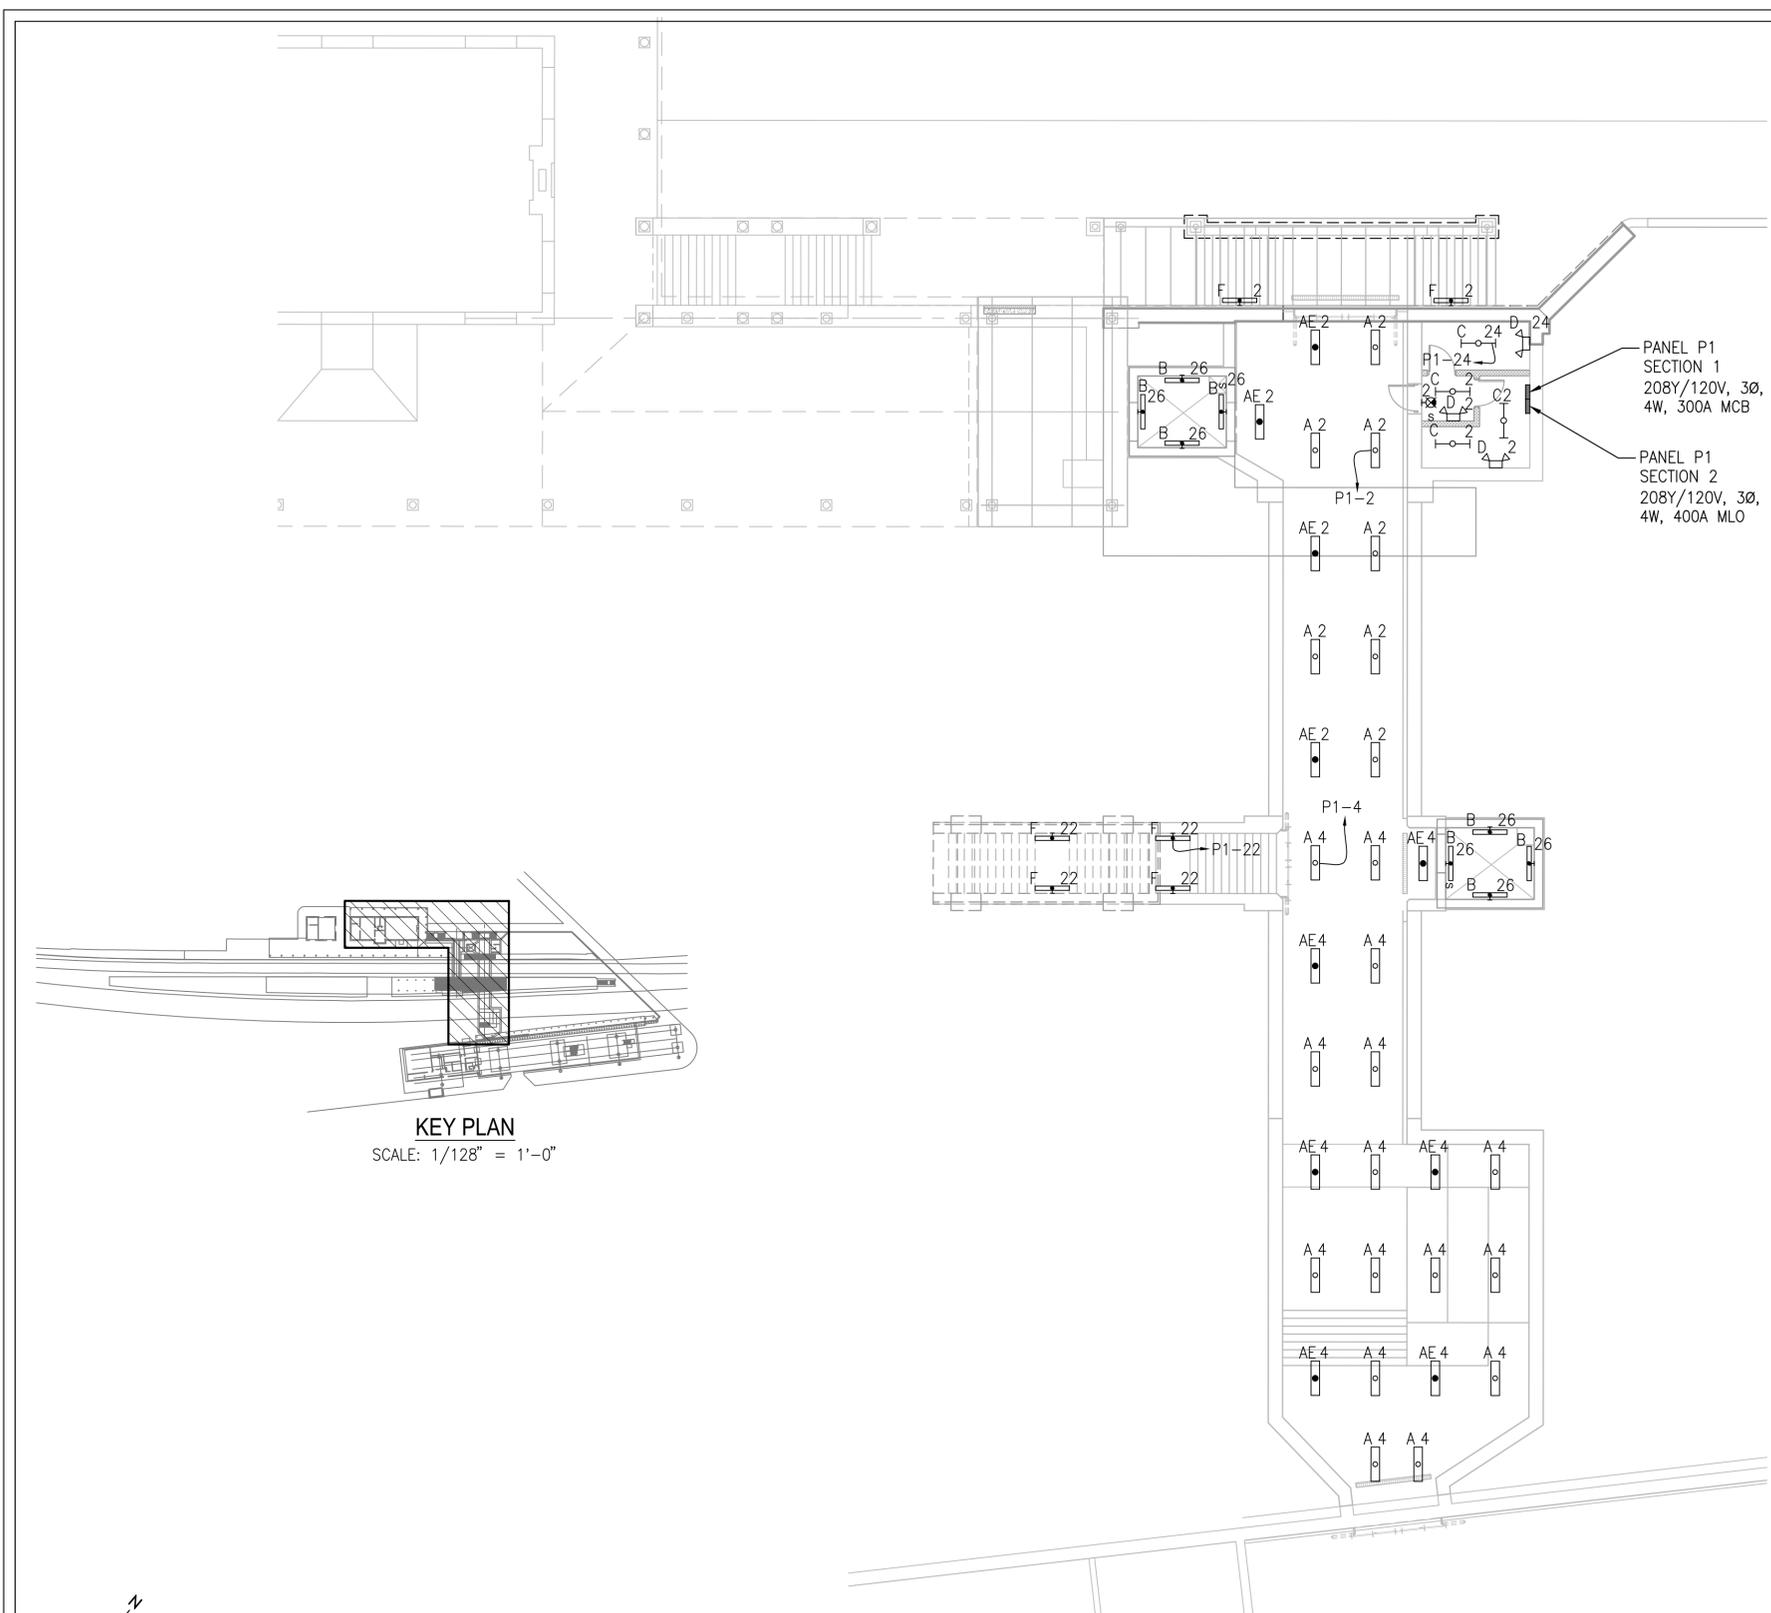

- NOTES:**
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 2. ALL EXIT AND EGRESS LIGHTING SHALL BE CONNECTED ON THE UN-SWITCHED PORTION OF THE CIRCUIT.
 3. REFER TO DRAWING E-001 FOR ELECTRICAL LEGEND, ABBREVIATIONS, GENERAL NOTES AND LIGHT FIXTURE SCHEDULE.
 4. REFER TO DRAWING E-602 FOR LIGHT FIXTURE SCHEDULES AND PANEL SCHEDULES.
 5. REFER TO DRAWING E-601 FOR ONE LINE DIAGRAM.
 6. ALL WORK SHALL BE PERFORMED IN ACCORDANCE WITH THE PHASING PLAN. REFER TO PHASING DRAWINGS FOR ADDITIONAL INFORMATION.
 7. DURING ALL PHASES OF CONSTRUCTION, CONTRACTOR SHALL PROVIDE TEMPORARY POWER AND LIGHTING TO ALL AREAS THAT ARE TO REMAIN OPERATIONAL.

KEY PLAN
SCALE: 1/128" = 1'-0"

1
E-107 **ELECTRICAL LIGHTING PLAN - TUNNEL**
SCALE: 3/32" = 1'-0"

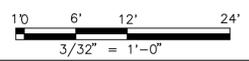


60% SUBMITTAL

CONTRACT NO:		REVISIONS	
PROJECT NO:	DATE:	BY	NO DATE DESCRIPTION
DESIGNED: JER	05/06/16		
DRAFTED: JLH	05/06/16		
CHECKED: QAM	05/06/16		
APPROVED:			



VIRGINIA RAILWAY EXPRESS
**ALEXANDRIA
PEDESTRIAN TUNNEL**

DISCIPLINE: ELECTRICAL LIGHTING PLAN - TUNNEL		DRAWING NO: E-107
SCALE: 3/32" = 1'-0"	DATE ISSUED: 5/25/16	LIST NO:

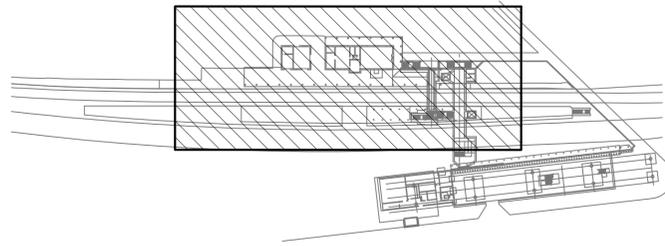



KEY PLAN
SCALE: 1/128" = 1'-0"

KEYED NOTES:

- ① PROVIDE CONDUIT AND WIRING TO AN EMPTY JUNCTION BOX AT SPEAKER LOCATION. SPEAKER PROVIDED AND INSTALLED BY OTHERS. REFER TO RISER DIAGRAM ON DRAWING E-601.
- ② PROVIDE CONDUIT AND WIRING TO AN EMPTY JUNCTION BOX AT CAMERA LOCATION. CAMERA PROVIDED AND INSTALLED BY OTHERS. REFER TO RISER DIAGRAM ON DRAWING E-601.
- ③ PROVIDE CONDUIT AND WIRING TO AN EMPTY JUNCTION BOX AT PID MONITOR LOCATION. PID MONITOR PROVIDED AND INSTALLED BY OTHERS. REFER TO RISER DIAGRAM ON DRAWING E-601.
- ④ RELOCATED TICKET BOOTH. EXTEND AND RECONNECT EXISTING WIRING AND CONDUIT RETAINED DURING DEMOLITION.

NOTES:


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2. REFER TO DRAWING E-001 FOR ELECTRICAL LEGEND, ABBREVIATIONS, AND GENERAL NOTES.
3. REFER TO DRAWING E-601 FOR ONE-LINE DIAGRAM.
5. ALL WORK SHALL BE PERFORMED IN ACCORDANCE WITH THE PHASING PLAN. REFER TO PHASING DRAWINGS FOR ADDITIONAL INFORMATION.
6. DURING ALL PHASES OF CONSTRUCTION, CONTRACTOR SHALL PROVIDE TEMPORARY POWER AND LIGHTING TO ALL AREAS THAT ARE TO REMAIN OPERATIONAL.
7. CAMERAS, PID MONITORS AND PA SYSTEM SPEAKERS ARE FURNISHED AND INSTALLED BY VRE. CONTRACTOR SHALL FURNISH AND INSTALL POWER CIRCUITS TO AN EMPTY JUNCTION BOX AT EQUIPMENT LOCATION AND EMPTY RACEWAYS FOR CONTROL WIRING. CONTRACTOR SHALL COORDINATE EXACT LOCATION AND QUANTITIES WITH VRE.

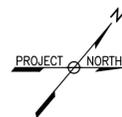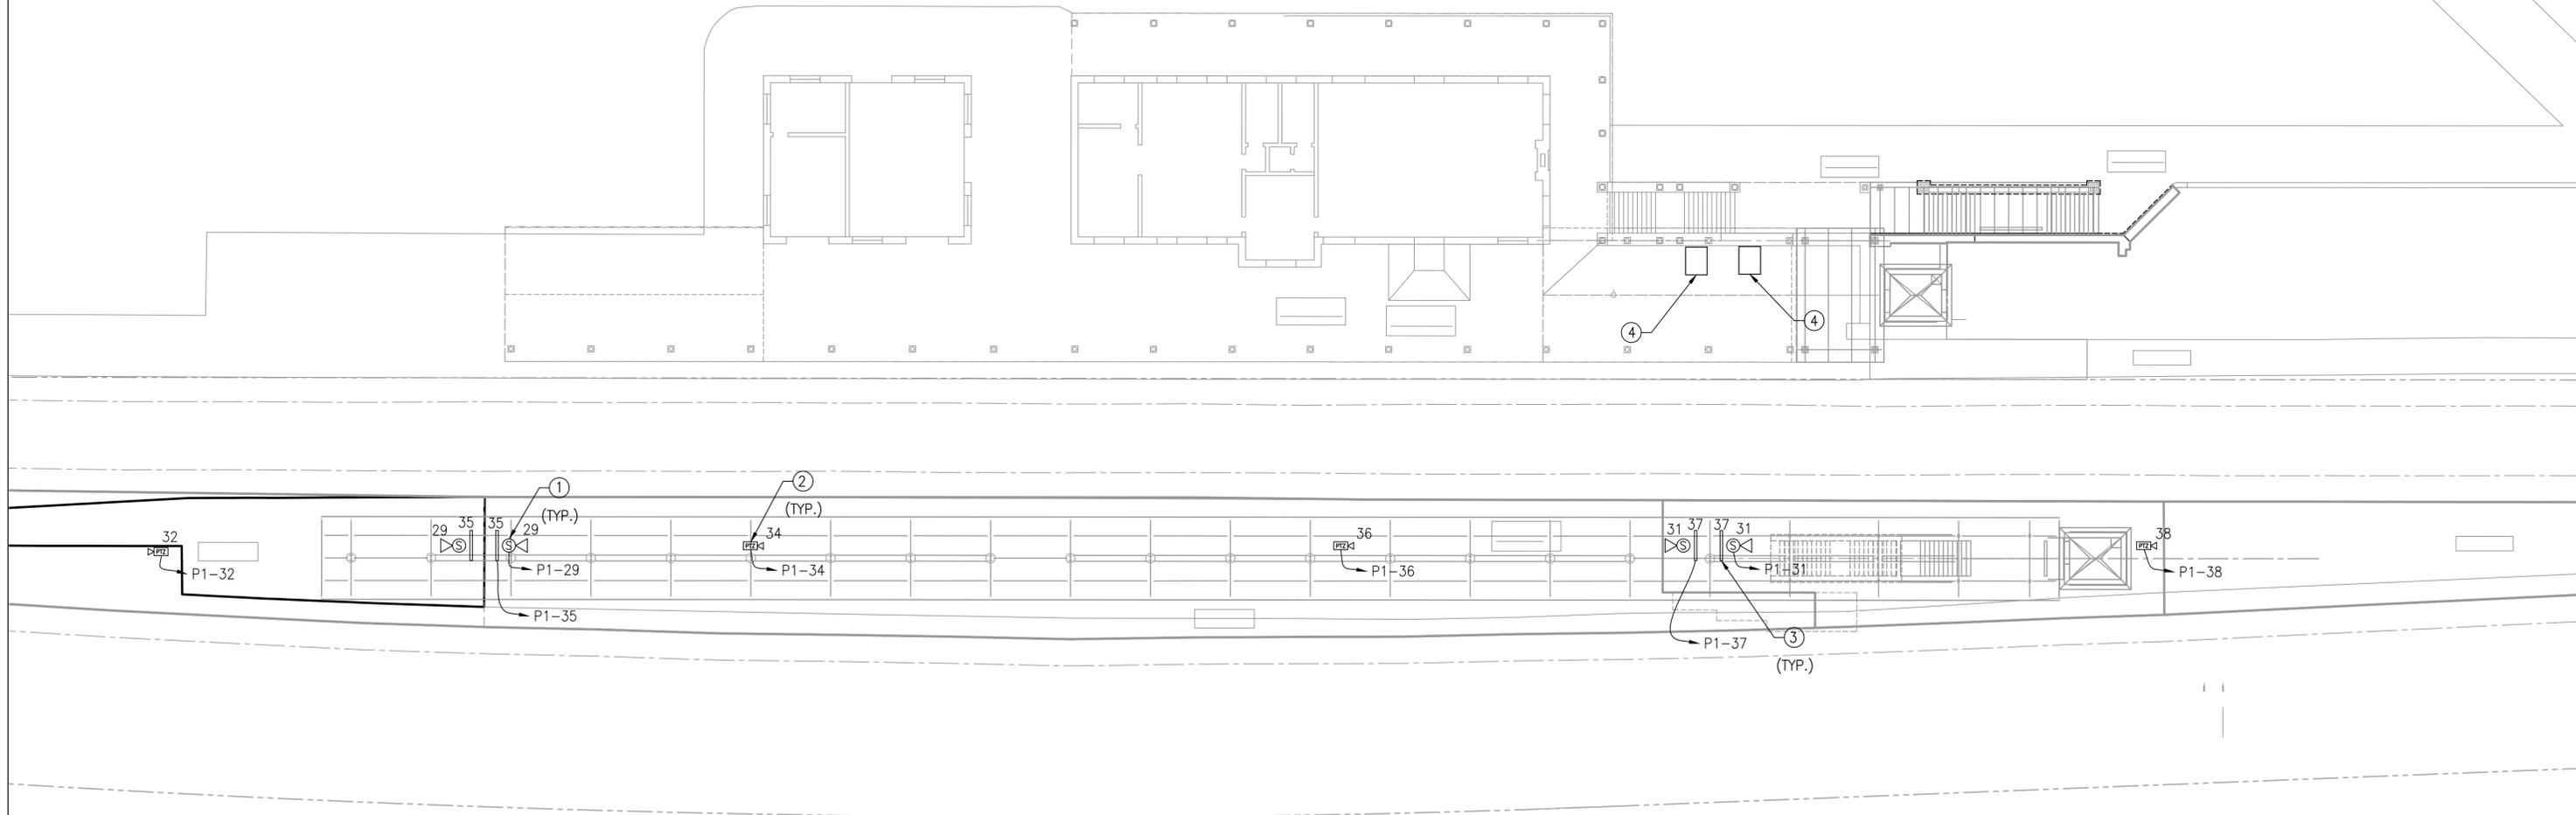

1
E-108

ELECTRICAL SITE PLAN - SPECIAL SYSTEMS

SCALE: 1/16" = 1'-0"

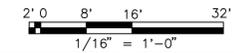

60% SUBMITTAL

CONTRACT NO:		REVISIONS			
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DESIGNED:	JER 05/06/16				
DRAFTED:	JLH 05/06/16				
CHECKED:	QAM 05/06/16				
APPROVED:					



VIRGINIA RAILWAY EXPRESS
ALEXANDRIA
PEDESTRIAN TUNNEL

DISCIPLINE:		DRAWING NO:
ELECTRICAL SITE PLAN - SPECIAL SYSTEMS		E-108
SCALE:	DATE ISSUED:	LIST NO:
1/16" = 1'-0"	5/25/16	